	CHEET MIDEV
	SHEET INDEX
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E0.2	SITE PLAN FRONT DRIVE
E0.3	SITE PLAN WEST PARKING
E0.4	LIGHT POLE DETAILS
E0.5	CANOPY CONDUIT AND SIGN DETAILS
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E5.2	BUILDING	SECTIONS	3			
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E5.4	BUILDING	SECTIONS	5			
E5.5	BUILDING	SECTIONS	6		·	

GENERAL NOTES - APPLICABLE TO ALL SHEETS:

- CIRCUITING IS NOT SHOWN UNLESS IT HAS BEEN FIELD VERIFIED.
- ALL EXISTING DEVICE LOCATIONS ON DRAWINGS WERE FIELD VERIFIED. HOWEVER, SOME EXISTING DEVICES MAY BE CONCEALED AND NOT SHOWN ON DRAWINGS. CONTRACTOR RESPONSIBLE FOR DEMOLITION OF ALL DEVICES (INCLUDING ASSOCIATED ELECTRICAL EQUIPMENT, CONDUIT, AND WIRING BACK TO PANEL) SCHEDULED FOR DEMOLITION. DEMOLITION OF CONCEALED CONDUIT, WIRES, AND DEVICES SHALL BE INCLUDED IN BASE BID SCOPE OF WORK.
- 3. LIGHTING EQUIPMENT TYPE HAS BEEN FIELD VERIFIED.
- ALL WORK IS NEW UNLESS OTHERWISE NOTED.
- ALL WIRING SHALL BE CONCEALED AND ALL DEVICES FLUSH MOUNTED UNLESS NOTED OTHERWISE. WIRING AND DEVICES SHALL BE SURFACE MOUNTED IN MECHANICAL SPACES AND IN THE GYM.
- ALL POWER WIRING SHALL BE CONDUCTORS IN CONDUIT, UNLESS OTHERWISE NOTED.
- ALL LIGHTING WIRING SHALL BE CONDUCTORS IN CONDUIT OR MC
- ALL SIGNAL WIRING SHALL BE CONDUCTORS OR CABLE IN CONDUIT WHERE CONCEALED. SIGNAL CONDUCTORS AND CABLE MAY BE EXPOSED ABOVE SUSPENDED CEILINGS WHERE SUPPORTED BY CABLE TRAY OR CEILING MOUNTED J-HOOKS, UNLESS OTHERWISE NOTED. USE CABLE TRAY DOWN THE CORRIDORS AND J-HOOKS TO SUPPORT CABLE FROM THE CABLE TRAY TO WHERE IT ENTERS CONDUIT. SIGNAL WIRING SHALL BE IN CONDUIT IN MECHANICAL SPACES AND IN THE GYM. ALL SIGNAL DEVISES SHALL BE INSTALLED TO JUNCTION BOXES. FIRE ALARM WIRING SHALL BE IN CONDUIT.
- PROVIDE ALL WIRING IN WIREMOLD 500 RACEWAY AND IN WIREMOLD SURFACE JUNCTION BOXES IN LIBRARY WHERE WIRING CAN NOT BE CONCEALED.
- 10. THE SPACE ABOVE SUSPENDED CEILINGS IS NOT A RETURN AIR PLENUM. PLENUM RATED CABLE IS NOT REQUIRED.

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	<u>LEGE</u>	<u>ND</u>	
		_	
S	SINGLE POLE SWITCH		TEMPERATURE SENSOR
S+	SINGLE POLE SWITCH WITH INDICATOR LIGHT	∇	THERMOSTAT
S ₃	THREE WAY SWITCH	×	STROBE ONLY
(JUNCTION BOX	<u> </u>	PULL STATION
0	LIGHTING UNDER CABINET	⊠⊲	HORN STROBE
CKTS	CIRCUITS	≛	HORN ONLY
~~<	FLEXIBLE CONDUIT	lacksquare2	DATA JACK NUMBER INDICATES QUANTITY IF NOT ONE
-	DUPLEX RECEPTACLE	$lacktriangledown_{E}$	EXISTING DATA JACK
O E	EXISTING DUPLEX RECEPTACLE	lacktriangledown	COMBINATION COMPUTER/TELE
#	DOUBLE DUPLEX RECEPTACLE	∇	TELEPHONE
AFF	ABOVE FINISHED FLOOR	₽-	WALL MOUNT SPEAKER. P INDICATES PAGING SYSTEM. MOUNT AT 105" OR
BLDG	BUILDING		18" BELOW CEILING WHICH EVER IS HIGHER.
GND	GROUND	(M)<	MOTION SENSOR
REC	RECEPTACLE	_	WALL MOUNT OLOOK
TYP	TYPICAL	9	WALL MOUNT CLOCK
w/	WITH	₽	CEILING SPEAKER. P INDICATES PAGING SYSTEM. S INDICATES SOUND SYSTEM.
	HOME RUN	⊸ ⊘⊶	FUSE
_			INTERCOM PUSH-TO-TALK SWITCH
♥	SPECIAL USE RECEPTACLE EXTERIOR WALL MOUNT LUMINAIRE.	B	BELL
' '		\boxtimes	MAGNETIC STARTER
EM_	EXTERIOR CEILING LUMINAIRE		COMBINATION NEMA MAGNETIC STARTER/ DISCONNECT
J/8	LETTER INDICATES TYPE, NUMBER INDICATES LENGTH OF ROW AND "EM" INDICATES EMERGENCY BALLAST	마	DISCONNECT
\otimes	EMERGENCY EXIT SIGN	9	MOTOR CONNECTION
-Ф-Ф-Ф ¬	WIREMOLD PLUG MOLD	□M	MAGNETIC DOOR HOLD OPEN
гФФФ	WIREMOLD RACEWAY WITH DUPLEX OUTLETS	®	SMOKE DETECTOR
		S _M	MANUAL STARTER
	POWER PANEL	S _K	KEY TYPE SWITCH
$\Diamond_{\!\scriptscriptstyle D}$	OCCUPANCY SENSOR CEILING MOUNT DUAL TECHNOLOGY	Sa	SINGLE POLE SWITCH LETTER IDENTIFIES SWITCH WHEN MORE THAN ONE SWITCH IS USED
کیار	SPRINKLER FLOW SWITCH	s° _o	WALL MOUNTED OCCUPANCY SENSOR WITH BUILT IN OVERRIDE SWITCH
$\frac{\lambda}{\Delta}$	SPRINKLER TAMPER SWITCH	$^{\circ}$	HEAT DETECTOR
⊗	AMPRE METER	<u>(@)</u>	DUCT SMOKE DETECTOR
⊗	VOLT METER	Φ	TELEVISION. MOUNT AT 105" OR 18" BELOW CEILING WHICH EVER IS HIGHER.
/	CIRCUITING HATCHES SHOW NUMBER OF CONDUCTORS WHERE MORE THAN 2. EACH LARGE TIC INDICATES A NEUTRAL	4	CAMERA
	CONDUCTOR AND EACH SMALL TIC INDICATES A PHASE CONDUCTOR.	Œ	EXISTING TO REMAIN
	EQUIPMENT GROUND NOT SHOWN BUT IS REQUIRED ON ALL CIRCUITS	∑ ⊗	REMOVE
	THE SHOOTS	<u>s</u>	REMOVE AND SALVAGE
		⟨R⟩	REINSTALL
		···	





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GASTINEAU


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Nov 15, 2010

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RENOVATION
CBJ Contract No. E11-157
JUNEAU, ALASKA

SHEET TITLE:

SITE PLAN
FRONT ENTRY

 \triangleleft

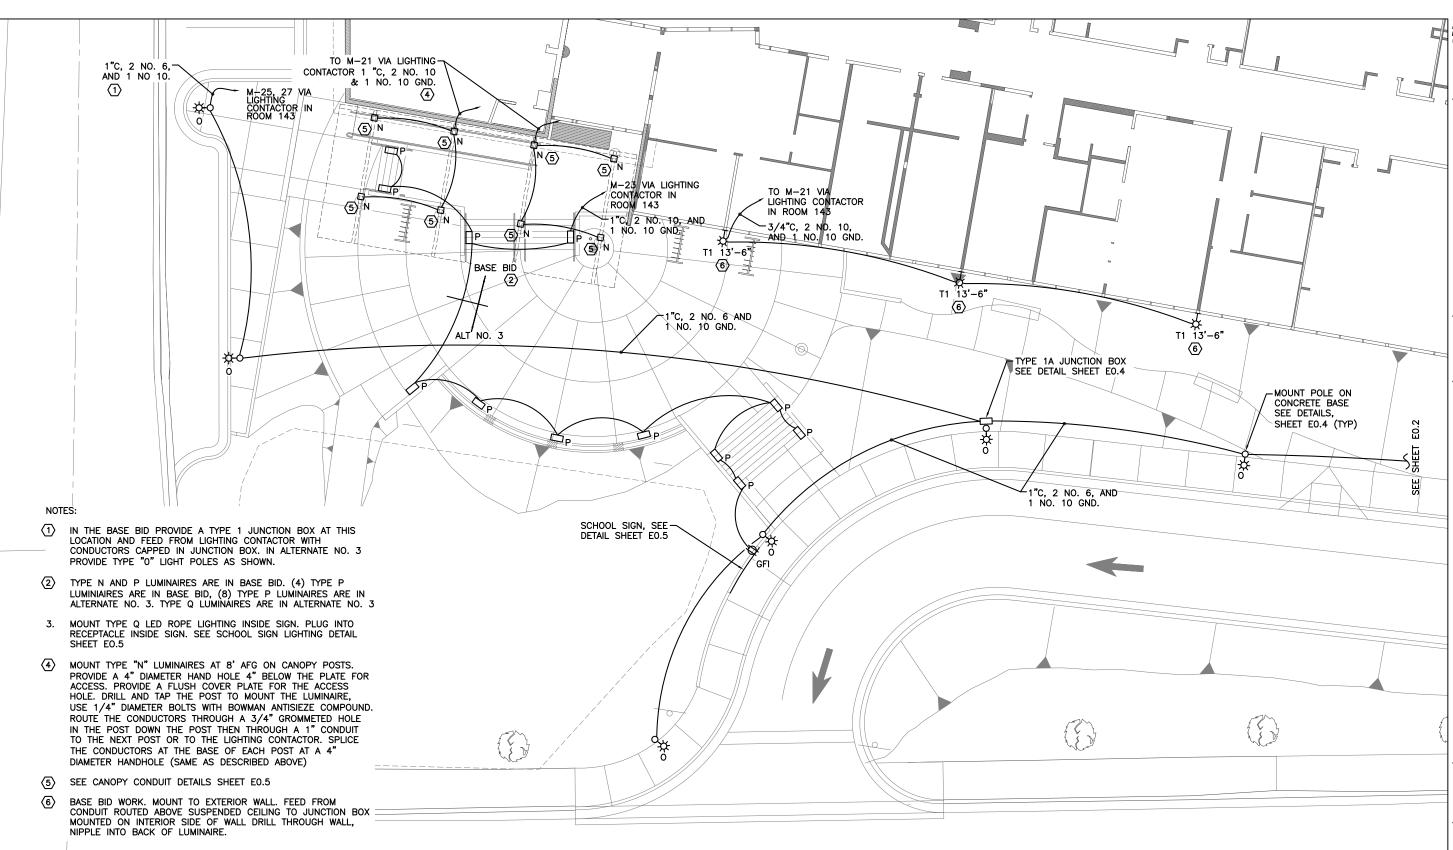DATE: NOV. 15, 2010

REVISION: CHECKED BY:

HECKED BY: MGM RAWN: DMP

EO.1

SITE PLAN - FRONT ENTRY

1/8" = 1'-0" on 22 x 34 1/16" = 1'-0" on 11 x 17



1 ALL WORK ON THIS SHEET IS IN ALTERNATE NO. 3





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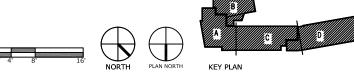
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CBJ Contract No. E11-137
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SHEET TITLE:

SITE PLAN FRONT DRIVE

DATE: NOV. 15, 2010


MGMDMP



1 SITE PLAN - FRONT DRIVE

1/8" = 1'-0" on 22 x 34 1/16" = 1'-0" on 11 x 17

- 1. WORK ON THIS SHEET COVERED IN ALTERNATE NO. 4
- 2. SEE DETAILS SHEET EO.4 FOR TYPE "O" LIGHT POLE MOUNTING.
- 3 MOUNT POLE ON BASE BEHIND RETAINING WALL. SEE DETIAL SHEET E0.5

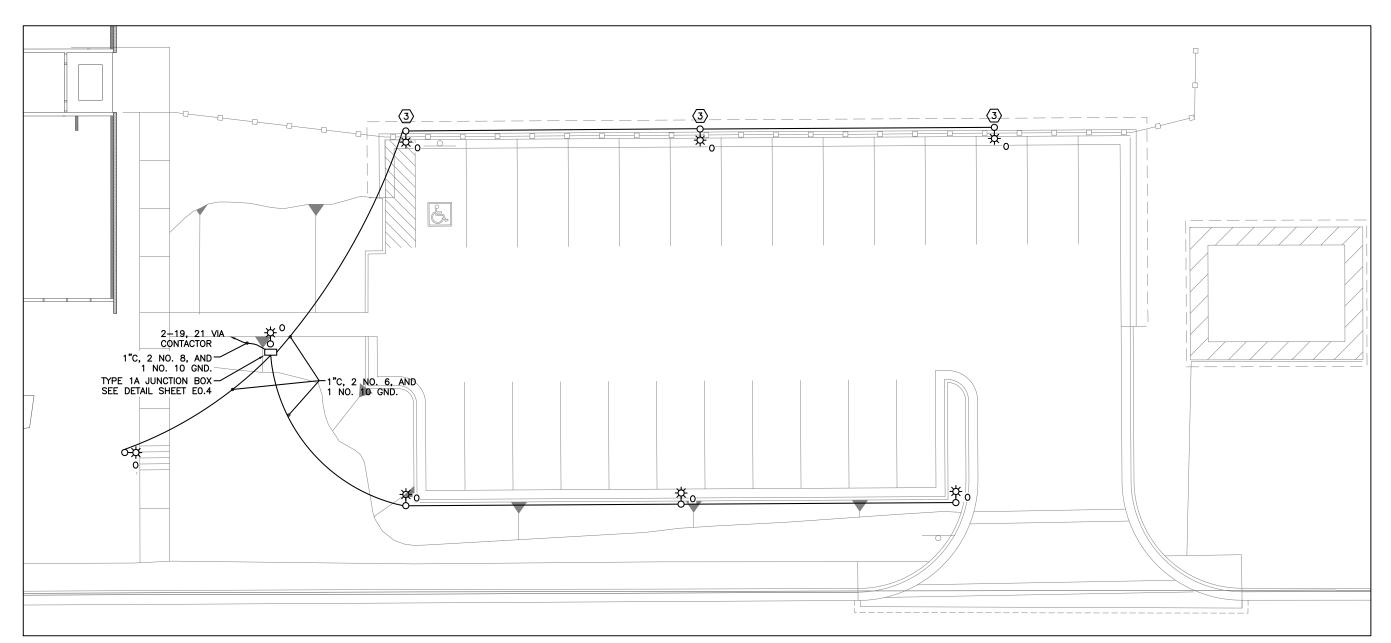





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SHEET TITLE:

SITE PLAN WEST PARKING

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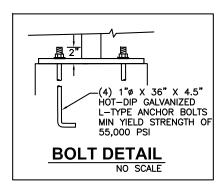
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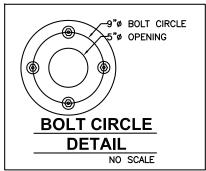
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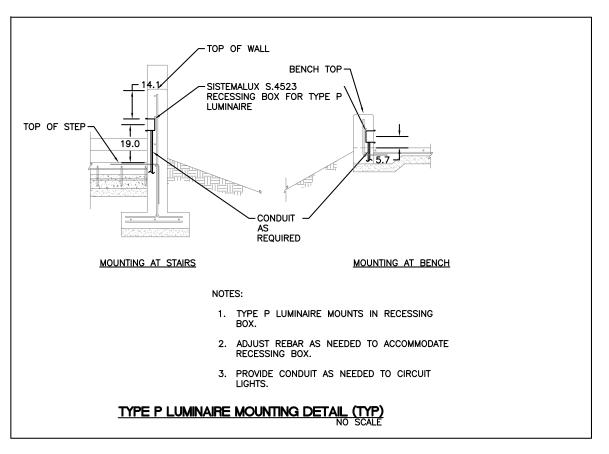
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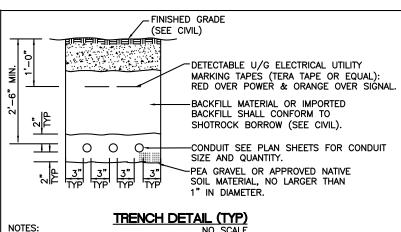














- 1. ALL DIMENSIONS ARE MINIMUM.
- THE LOCATION OF ALL EXISTING PIPING, CONDUIT, ETC MAY NOT BE WHERE SHOWN AND MAY NOT BE SHOWN. ALL LOCATIONS THAT ARE SHOWN ARE APPROXIMATE AND SHOULD BE FIELD VERIFIED. OBTAIN UTILITY LOCATES PRIOR TO DIGGING. DIG WITH CAUTION. AVOID WATER, SEWER, DRAINAGE PIPES AND OTHER CONFLICTS.
- 3. MAINTAIN 12 INCHES MINIMUM SEPARATION (ALL DIRECTIONS) BETWEEN POWER AND OTHER EXISTING CONDUITS, PIPES, ETC.
- CUT & REPLACE EXISTING ASPHALT, CONCRETE, CONCRETE CURB, GUTTER, SIDEWALK, ETC AS NECESSARY.
- ALL TRENCHES SHALL BE 18" WIDE MIN. COMPACT BACKFILL PER CIVIL. TOP
 6" OF MATERIAL PER CIVIL.
- 6. POWER UTILITY CONDUIT SHALL BE BURIED AT A MINIMUM OF 3'.
- 7. MODIFY CONDUIT BURIAL DEPTH WHERE SHOWN ON DRAWINGS.
- 8. MAINTAIN 36" MINIMUM LATERAL SEPARATION FROM WATER AND SEWER LINES. MAINTAIN 12" SEPARATION BETWEEN ELECTRICAL UTILITY CONDUITS.

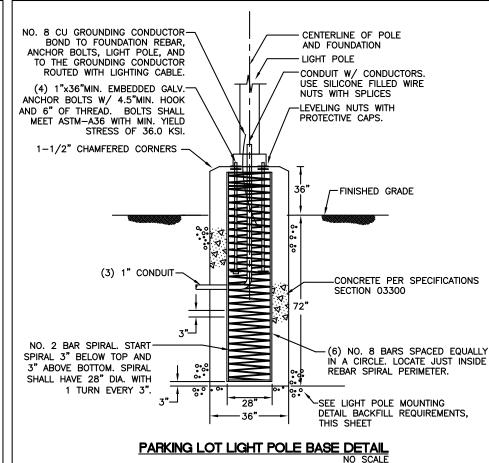

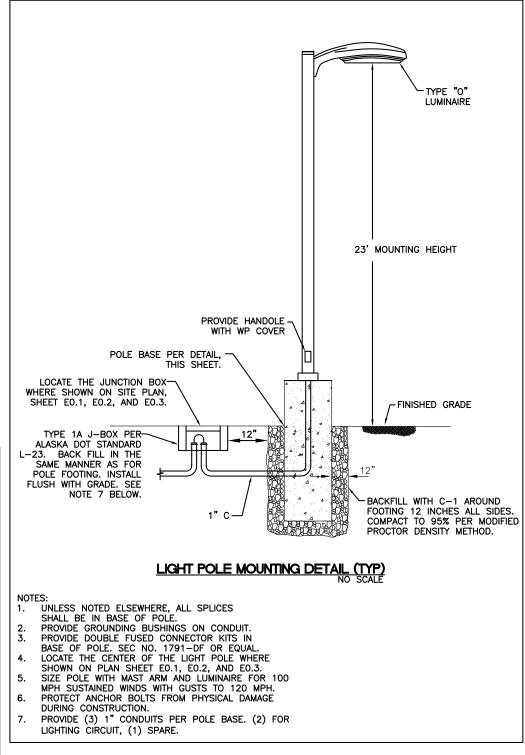





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SHEET TITLE

LIGHT POLE DETAILS

GA

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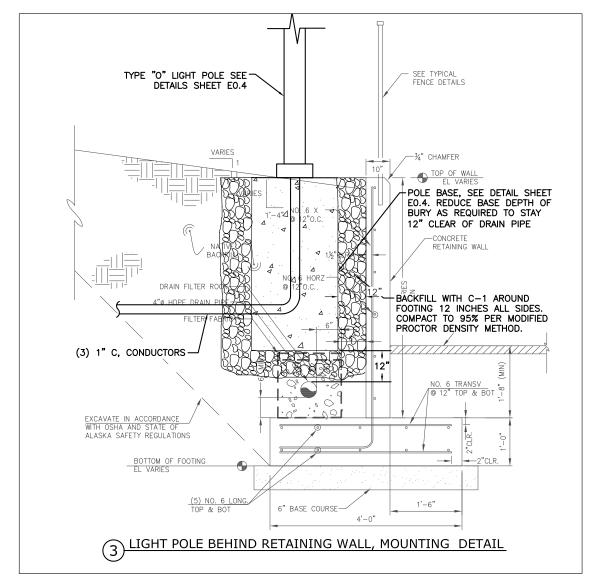
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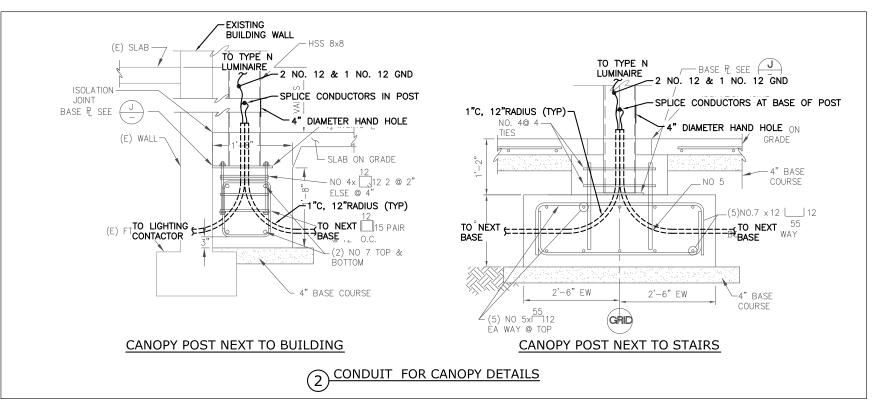
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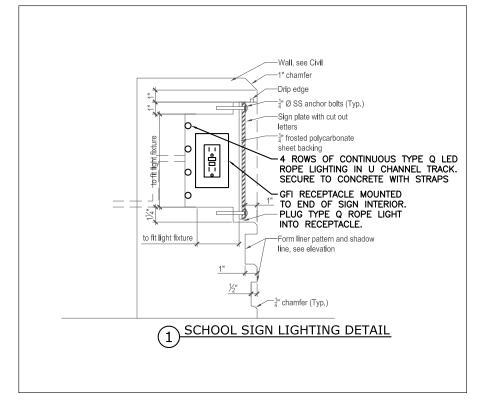
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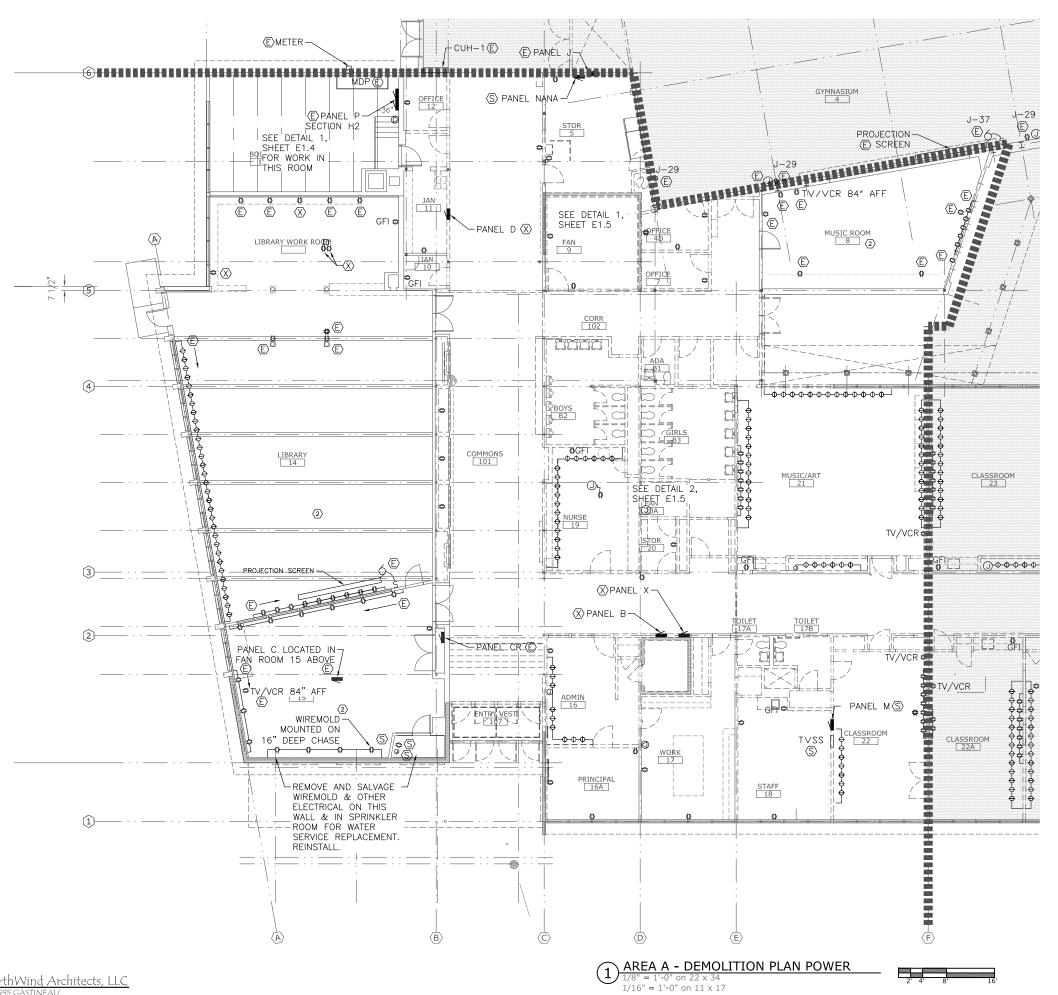
RENOVATION GASTINEAU

CANOPY CONDUIT AND SIGN DETAILS

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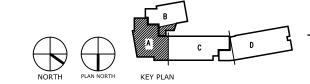
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SHEET TITLE: AREA A DEMO PLAN

POWER

DATE: NOV. 15, 2010

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NOTES:

1. REMOVE ALL ELECTRICAL IN AREA A UNLESS NOTED OTHERWISE.

3. RECEPTACLES IN ROOM 8 ARE ON PANEL J-31

ELECTRICAL IN ROOMS 14, 15, 8, AND LIBRARY WORK ROOM TO REMAIN, UNLESS OTHERWISE NOTED.

- REMOVE ALL ELECTRICAL IN AREA B UNLESS NOTED OTHERWISE.
- ELECTRICAL IN ROOMS 4, 4C, 4B, AND 4A TO REMAIN, UNLESS OTHERWISE NOTED.
- 3 REMOVE RECEPTACLE, CONDUIT, AND WIRING TO PANEL.







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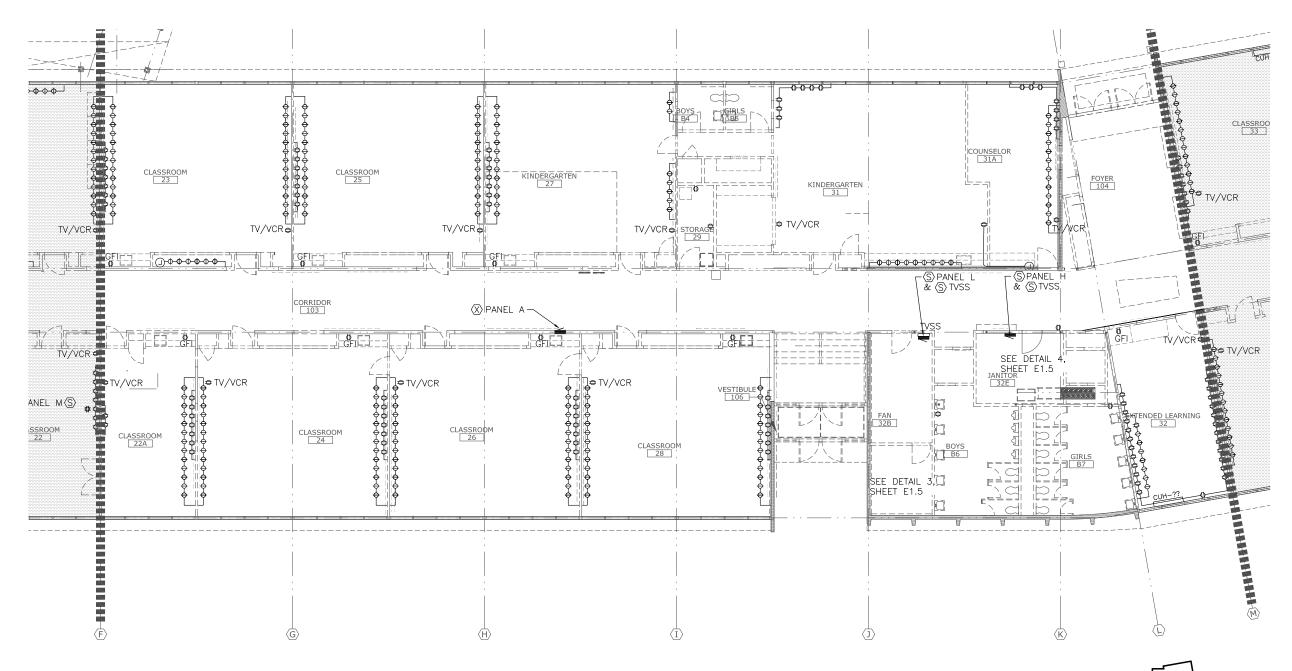
SHEET TITLE: AREA B DEMO PLAN POWER

DATE: NOV. 15, 2010

MGMDMP

AREA B - DEMOLITION PLAN - POWER 1/8" = 1'-0" on 22 x 34 1/16" = 1'-0" on 11 x 17

REMOVE ALL ELECTRICAL IN AREA C UNLESS NOTED OTHERWISE. INCLUDING RECEPTACLES, CONDUIT, WIRING, DEVICES, ETC.









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SHEET TITLE: AREA C DEMO PLAN POWER

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- REMOVE ALL ELECTRICAL IN AREA D UNLESS OTHERWISE NOTED. INCLUDING RECEPTACLES, CONDUIT, WIRING, DEVICES FTC.
- ALL CABINET UNIT HEATERS (CUH-XX) CONTAIN A MOTOR AND MANUAL STARTER. REMOVE TOGETHER WITH ASSOCIATED ELECTRICAL EQUIPMENT, WIRING, AND CONDUIT.







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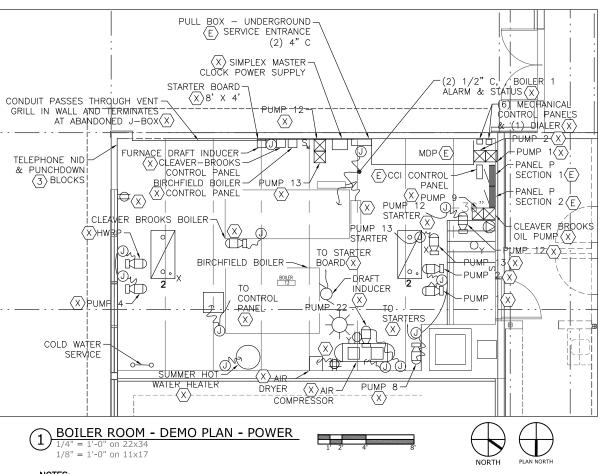
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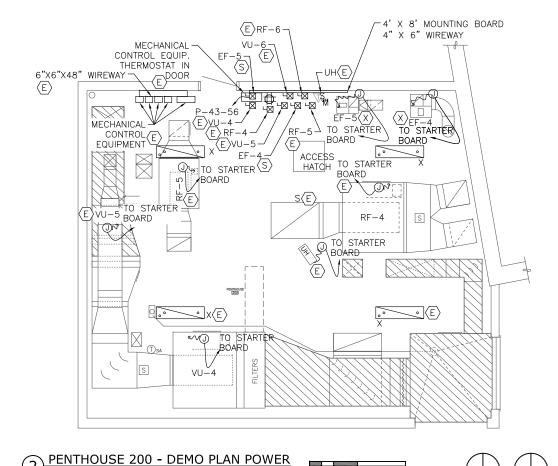
AREA D DEMO PLAN

POWER NOV. 15, 2010

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E1.3






REMOVE MOTOR CONNECTION, AND ASSOCIATED CIRCUITING FOR EF-4 AND EF-5. RETAIN STARTER, CONDUIT AND CONDUCTORS BETWEEN WIREWAY AND PANEL J. RE-USE STARTERS FOR NEW EF-2 AND NEW P-5 SEE SHEET E2.4.

NOTES:

- IN SEASON 1, REMOVE THE ELECTRICAL FOR PUMP 1 AND PUMP 2 AND REPLACE WITH ELECTRICAL FOR P-1A AND P-1B. ALL OTHER DEMO TO
- 2. REMOVE LUMINAIRES AND ASSOCIATED CIRCUITING BACK TO PANEL
- EXISTING TELEPHONE DEMARK TO REMAIN. PROVIDE 25 PAIR CABLE FROM PUNCHDOWN BLOCK TO SERVER ROOM PUNCH DOWN BLOCK AS PART OF

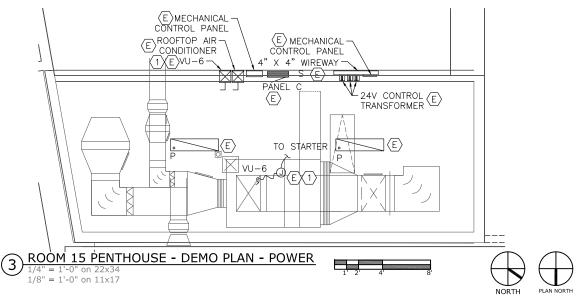

NOTE:

(1) REPLACE THE VU-6 MOTOR AND STARTER WITH A NEW MOTOR AND VFD IN ALTERNATE NO. 6.





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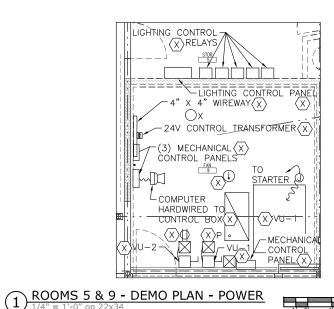
BOILER ROOM, PENT-HOUSE 200 & ROOM 15 DEMO PLAN POWER

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FAN 20A

2) ROOM 20A - DEMO PLAN - POWER

ήφ) MECHANICAL CONTROL PANELS

1/4" = 1'-0" on 22x34 1/8" = 1'-0" on 11x17

-(4) MECHANICAL CONTROL PANELS TO STARTER EF-4(X)

TO STARTER

PANEL H(S)

TO STARTER



(2) ALARM POWER ENCLOSURES(S) (1) ALARM CONTROL ENCLOSURE(S) FAN 30 TO STARTER, JAN TOR 30A X PUMP 11-11 TO STARTER, TO STARTER, JANITOR 30A $\langle X \rangle VU - 3$



TO STARTER JANITOR

PUMP 9(X)

X PUMP 10 XX PUMP 9

MECHANICAL -

CONTROL X PANEL

1/4" = 1'-0" on 22x34 1/8" = 1'-0" on 11x17

4 ROOM 30A - DEMO PLAN - POWER

3 ROOM 30 - DEMO PLAN - POWER

1/4" = 1'-0" on 22x34 1/8" = 1'-0" on 11x17

NOTE:

1. REMOVE ALL ELECTRICAL FROM THESE ROOMS. SALVAGE EQUIPMENT AS SHOWN.









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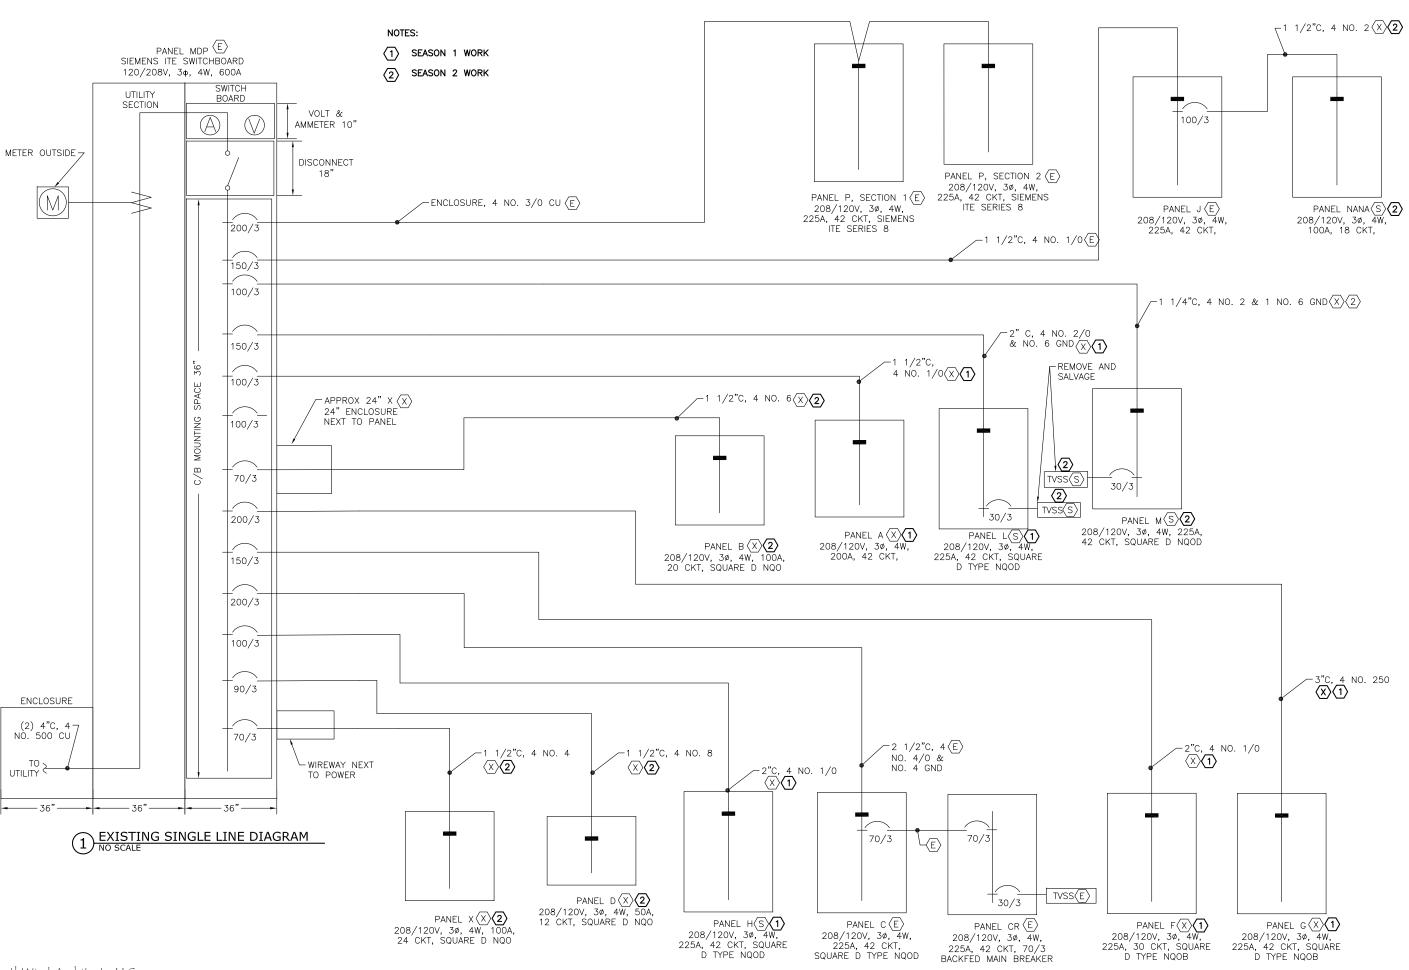
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SHEET TITLE:

ROOMS 5, 9, 20A, 30, & 30A DEMO PLAN POWER

DATE: NOV. 15, 2010



Mark G. Morris
Nov 15, 2010
No. EE 8613



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existing single line diagram

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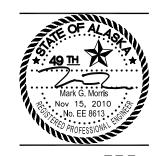
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E1.6

EX	ISTING	MEC	HAN	ICAL E	QUIF	PMENT	r schei	DULE
EQUIPMENT	LOCATION	HP/KW	VOLTS/PH	STARTER TYPE/ NEMA SIZE	STARTER SWITCH	STARTER LOCATION	DISCONNECT AT MOTOR	REMARKS
F-4 FAN(X)	RM 200	FRACTIONAL	120/1	COMBO/O(S)	НОА	RM 200	25/1	
F-5 FAN(X)	RM 200	FRACTIONAL	120/1	COMBO/O(S)	НОА	RM. 200	25/1	
RF-4 FAN(E)	RM 200	2HP	208/3	COMBO/0	HOA	RM 200	25/3	
RF-5 FAN(E)	RM 200	FRACTIONAL	120/1	COMBO/0	HOA	RM 200	25/1	
/U-4 FAN(E)	RM 200		208/3	COMBO/1	HOA	RM 200	30/3	
U-5 FAN(E)	RM 200		208/3	COMBO/0	HOA	RM 200	10/3	
JNIT HEATER(E)	RM 200		120/1	·			·	
/U−1 FAN ⟨X⟩	RM 9	2HP	208/3	MAG/1		AT UNIT	MANUAL	
$F-2\langle X \rangle$	RM 20A		120/1	MAG/1HP		AT UNIT	20/1	
$RF-1\langle X\rangle$	RM 20A		208/1	MAG/0		AT UNIT	,	
/U-3 FAN(X)	RM 30		208/3	MAG/0		RM 30A		
PUMP $11\langle X \rangle$	RM 30		120/1	MAG		RM 30A		
F-4 (x)	RM 30A	1-1/2HP	208/3	MAG		RM 30A		
$F-5\langle \chi \rangle$	RM 30A		120/1	MANUAL		RM 30A		
$RF-3\langle X \rangle$	RM 30A					RM 30A		
PUMP 9(X)	RM 30A		120/1	MAG/1	НОА	RM 30A		
PUMP $10\langle \chi \rangle$	RM 30A		120/1	MAG/0		RM 30A		
AIR DRYER X	BOILER ROOM			•				
AIR COMPRÉSSOR(X)	BOILER ROOM		208/3					
BOILER (BIRCH)(X)	BOILER ROOM		208/3					
SOILER (CB)(X)	BOILER ROOM		208/3					
RAFT INDUCER(X)	BOILER ROOM		208/1					
HOT WTR HTR(X)	BOILER ROOM		208/1	NONE			NONE	
IWRP(X)	BOILER ROOM	FRACTIONAL	120/1					
PUMP 1 (X)	BOILER ROOM	1600W	208/3	MAG/0		AT UNIT	NONE	
PUMP 2 (X)	BOILER ROOM	810W	208/3	MAG/0		AT UNIT	NONE	
PUMP 4 (X)	BOILER ROOM	FRACTIONAL	120/1					
PUMP 8 X	BOILER ROOM		208/3					
PUMP $12\langle X \rangle$	BOILER ROOM		120/1	MAG/0		AT UNIT	NONE	
PUMP $13\langle \chi \rangle$	BOILER ROOM		120/1	MAG/0		AT UNIT	NONE	
PUMP 22 X	BOILER ROOM	3/4	120/1					
VU−6 FAN(E)	LIB. PENTHOUSE		208/3	MAG/1	HOA	AT UNIT	NONE	
AIR CONDITIONER(E)	ROOFTOP		208/3	MAG/3				





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SCHOOL GASTINEAU ELEMENTARY

RENOVATION
CBJ Contract No. E11-137
JUNEAU, ALASKA

SHEET TITLE:

existing Mechanical Equip. schedule

DATE: NOV. 15, 2010

MGM

DMP

REVISION:

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MECHANICAL EQUIPMENT SCHEDULE
NO SCALE

ſ		SIZE	VC	DLTS, P	HASE	MOU	NTING	MAIN	LOCATION	
İ	PANEL MDP extg	600A	120/	′208V,	3φ, 4W				BOILER ROOM	
CKT	DESCRIPTION	C/B SIZE			KVA			C/B SIZE	DESCRIPTION	СКТ
NO	DESCRIPTION	C/ D SIZE	CKT	Аф	Вф	Сф	CKT	10/10 3121	DESCRIPTION	NO
1	PANEL P (E)	200/3						200/3	PANEL G X	2
3										4
5										6
7	PANEL J (E)	150/3						150/3	PANEL F (X)	8
9										10
11										12
13	PANEL M (S)	100/3						200/3	PANEL C (E)	14
15										16
17										18
19	PANEL L (S)	150/3							SPACE	20
21									SPACE	22
23									SPACE	24
25	PANEL A X	100/3						100/3	PANEL H (S)	26
27										28
29										30
31	SPARE	100/3						90/3	PANEL D X	32
33										34
35										36
37	PANEL B X	70/3						70/3	PANEL X X	38
39										40
41										42

		SIZE	VOI	_TS, PH	HASE	IUOM	NTING	MAIN	LOCATION	
PAN	EL P SECTION 1 EXTG	225A	120	/208V` 4W	Υ 3φ,	SUR	FACE	LUGS	BOILER ROOM	
CKT NO	DESCRIPTION	C/B			KVA			C/B	DESCRIPTION	CKT
CKI NO	DESCRIPTION	SÍZE	CKT	Аф	Вф	Сф	CKT	SiZE	DESCRIPTION	NO
1	CLEAVER BROOKS BOILER (X)	40/3	0.0				0.0	15/1	P-1 (X)	2
3			0.0				0.0	15/1	P-2 CONTACTOR (X)	4
5			0.0				0.0	15/1	P-22 (X)	6
7	BIRCH FIELD BOILER (X)	20/3	0.0				0.0	20/1	REC. BEHIND AIR COMPRESSOR $\langle X \rangle$	8
9			0.0				0.0	15/1	P-4 (X)	10
11			0.0				0.0	20/1	CONTROL - BIRCH FIELD BOILER (X)	12
13	CONTROL - CLEAVER BROOKS BLR X	20/1	0.0				0.0	20/2	FAN ROOM 9, $VU-2\langle X \rangle$	14
15	P-12 (X)	20/1	0.0				0.0			16
17	$P-13$ $\langle X \rangle$	20/1	0.0				0.0		SPACE	18
19	DRAFT INDUCER - BIRCHFIELD BLR X	20/2	0.0				0.0	20/2	FAN ROOM 20A, RF-1 $\langle X \rangle$	20
21			0.0				0.0			22
23	CCI COMPUTER CONTROL (E)	20/1	0.0				0.0	20/1	FAN ROOM 20A, EF−2 ⟨X⟩	24
25	SPARE	15/3	0.0				0.0	15/3	FAN ROOM 9, $VU-1\langle X\rangle$	26
27			0.0				0.0			28
29			0.0				0.0			30
31	SPACE		0.0				0.0	20/3	MASTER CLOCK SIMPLEX BOILER (X)	32
33	$P-6$ $\langle X \rangle$	15/1	0.0				0.0			34
35	SPACE		0.0				0.0			36
37	AIR COMPRESSORS NO. 12 X	20/3	0.0				0.0	20/1	MASTER CLOCK OFFICE X	38
39			0.0				0.0	30/2	HOT WATER TANK $\langle X \rangle$	40
41			0.0				0.0			42
	-									

SIZE	1 401	_TS, Ph	HASE	MOU	NTING	MAIN	LOCATION	
EXTG 225A	120	/208V 4W	ΥЗφ,	SUR	FACE	LUGS	BOILER ROOM	
C/B SIZE	CKT	Аф	KVA Bø	Сф	СКТ	C/B SIZE	DESCRIPTION	CKT NO
15/3	0.0				0.0	20/3	$RF-4\langle E\rangle$	44
	0.0				0.0			46
	0.0				0.0			48
15/3	0.0				0.0	20/1	RF−5 ⟨E⟩	50
	0.0				0.0	20/1	RF-6 (E)	52
	0.0				0.0	20/1	EF-4 X	54
14 (E) 20/1	0.0				0.0	20/1	EF-5 $\langle X \rangle$	56
) 15/1	0.0				0.0	20/1	UH FAN ROOM (E)	58
15/1	0.0				0.0	20/1	LGT FAN ROOM 200(E)	60
15/3	0.0				0.0	20/1	2 DUPLEX REC FOR 200(E)	62
	0.0				0.0	20/1	SPARE	64
	0.0				0.0	20/1	SPARE	66
15/3	0.0				0.0	20/2	PARKING LOT LIGHTS (E)	68
	0.0				0.0			70
	0.0				0.0		SPACE	72
15/3	0.0				0.0		SPACE	74
	0.0				0.0		SPACE	76
	0.0				0.0		SPACE	78
15/3	0.0				0.0	20/3	SPARE	80
	0.0				0.0			82
	0.0				0.0			84
		0.0	0.0	0.0	0.0	0.0 0.0	0.0 0.0	0.0 0.0





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GASTINEAU ELEMENTARY SCHOOL

RENOVATION
CBJ Contract No. E11-137
JUNEAU, ALASKA

PANEL SCHEDULES EXISTING BOILER ROOM

DATE: NOV. 15, 2010 REVISION:

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		SIZE	VOI	_TS, PI	HASE	MOUI	NTING	MAIN	LOCATION	
	PANEL C EXTG	225A	225A 120/208V, 3ф, 4W		SURFACE		200/3	PENTHOUSE ABOVE RM 15		
CKT	DESCRIPTION	C/B			KVA			C/B	DESCRIPTION	СКТ
NO	DESCRIPTION	SÍZE	CKT	Аф	Вф	Сф	CKT	SÍZE	DESCRIPTION	NO
1	ROOF TOP AC FOR LIBRARY	125/3						20/1	UNKNOWN	2
3								20/1	UNKNOWN	4
5								20/1	UNKNOWN	6
7								20/1	UNKNOWN	8
9								20/1	UNKNOWN	10
11								20/1	UNKNOWN	12
13	VU-6	50/3						20/1	UNKNOWN	14
15								20/1	UNKNOWN	16
17								20/1	UNKNOWN	18
19	UNKNOWN	20/1						20/1	UNKNOWN	20
21	UNKNOWN	20/1						70/3	PANEL CR	22
23	UNKNOWN	20/1								24
25	PLUG MOLD LIBRARY	20/1								26
27	PLUG MOLD LIBRARY	20/1							SPACE	28
29	SPACE								SPACE	30
31	SPACE								SPACE	32
33	SPACE								SPACE	34
35	SPACE								SPACE	36
37	SPACE								SPACE	38
39	SPACE								SPACE	40
41	SPACE								SPACE	42

)	A N I E I O D	SIZE	VOI	_TS, PI	HASE	MOU	NTING	MAI	Ν	LOCATION	
Ρ,	ANEL CR EXTG	225A	120	/208V 4W	, Зф,	FLI	JSH	LUG	SS	R□□M 15	
CKT NO	DESCRIPTION	C/B SIZE	СКТ	KVA C C/B AΦ BΦ CΦ CKT SIZE DESCRIPTION		DESCRIPTION	CKT NO				
1	21,22	20/1						20/1	L 1	,2	2
3	17-27	20/1						20/1	L 3	i -6	4
5	15,16	20/1						20/1	L 7	-10	6
7	9,10,23,24	20/1						20/1	PRII	NTER	8
9	11-14	20/1						20/1	VAC	P SERV	10
11	1-4	20/1						20/1	DES	SK .	12
13	5,8	20/1						20/1	SER	?V	14
15	25,26,29,30	20/1							SPA	ACE .	16
17	27,28	20/1							SPA	ACE .	18
19	TV	20/1							SPA	ACE .	20
21	FLOOR REC LIBRARY	20/1							SPA	ACE .	22
23	2								SPA	ACE .	24
25	SPACE								SPA	ACE	26
27	SPACE								SPA	ACE	28
29	SPACE								SPA	ACE .	30
31	SPACE								SPA	ACE	32
33	SPACE								SPA	ACE	34
35	SPACE								SPA	CE	36
37	SPACE							30/3	TVS	S	38
39	SPACE								-		40
41	SPACE										42

		SIZE	VO	LTS, P	HASE	MOU	NTING	MAIN	LOCATION	
	PANEL J extg	225A	120)/208V 4W	, Зф,	FLI	JSH	LUGS	GYMNASIUM	
CKT NO	DESCRIPTION	C/B			KVA				DESCRIPTION	СКТ
CRT NO	DESCRIPTION	SIZE	CKT	Аф	Вф	Сф	CKT	SIZE	DESCRIPTION	NO
1	PANEL NANA ROOM 5	100/3						20/1	KITCHEN LIGHTING, STORAGE 103, 104	2
3								20/1	CORRIDOR 105, ENTRY	4
5								20/1	MULTIPURPOSE ROOM	6
7	REFRIGERATOR	20/1						20/1	MULTIPURPOSE ROOM	8
9	MILK COOLER	20/1						20/2	MULTIPURPOSE ROOM	10
11	KITCHEN COUNTER (GFI)	20/1								12
13	KITCHEN COUNTER (GFI)	20/1						20/1	COVERED PLAY AREA	14
15	UNKNOWN	20/1						20/1	COVERED PLAY AREA	16
17	STORAGE 103, 104, JAN OFF, EXT	20/1						20/1	COVERED PLAY AREA	18
19	CORRIDOR 109, STORAGE	20/1						20/1	PLAY AREA FLOOD LIGHTS	20
21	FREEZER #5	20/1						20/1	RM. 110, 119, ALCOVE ABOVE RM 120	22
23	HOT WATER HEATER	20/1						20/1	CORRIDOR 109	24
25		30/2						20/1	CORRIDOR 112, 118	26
27	OFFICE 120, STORAGE 119							20/1	JANITOR OFFICE & STORAGE	28
29	MULTIPURPOSE ROOM	20/1						20/1	COMPUTER ROOM #1	30
31	MUSIC ROOM (ALT)	20/1						20/1	EXTERIOR WEST & NORTH	32
33	STORAGE 122, 123, 124 (ALT)	20/1						20/1	EXTERIOR EAST	34
35	COVERED PLAY AREA (GFI)	20/1						20/1		36
37	PROJECTION	20/1						20/1	MUSIC ROOM (ALT)	38
39	UNKNOWN	20/1						20/1	STORAGE 122, 123, 124 (ALT)	40
41	REFRIGERATOR	20/1							SPACE	42

_		SIZE	VC	LTS, PI	HASE	MOUN	ITING	IIAM	LOCATION	
-	PANEL NANA extg	100A	120	0/208V 4W	, Зф,	SURF	FACE	200/	′3 ROOM 5	
CKT NO	DESCRIPTION	C/B SIZE	СКТ	Аф	KVA Βφ	Сф	СКТ	C/B SIZE	DESCRIPTION	CKT NO
1	TOP RECEPTACLE NANA OVEN	50/3			54		OIXI		SPACE	2
3									SPACE	4
5									SPACE	6
7	BOTTOM RECEPTACLE NANA OVEN	50/3							SPACE	8
9									SPACE	10
11									SPACE	12
13	NANA STEAM TABLE RECEPTACLE	30/2							SPACE	14
15									SPACE	16
17	SPACE								SPACE	18





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GASTINEAU ELEMENTARY SCHOOL RENOVATION CBJ Contract NO. E11-137 JUNEAU, ALASKA

SHEET TITLE:

PANEL SCHEDULES EXISTING C, CR, J, & NANA

DATE: NOV. 15, 2010

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PANEL SCHEDULES
NO SCALE

		SIZE	VC	LTS, PI	HASE	MOUN	NTING	MAIN	LOCATION	
	PANEL M EXTG	225A	120/	'208V,	3φ, 4W	FLUSH		LUGS	STAFF LOUNGE RM, 18	
CKT NO	DESCRIPTION	C/B SIZE	CKT	Аф	KVA Bø	Сф	CKT	C/B SIZE	DESCRIPTION	CKT NO
1	ROOM 24 COMPUTERS	20/1						20/1	ROOM 21 COMPUTERS	2
3	ROOM 24 PRINTER/TV/VCR/PROJEC	20/1						20/1	ROOM 21 PRINTER/TV/VCR/PROJEC	4
5	ROOM 22A COMPUTERS	20/1						20/1	MUSIC 8 COMPUTER/TV/VCR/PROJEC	6
7	ROOM 22A PRINTER/TV/VCR/PROJEC	20/1						20/1	MUSIC 8 PRINTER/COMPUTERS	8
9	ROOM 22 COMPUTERS	20/1						20/1	LIBRARY CIRC. DESK	10
11	ROOM 22 PRINTER/TV/VCR/PROJEC	20/1						20/1	SPARE	12
13	ROOM 23 PRINTER/TV/VCR/PROJEC	20/1						20/1	SPARE	14
15	ROOM 23 COMPUTERS	20/1						20/1	SPARE	16
17	SPARE	20/1							SPACE	18
19	SPARE	20/1							SPACE	20
21	SPARE	20/1							SPACE	22
23	SPARE	20/1							SPACE	24
25	SPARE	20/1							SPACE	26
27	SPARE	20/1							SPACE	28
29	SPARE	20/1							SPACE	30
31	SPARE	20/1							SPACE	32
33	SPARE	20/1							SPACE	34
35	SPARE	20/1							SPACE	36
37	SPACE							30/3	TVSS	38
39	SPACE									40
41	SPACE									42

PANEL H EXTG		SIZE	SIZE VOLTS, PHASE			MOUNTING		MAIN	LOCATION	
		225A	120)/208V, 4W	Зφ,	SURFACE		LUGS	JANITOR 30A	
CKT NO	DESCRIPTION	C/B		•	KVA			C/B	DESCRIPTION	CKT
		SÍZE	CKT	Аф	Вф	Сф	CKT	SiZE	DESCRIP HON	NO
1	SPARE	20/1						20/3	VENTILATING UNITS 3	2
3	EXHAUST FAN #5	20/1								4
5	EMCS SYSTEM	20/1								6
7	EXHAUST FAN #4	20/3						20/1	EMCS SYSTEM	8
9								20/3	CIRC PUMP 11	10
11										12
13	CF-02 NEW FAN	15/3								14
15		Ī						20/1	SPARE	16
17								20/1	SPARE	18
19	PUMP 10	15/1						20/1	SPARE	20
21	PUMP 9	15/1						20/1	FIRE ALARM HORN	22
23	SPARE	20/1						20/1	SPARE	24
25	OUTSIDE BACK EM LIGHTS	20/1						20/1	SPARE	26
27	OUTSIDE BACK EM LIGHTS	20/1						20/1	SPARE	28
29	OUTSIDE BACK EM LIGHTS	20/1						20/1	SPARE	30
31	SPARE	20/1						15/1	38 CUH-1	32
33	SPARE	20/1						15/1	37 CUH-1	34
35	CLASSROOM 34, CU H-1	15/1						15/1	40 CUH-1	36
37	CLASSROOM 33	15/1						15/1	39 CUH-1	38
39	CLASSROOM 36	15/1						15/1	41 CUH-1	40
41	CLASSROOM 35	15/1						15/1	42 CUH-1	42
										<u> </u>

PANEL L EXTG		SIZE	SIZE VOLTS, PHASE				MOUNTING		LOCATION		
		225A	120/208V, Зф, 4W			SURFACE		LUGS	STORAGE 30		
CKT NO DESCRIPTION		C/B SIZE	CKT	Аф	KVA Bø	Сф	CKT	C/B SIZE	DESCRIPTION		
1	ROOM 42 COMPUTERS	20/1						20/1	ROOM 41 PRINTER/TV/VCR/PROJEC	2	
3	ROOM 42 PRINTER/TV/VCR/PROJEC	20/1						20/1	ROOM 41 COMPUTERS	4	
5	ROOM 40 COMPUTERS	20/1						20/1	ROOM 39 PRINTER/TV/VCR/PROJEC	6	
7	ROOM 40 PRINTER/TV/VCR/PROJEC	20/1						20/1	ROOM 39 COMPUTERS	8	
9	ROOM 38 COMPUTERS	20/1						20/1	ROOM 37 PRINTER/TV/VCR/PROJEC	10	
11	ROOM 38 PRINTER/TV/VCR/PROJEC	20/1						20/1	ROOM 37 COMPUTERS	12	
13	ROOM 36 COMPUTERS	20/1						20/1	ROOM 35 COMPUTERS/PROJEC	14	
15	ROOM 36 PRINTER/TV/VCR/PROJEC	20/1						20/1	ROOM 35 PRINTER/TV/VCR/PROJEC	16	
17	ROOM 34 COMPUTERS	20/1						20/1	ROOM 33 PRINTER/TV/VCR/PROJEC	18	
19	ROOM 34 PRINTER/TV/VCR/PROJEC	20/1						20/1	ROOM 33 COMPUTERS	20	
21	TYPING LAB 32 COMPUTERS	20/1						20/1	ROOM 31 PRINTER/TV/VCR/PROJEC	22	
23	TYPING LAB 32 COMPUTERS	20/1						20/1	ROOM 31 COMPUTERS	24	
25	TYPING LAB 32 COMPUTERS	20/1						20/1	ROOM 29 PRINTER/TV/VCR/PROJEC	26	
27	TYPING LAB 32 COMPUTERS	20/1						20/1	ROOM 29 COMPUTERS	28	
29	TYPING LAB 32 COMPUTERS	20/1						20/1	ROOM 27 PRINTER/TV/VCR/PROJEC	30	
31	TYPING LAB 32 PRINTER/TV/VCR/COM	20/1						20/1	ROOM 27 COMPUTERS	32	
33	TYPING LAB 32 COMPUTERS	20/1						20/1	ROOM 25 PRINTER/TV/VCR/PROJEC	34	
35	ROOM 28 COMPUTERS	20/1						20/1	ROOM 25 COMPUTERS	36	
37	ROOM 28 PRINTER/TV/VCR/PROJEC	20/1						30/3	TVSS	38	
39	ROOM 26 COMPUTERS	20/1								40	
41	ROOM 26 PRINTER/TV/VCR/PROJEC	20/1								42	

1. REMOVE ALL CIRCUITS TO PANELS M, L, AND H.





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GASTINEAU ELEMENTARY SCHOOL RENOVATION

RENOVATION
CBJ Contract No. E11-137
JUNEAU, ALASKA

SHEET TITLE:

PANEL SCHEDULES EXISTING M, H, & L

DATE: NOV. 15, 2010

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IF THE ABOVE DIMENSION DOES NOT HAS BEEN ENLARGED OR REDUCED,

2 EXISTING LIGHTING TO REMAIN.

DEVICES, ETC.

NOTES:

REMOVE AND SALVAGE LUMINAIRES IN LIBRARY WORK ROOM, REINSTALL LUMINAIRES IN READING ROOM 148B AND LIBRARY WORK ROOM 148A. REMOVE EXISTING SWITCHING AND CIRCUITING. SEE SHEET E3.0.

REMOVE ALL ELECTRICAL IN AREA A UNLESS NOTED

OTHERWISE, INCLUDING LIGHTS, SWITCHES, CONDUIT,

- REMOVE LUMINAIRE, RETAIN WIRING.
- REMOVE, SALVAGE, AND REINSTALL LUMINAIRES. SEE SHEET E3.1. REMOVE WIRING AND CONDUIT. PATCH AND PAINT TO MATCH SURFACES WHERE EQUIPMENT WAS INSTALLED.
- REMOVE LIGHTING RELAYS AND LIGHTING CONTROL PANEL. PROVIDE JUNCTION BOXES ON CEILING. RE-ROUTE EXISTING LIGHTING CIRCUITS FED BY RELAYS INTO JUNCTION BOXES. REFEED THE EXISTING LIGHTING CIRCUITS. PROVIDE NEW WIRING FROM THESE JUNCTION BOXES TO NEW LIGHTING CONTACTORS. PROVIDE NEW CONDUIT AND CONDUCTORS FROM CONTACTORS TO THE PANEL FEEDING THEM. SEE LIGHTING SCHEMATICS SHEETS E3.5 - E3.8.

EQUAL EXACTLY I", THIS DRAWING AFFECTING ALL LABELED SCALES

SCHOOL ELEMENTARY

RENOVATION
CBJ Contract No. E11-157
JUNEAU, ALASKA

SHEET TITLE: AREA A

STINEAU

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DEMO PLAN LIGHTING


DATE: NOV. 15, 2010

CHÉCKÉD BY

MGMDMP DRAWN:

AREA A - DEMO PLAN LIGHTING 1/16" = 1'-0" on 11×17


- REMOVE ALL ELECTRICAL IN AREA B UNLESS NOTED OTHERWISE. INCLUDING LIGHTS, SWITCHES CONDUIT, DEVISES, ETC.
- 2 EXISTING LIGHTING TO REMAIN
- \bigcirc NOT USED
- REMOVE LUMINAIRE, RETAIN CONDUCTORS
- 5 NOT USED
- REPLACE TYPE D LUMINAIRES IN GYM UNDER ALTERNATE NO 5. LIGHTING TO REMAIN IN BASE BID. REPLACE SWITCHING AS SHOWN. SEE GYM LIGHTING SCHEMATICS, SHEETS E3.5 & E3.8.
- J BOX AND WIRING ONLY, LUMINAIRE HAS BEEN REMOVED
- (8) PROVIDE COVER PLATE ON EXISTING J-BOX.

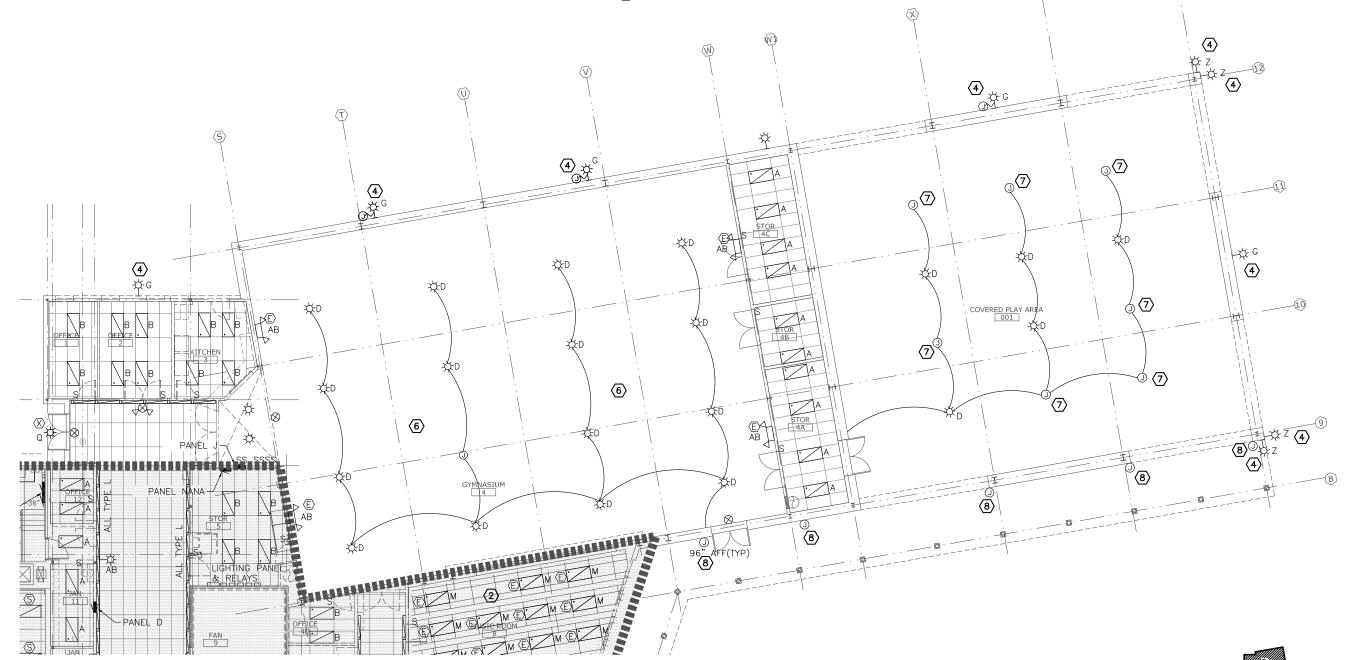







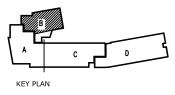





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RENOVATION
CBJ Contract No. E11-157
JUNEAU, ALASKA

SHEET TITLE:

AREA B

DEMO PLAN


LIGHTING

DATE: NOV. 15, 2010

REVISION:
CHECKED BY: MGM

AWN: DMP

- REMOVE ALL ELECTRICAL IN AREA C UNLESS NOTED OTHERWISE. INCLUDING SWITCHES, CONDUIT, DEVICES,
- $\langle 2 \rangle$ EXISTING LIGHTING TO REMAIN
- (3) NOT USED
- $\langle 4 \rangle$ NOT USED
- REMOVE, SALVAGE, AND REINSTALL LUMINAIRES. SEE SHEET E3.1. REMOVE WIRING AND CONDUIT. PATCH AND PAINT SURFACES WHERE EQUIPMENT WAS

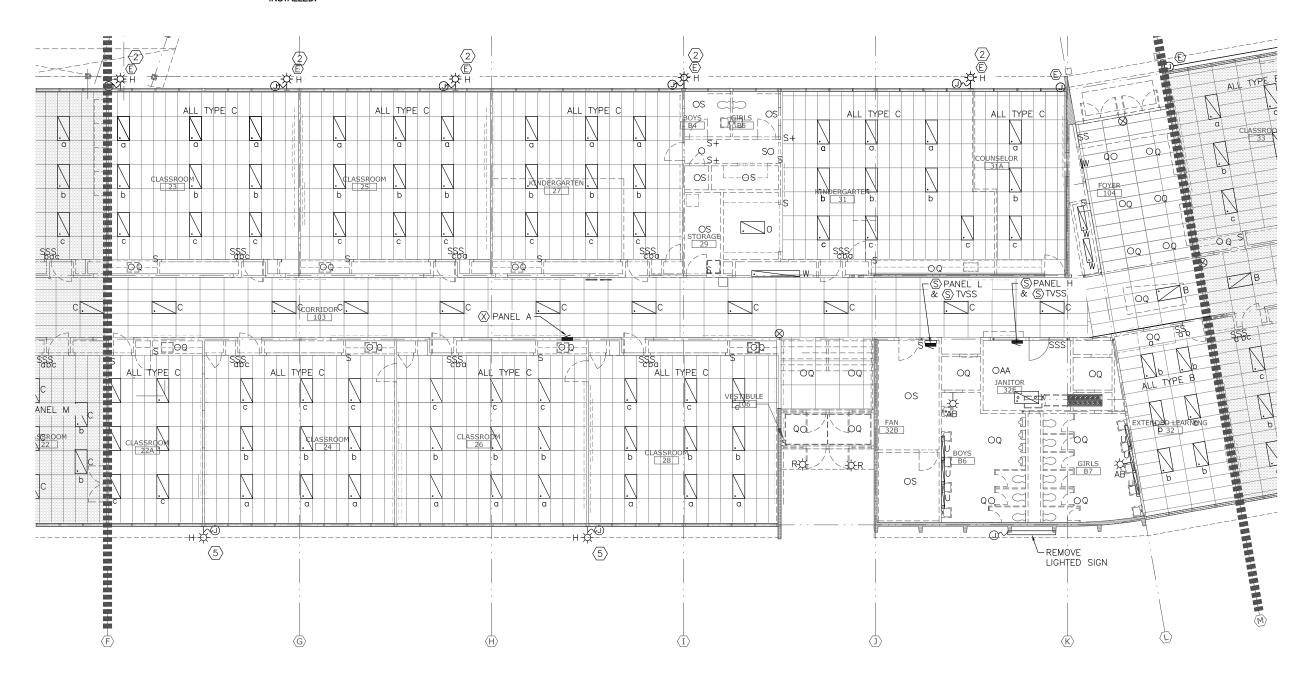













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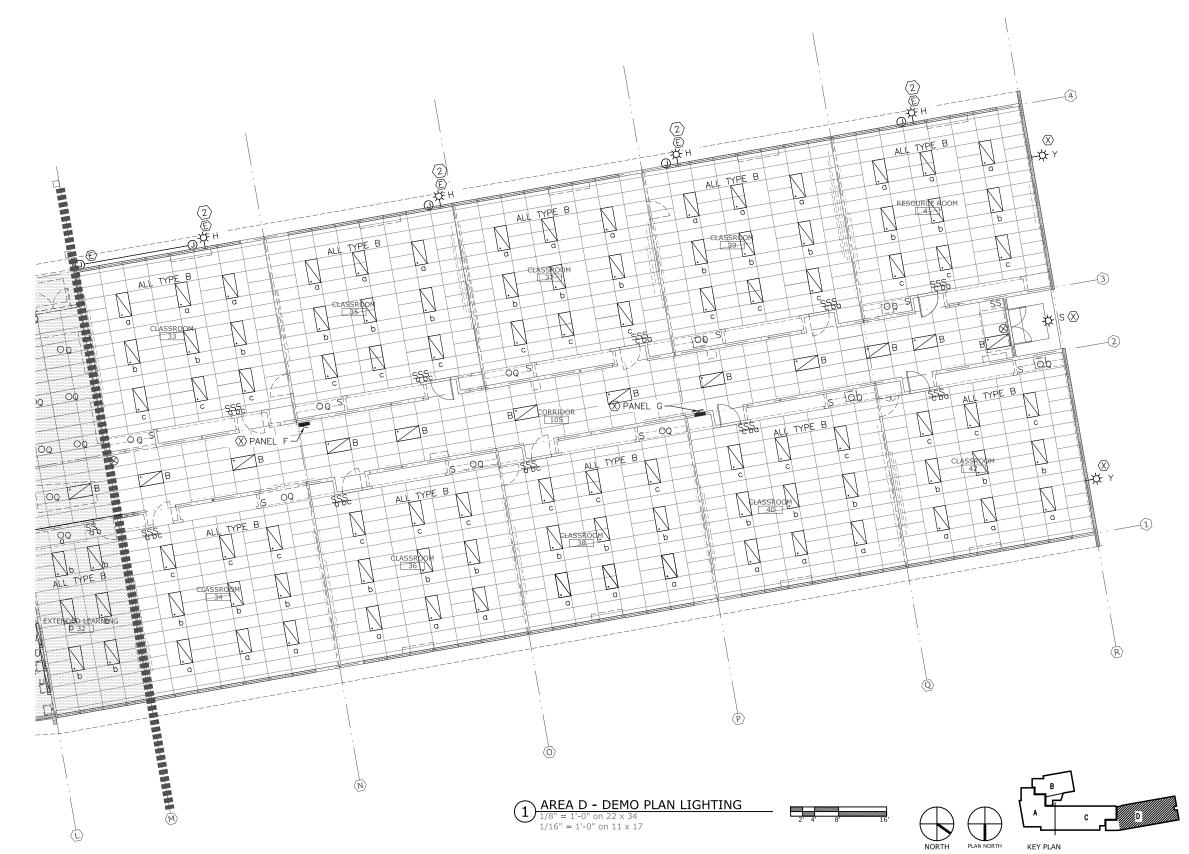
SHEET TITLE: AREA C DEMO PLAN LIGHTING

DATE: NOV. 15, 2010

MGMCHECKED BY:

DMP DRAWN:

- REMOVE ALL ELECTRICAL IN AREA D UNLESS NOTED OTHERWISE. INCLUDING LIGHTS, SWITCHES, CONDUIT, DEVICES ETC.
- 2 EXISTING LIGHTING TO REMAIN







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CBJ Contract No. E11-157
JUNEAU, ALASKA

GASTINEAU ELEMENTARY SHEET TITLE: AREA D DEMO PLAN LIGHTING

DATE: NOV. 15, 2010

	EXISTING L	UMINAIRE SC	HEDULE	
TYPE	DESCRIPTION	MANUFACTURER	LAMPS	REMARKS
А	2X4 FLUORESCENT LENS TROFFER	EXISTING	(2) 40W T12 OR (2) 32W T8	
В	2X4 FLUORESCENT LENS TROFFER	EXISTING	(3) 40W T12 OR (3) 32W T8	
С	2X4 FLUORESCENT LENS TROFFER	EXISTING	(4) 40W T12 OR (4) 32W T8	
D	HIGH BAY PENDANT INDUSTRIAL	EXISTING	(1) 400W MH	
F	PENDANT LIGHT, INVERTED DOME LENS	EXISTING	(1) 400W MH	
G	EXTERIOR WALL MOUNTED AREA LIGHT FIXTURE	EXISTING		SEE NOTE 7
Н	EXTERIOR WALL MOUNTED AREA LIGHT FIXTURE	LITHONIA TWAC	(1) HPS	
J	5" ROUND RECESSED DOWN LIGHT	EXISTING	INCANDESCENT	
К	PENDANT INDIRECT LINEAR ARCHITECTURAL FLUORESCENT FIXTURE	EXISTING	(2) 32W T8	
L	PERIMETER WALL WASH. STRIP FIXTURES W/ SMALL-CELL GRILL	EXISTING	(2) 40W T12	SEE NOTE 1
М	2X4 PARABOLIC TROFFER, 3X8 CELL GRID	EXISTING	(3) 40W T12	
N				
0	1X4 SURFACE MOUNT FLUORESCENT W/ LENS	EXISTING	(2) 40W T12	
Р	2X4 SURFACE MOUNT FLUORESCENT W/ LENS	EXISTING	(VARIES) 40W T12	
Q	12"X12" RECESSED DOWN LIGHT	EXISTING	(1) INCANDESCENT OR COMPACT FLUORESCENT	
R	10"X10" SURFACE MOUNT AREA LIGHT	EXISTING	(1) INCANDESCENT OR COMPACT FLUORESCENT	
S	10" ROUND SURFACE MOUNT AREA LIGHT	EXISTING	(1) INCANDESCENT OR COMPACT FLUORESCENT	
Т	2' FLUORESCENT WALL MOUNT CONTEMPORARY W/ LENS	EXISTING	(1) 20W T12	
U	4' FLUORESCENT DIRECT/INDIRECT WALL MOUNT W/ PLEXIGLAS SHIELD	EXISTING	(2) 40W T12	
٧	UTILITARIAN WALL MOUNT	EXISTING	(1) INCANDESCENT OR COMPACT FLUORESCENT	SEE NOTE 2
W	FLUORESCENT STRIP	EXISTING	(1) VARIES	SEE NOTE 3
Χ	FLUORESCENT PENDANT	EXISTING	(2) 40W T12	SEE NOTE 4
Y	PENDANT DOWN LIGHT	EXISTING	INCANDESCENT	SEE NOTE 4
Z	FLOOD LIGHT WALL MOUNT	EXISTING	(1) 400W MH	
AA	WALL MOUNT	EXISTING	(1) INCANDESCENT OR COMPACT FLUORESCENT	SEE NOTE 5
4	WALL MOUNT EMERGENCY LIGHTS	EXISTING	VARIES	SEE NOTE 6

- NOTES: 1. TYPE L LUMINAIRES ARE MOUNTED ON THE WALL ABOVE THE SUSPENDED CEILING.
- 2. WALL MOUNT BATHROOM FIXTURES, SOME WITH UNGROUNDED OUTLETS. SIZE VARIES.
- 3. SINGLE TUBE FLUORESCENT STRIP LIGHTS, USED IN DISPLAY ALCOVES AND CABINETS. LENGTH AND LAMP WATTAGE VARIES.
- 4. HANGING INDUSTRIAL FIXTURES, SOME WITH WIRE GUARDS. USED IN BOILER, STORAGE & JANITORIAL SPACES.
- 5. BARE LAMP. FOUND IN MECHANICAL AND STORAGE SPACES.
- 6. THERE ARE A NUMBER OF SIMILAR WALL MOUNTED EMERGENCY
- 7. THERE ARE SEVERAL DIFFERENT WALL MOUNT LUMINAIRES WITH DIFFERENT LAMPS.





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SCHOOL GASTINEAU ELEMENTARY

RENOVATION

SHEET TITLE:

existing LUMINAIRE SCHEDULE


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1 EXISTING LUMINAIRE SCHEDULE
NO SCALE



1/16" = 1'-0" on 11×17



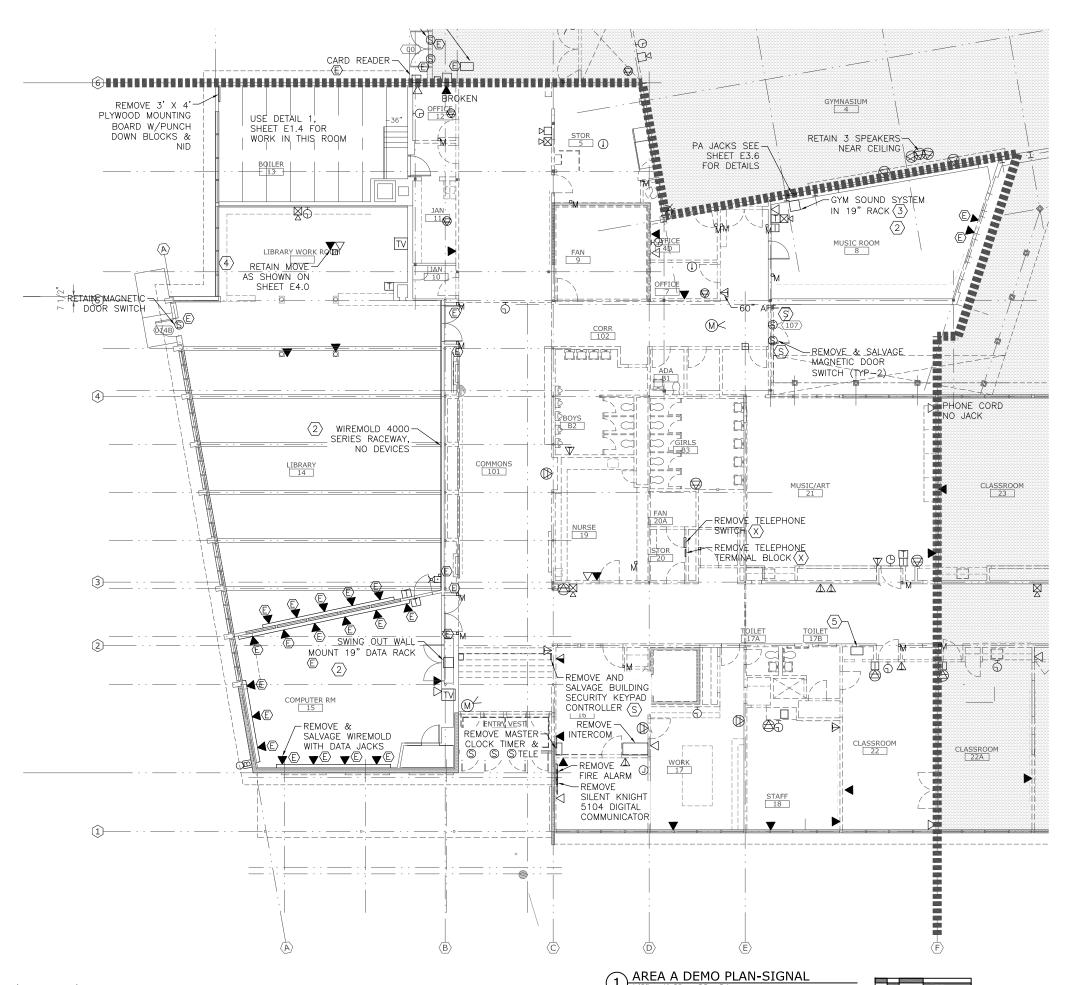

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CONFIGURED IN A NEW FIXED RACK IN THE CLOSET BETWEEN THE NEW GYM OFFICE AND GYM. THE TV SERVICE ENTERS THE BUILDING APPROXIMATELY HERE. ROUTE A RG 6 CABLE FROM THE TV SERVICE DEMARC TO THE CCTV SYSTEM IN SERVER ROOM 127.

RELOCATED DATA RACK FOR INTERIM YEAR BETWEEN SEASON 1 AND SEASON 2.

1. REMOVE ALL ELECTRICAL IN AREA B UNLESS NOTED OTHERWISE. INCLUDING DEVICES, CONDUIT &

② DATA JACKS AND ASSOCIATED WIRING TO REMAIN. REMOVE FIRE ALARM, INTERCOM, AND CLOCK SYSTEM

DEVICES INCLUDING CONDUCTORS, REUSE CONDUIT & JUNCTION BOXES FOR NEW DEVICES IF PRACTICAL.

GYM SOUND SYSTEM HEAD END EQUIPMENT SHALL BE

REMOVED FROM ITS WALL MOUNT SWING OUT RACK. IT SHALL BE SALVAGED AND REINSTALLED AS ORIGINALLY

NOTES:


CONDUCTORS.

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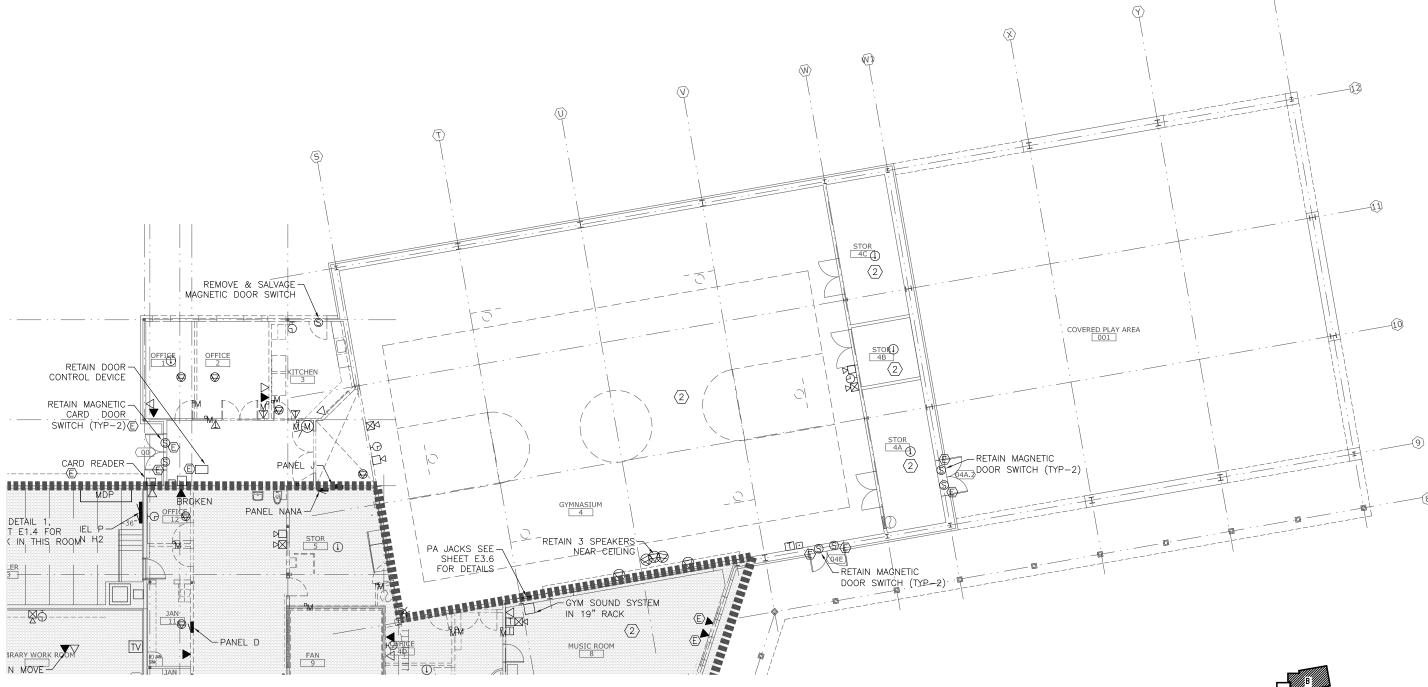
SHEET TITLE:

AREA A DEMO PLAN SIGNAL

DATE: NOV. 15, 2010

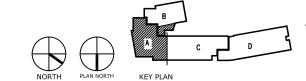

- REMOVE ALL ELECTRICAL IN AREA B UNLESS NOTED
 OTHERWISE. INCLUDING DEVICES, CONDUIT & CONDUCTORS
- DATA JACKS AND ASSOCIATED WIRING TO REMAIN. REMOVE FIRE ALARM, INTERCOM, AND CLOCK SYSTEM DEVICES INCLUDING CONDUCTORS. REUSE CONDUIT & JUNCTION BOXES FOR NEW DEVICES IF PRACTICAL.



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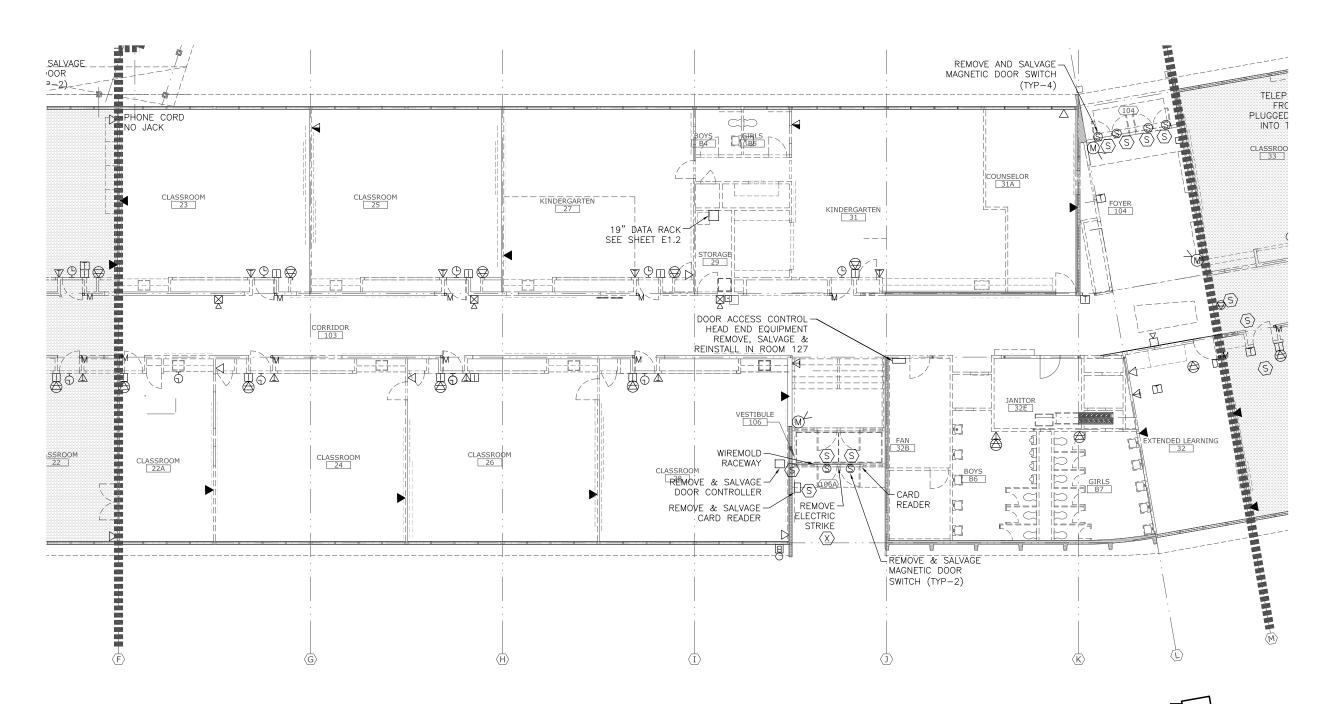
RENOVATION
CBJ Contract No. E11-137
JUNEAU, ALASKA

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SHEET TITLE: AREA B DEMO PLAN SIGNAL

DATE: NOV. 15, 2010

REMOVE ALL ELECTRICAL IN AREA C UNLESS NOTED OTHERWISE, INCLUDING DEVICES, CONDUIT & CONDUCTORS







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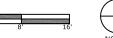
SCHOOL

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SHEET TITLE: AREA C DEMO PLAN SIGNAL


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 REMOVE ALL ELECTRICAL IN AREA D UNLESS NOTED OTHERWISE. INCLUDING DEVICES, CONDUIT & CONDUCTORS







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RENOVATION
CBJ Contract NO. FII-137

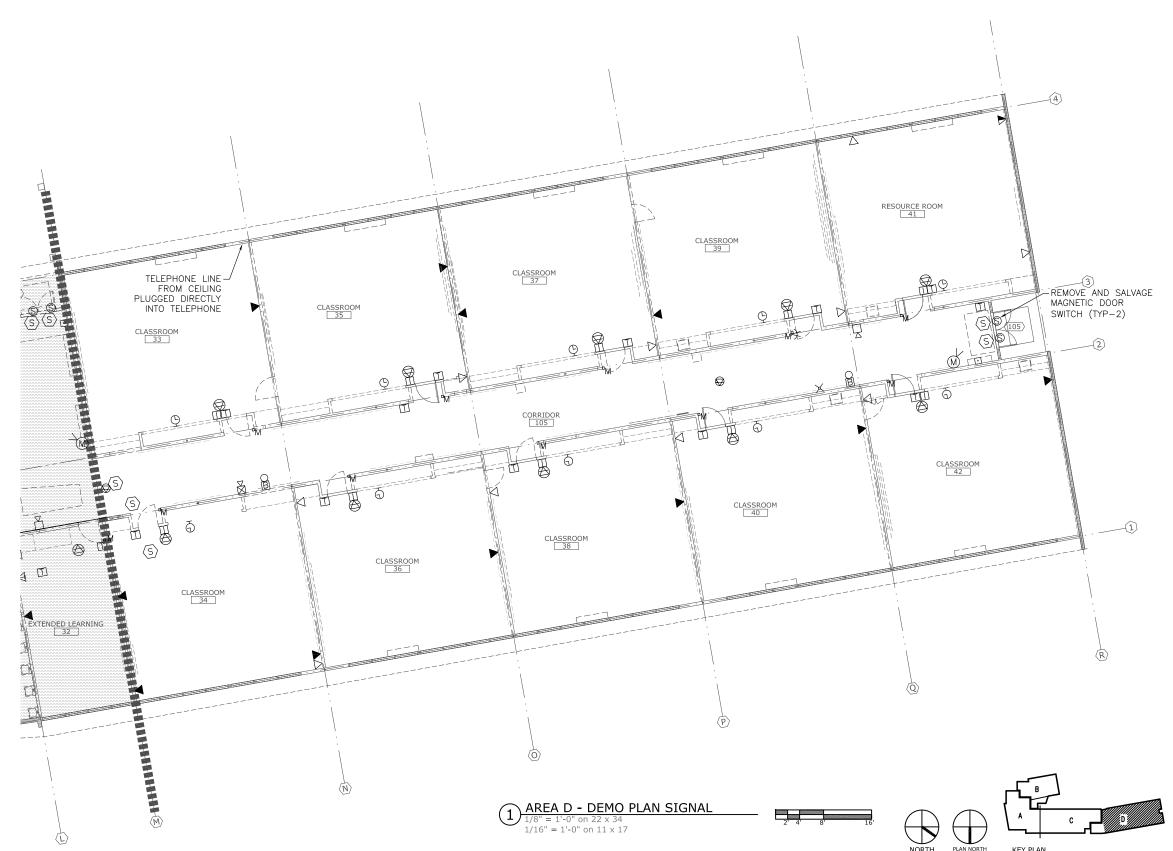
AREA D DEMO PLAN SIGNAL


DATE: NOV. 15, 2010

REVISION:
CHECKED BY: MGM

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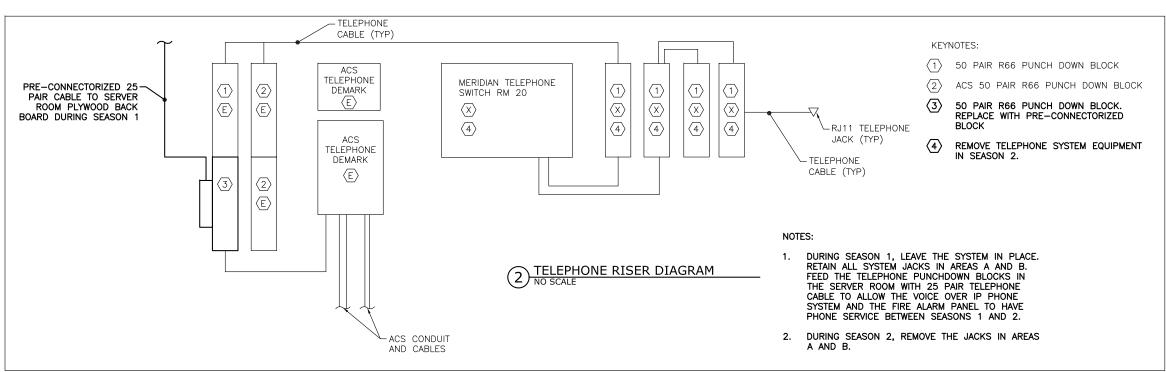


THE OTHER PANEL IN ALARM. USE THE DIGITAL COMMUNICATOR IN THE NEW FIRE ALARM PANEL TO CONTACT THE

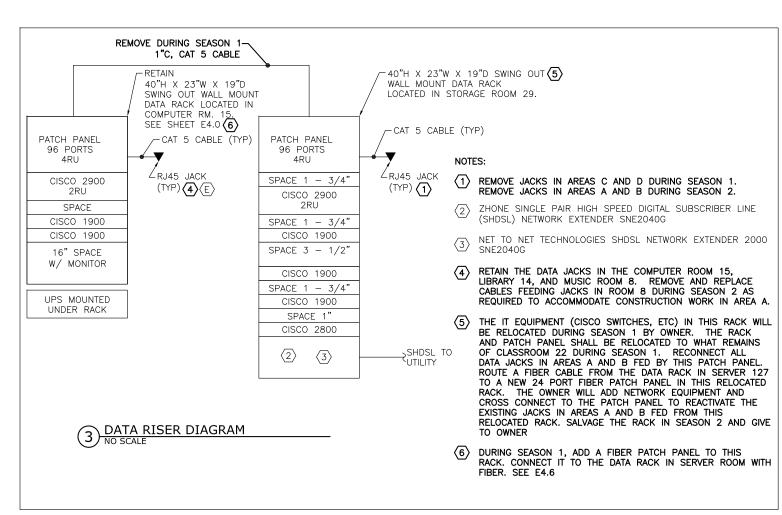3. DURING SEASON 2, REMOVE REMAINDER OF DEVICES AND HEAD END EQUIPMENT.

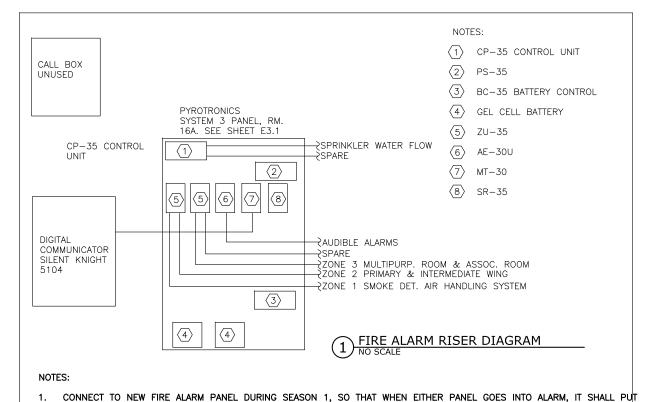REMOVE SYSTEM DEVICES IN AREAS C AND D DURING SEASON 1. RETEST REMAINING DEVICES IN AREAS A AND B PER NFPA 72 AFTER EXISTING CONTROL PANEL IS CONNECTED TO NEW FIRE ALARM SYSTEM.

MONITORING SERVICE.







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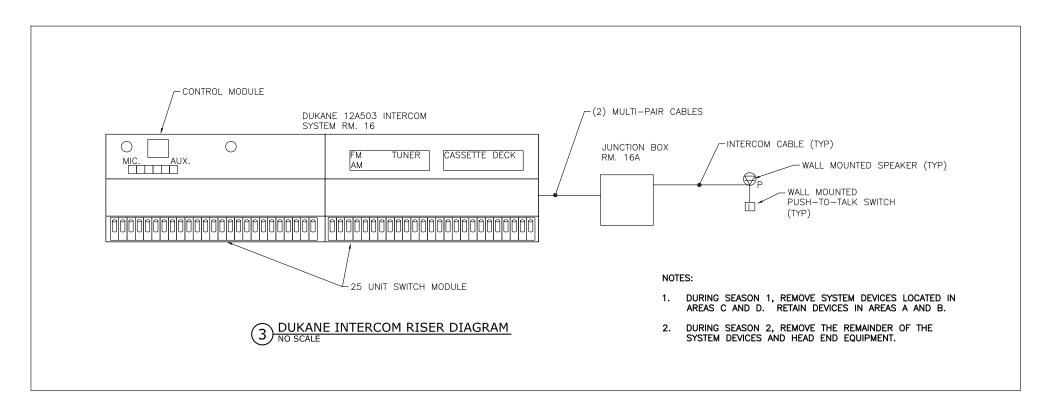
EXISTING
RISER DIAGRAM 1


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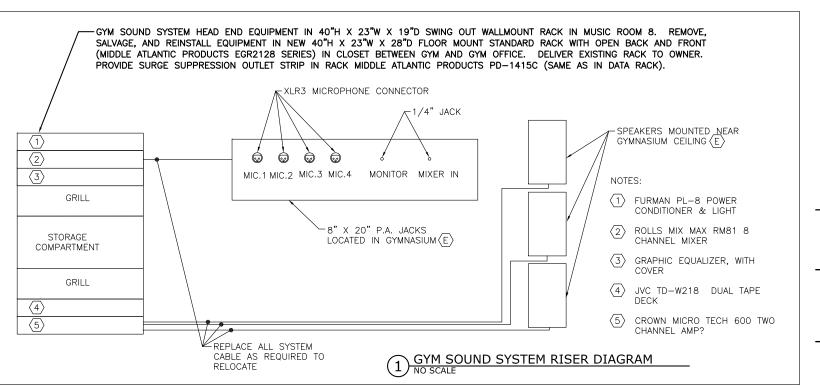
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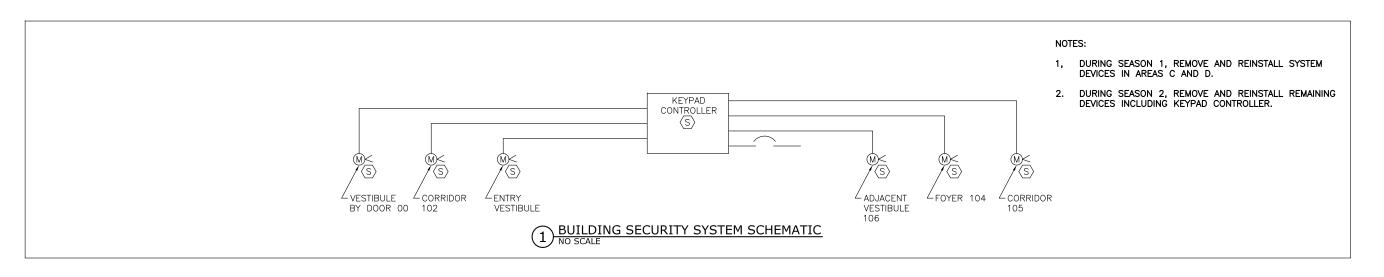
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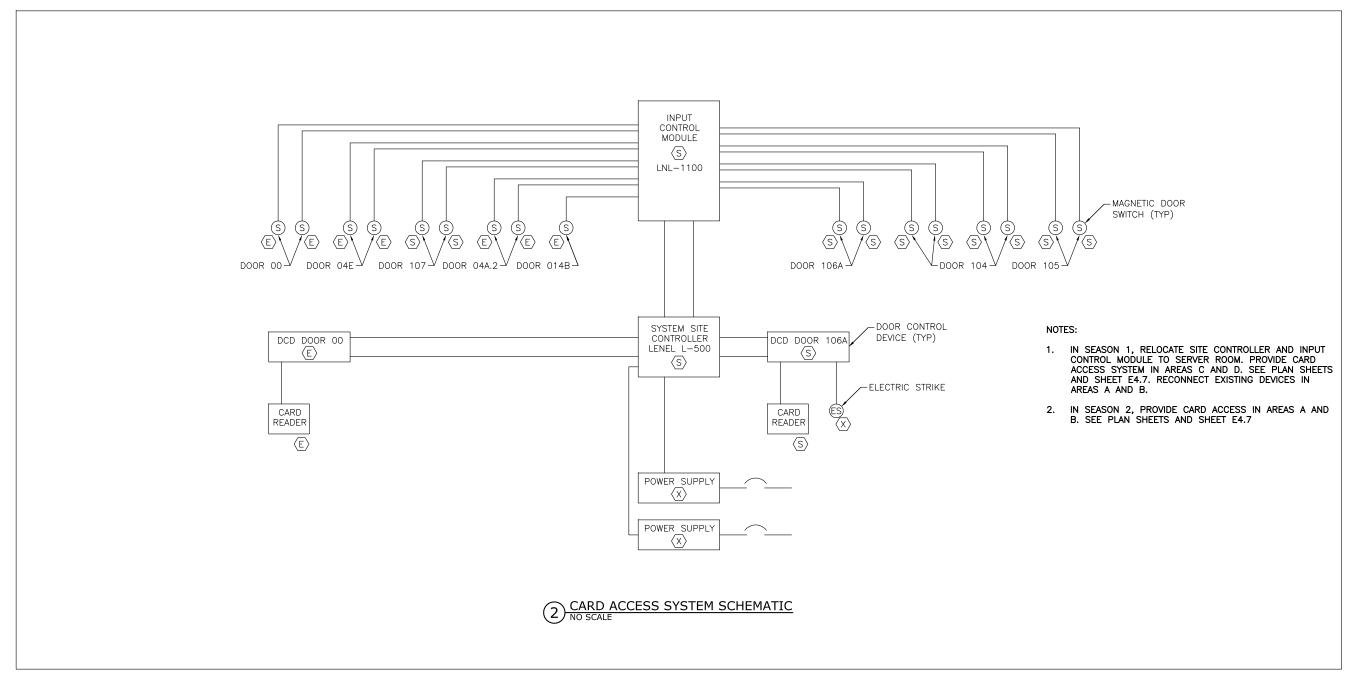
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existing RISER DIAGRAM 2

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RÉVISION:







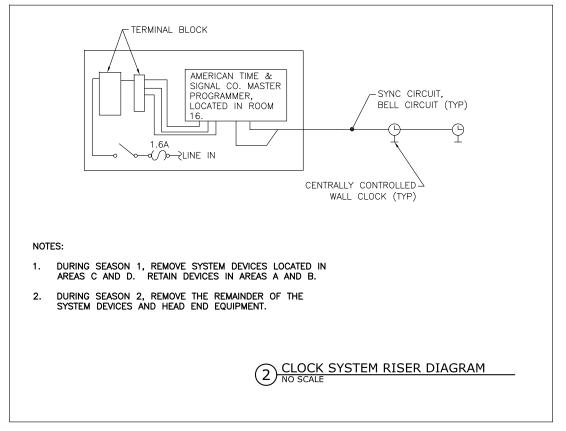

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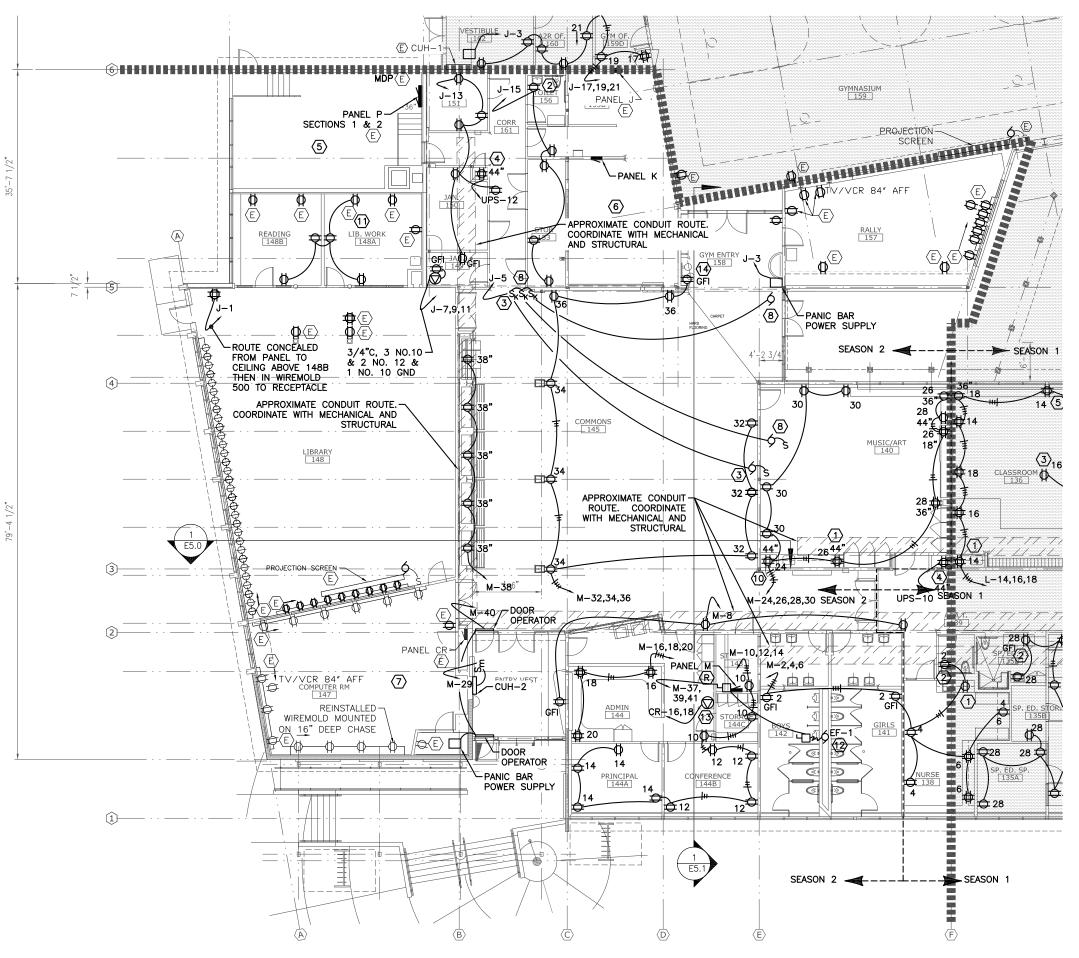
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existing RISER DIAGRAM 3

DATE: NOV. 15, 2010

RÉVISION:





- 1 PROVIDE A GFI RECEPTACLE AT 44" AT A.F.F.
- PROVIDE A GFI RECEPTACLE AT 34".
- POWER PROJECTION SCREEN CONTROL WITH KEYED SWITCH.
- 4 POWER FOR WALL MOUNT DATA RACK
- 5 SEE SHEET E2.4 FOR ELECTRICAL IN BOILER ROOM 152.
- 6 SEE SHEET E2.4 FOR ELECTRICAL IN FAN ROOM 201+201A LOCATED ABOVE KITCHEN 155.
- (7) SEE SHEET E2.4 FOR ELECTRICAL IN FAN ROOM 202 LOCATED ABOVE ROOM 147.
- (8) POWER ELECTRIC SHADES FROM KEYED SWITCH. INSTALL 20 AMP, 120V DISC SWITCH AT MOTOR.
- 9 NOT USED
- POWER COMMONS SOUND SYSTEM SEE SCHEMATIC, SHEET E4.9.
- 1) CONNECT NEW RECEPTACLES IN READING 148B & LIBRARY WORK 148A TO EXISTING RECEPTACLES CIRCUIT.
- MOUNT DISCONNECT ON UNISTRUT TO SIDE OF ROOF CURB AT EF-1.
- PROVIDE A 20/2 C/B IN PANEL CR. RECEPTACLE PER OWNER FOR COPIER.
- LOCATE RECEPTACLE INSIDE FOUNTAIN ENCLOSURE FOR REFRIDGERATOR UNIT. COORDINATED HEIGHT & LOCATION WITH MECHANICAL.





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RENOVATION
CBJ Contract No. E11-137

SHEET TITLE:

AREA A FLOOR PLAN POWER

DATE: NOV. 15, 2010

REVISION:


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DMP

E2.0







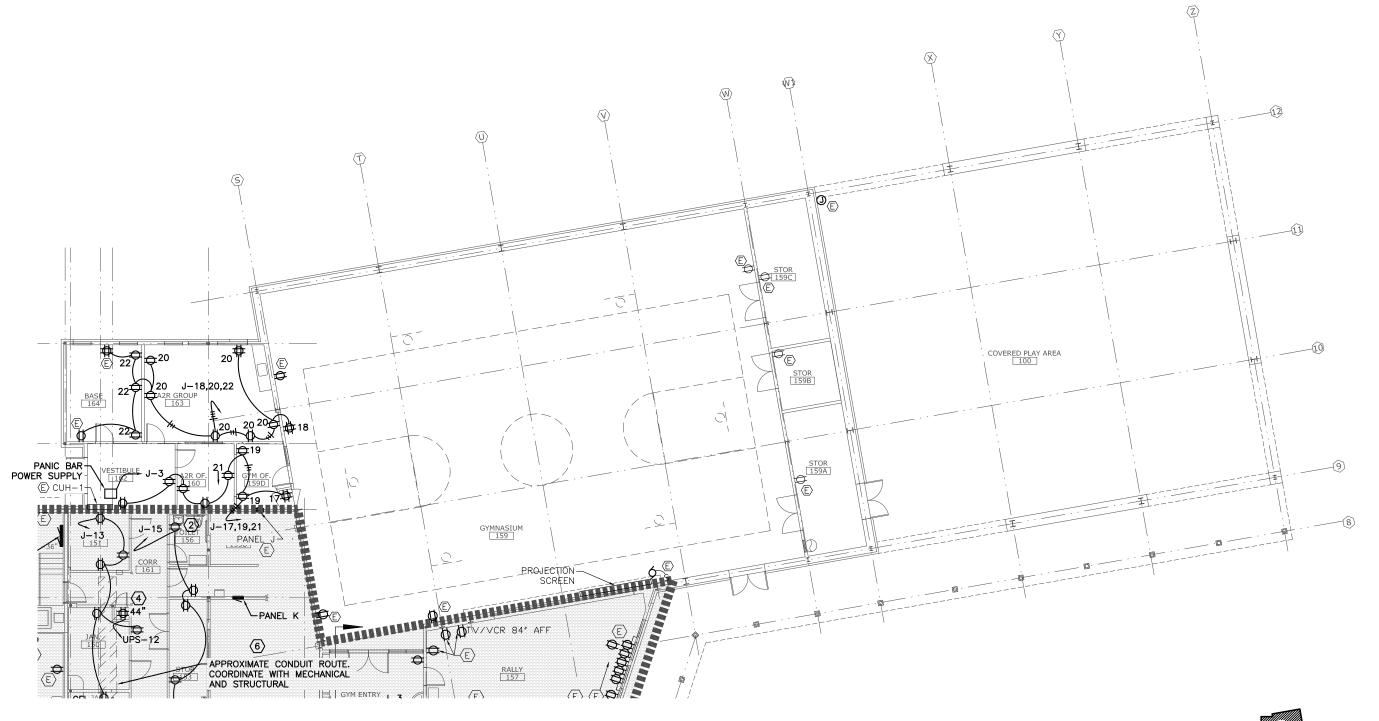



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CBJ Contract No. E11-157
JUNEAU, ALASKA

SHEET TITLE:

AREA B FLOOR PLAN POWER

DATE: NOV. 15, 2010

MGM

DMP

 $\underbrace{ \text{AREA B - POWER FLOOR PLAN}}_{1/8" = 1'\text{-}0" \text{ on } 22 \times 34} \\ _{1/16" = 1'\text{-}0" \text{ on } 11 \times 17}$











- 1 PROVIDE A GFI RECEPTACLE AT 44" AT A.F.F.
- PROVIDE A GFI RECEPTACLE AT 34".
- MOUNT REC IN SUSPENDED CEILING. CO LOCATE WITH DATA RECEPTACLE. SEE SHEET E4.2
- 4 POWER FOR WALL MOUNTED DATA RACK
- FLUSH MOUNT RECEPTACLE IN P-LAM CLOSURE PANEL BETWEEN BOOK SHELF CABINETS. FEED WITH SURFACE MOUNTED CONDUIT ON EXTERIOR WALL BEHIND CABINET AND ABOVE FIN PIPE. SEE DETAIL 1, SHEET A11.5. ROUTE CONDUIT ON EXTERIOR WALL UNTIL IT INTERSECTS WITH THE INTERIOR CLASSROOM WALL. ROUTE CONDUIT CONCEALED IN INTERIOR WALL TO THE NEXT RECEPTACLE IN THE CIRCUIT.
- (6) PROVIDE RECEPTACLES IN RACK POWERED BY UPS PANEL. PROVIDE ONE REC TO POWER EACH RACK MOUNTED RECEPTACLE STRIP.

- 7) SEE ENLARGED PLAN THIS SHEET FOR SERVER 127
- (8) SEE SCHEMATIC, SHEET E2.7 FOR CCU-1 EVAPORATOR
- MOUNT BELOWFOUNTAIN BEHIND COVER. COORDINATE HEIGHT WITH MECHANICAL

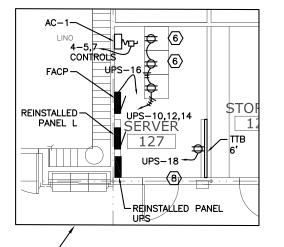


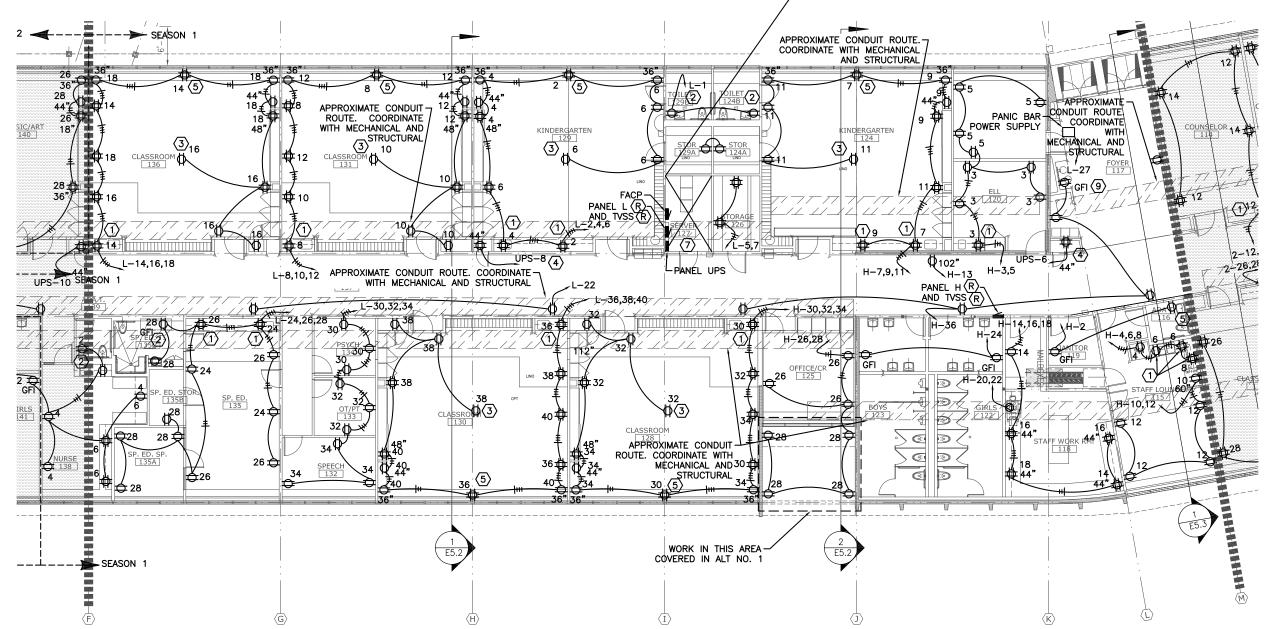







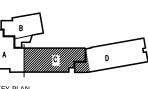





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RENOVATION
CBJ Contract No. E11-157
JUNEAU, ALASKA

ELEMENTARY

STINEAU

SHEET TITLE:

AREA C FLOOR PLAN POWER

DATE: NOV. 15, 2010


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DRAWN: DMP

MGM

E2.2

- 1 PROVIDE A GFI RECEPTACLE AT 44" AT A.F.F.
- $\langle 2 \rangle$ NOT USED
- MOUNT REC IN SUSPENDED CEILING. CO LOCATE WITH DATA RECEPTACLE. SEE SHEET E4.3
- 4 POWER FOR WALL MOUNTED DATA RACK.
- FLUSH MOUNT RECEPTACLE IN P-LAM ENCLOSURE PANEL BETWEEN BOOK SHELF CABINETS. FEED WITH SURFACE MOUNTED CONDUIT ON EXTERIOR WALL BEHIND CABINET AND ABOVE FIN PIPE. SEE DETAIL 1, SHEET A11.5. ROUTE CONDUIT ON EXTERIOR WALL UNTIL IT INTERSECTS WITH WITH THE INTERIOR CLASSROOM WALL. ROUTE CONDUIT CONCEALED IN INTERIOR WALL TO THE NEXT RECEPTACLE IN THE



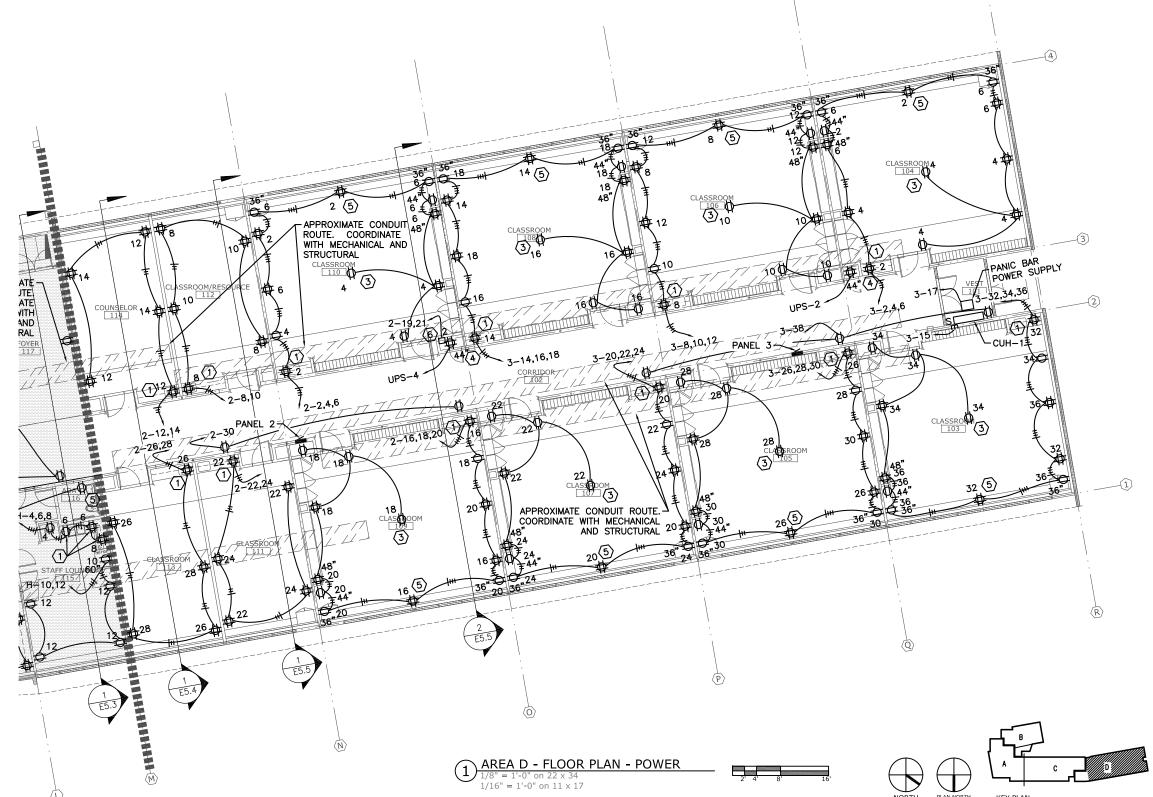



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CBJ Contract No. E11-157

JUNEAU, ALASKA

SHEET TITLE:

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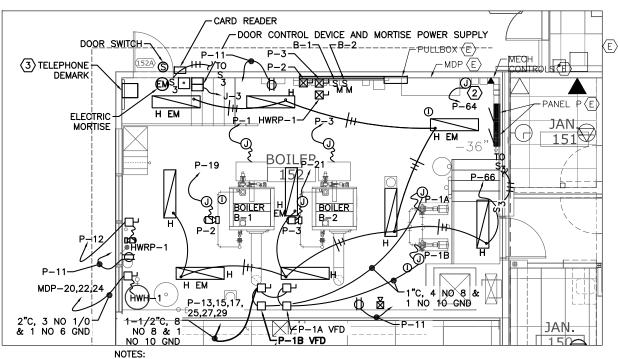
AREA D FLOOR PLAN POWER

DATE: NOV. 15, 2010


REVISION: CHECKED BY:

NN: MGM
DMP

E2.3





- HOME RUNS FOR ALL EQUIPMENT SHALL BE ROUTED FROM MOTOR IN FLEX CONDUIT TO DISCONNECT OR JUNCTION BOX, THEN TO STARTER, THEN TO
- 2 PROVIDE NEW POWER & DATA CONNECTION TO EXISTING BAS CONTROL PANEL.
- EXISTING TELEPHONE DEMARK TO REMAIN. PROVIDE 25 PAIR CABLE FROM PUNCHDOWN BLOCK TO SERVER ROOM PUNCH DOWN BLOCK AS PART OF SEASON 1 WORK

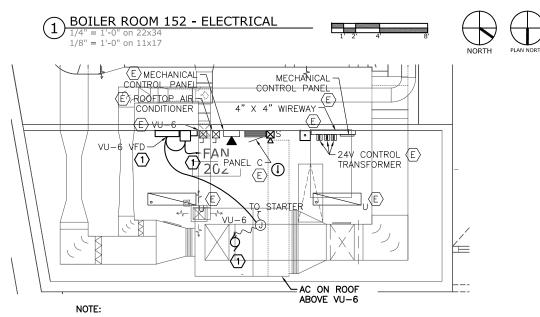


ADDITIVE ALT NO. 6 INCLUDES REPLACING MOTOR TO VU-6 & REPLACING VU-6 STARTER WITH A VFD. PROVIDE A DISCONNECT FOR THE VFD. REFEED MOTOR, POWER VFD FROM SAME CIRCUIT BREAKER IN PANEL C THAT POWERED THE VU-6 STARTER



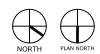

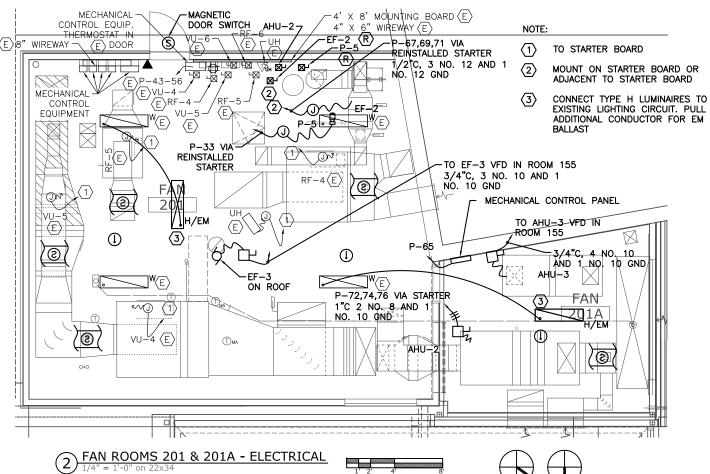

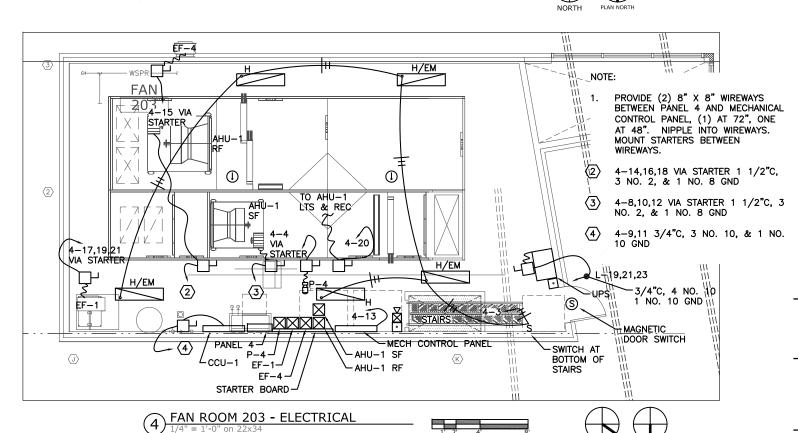

1/8" = 1'-0" on 11x17





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SCHOOI


ELEMENTARY RENOVATION
CBJ Contract No. E11-137
JUNEAU, ALASKA STINEAU


SHEET TITLE:

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ROOMS 152, 201, 201A, 202, & 203 ELECTRICAL

DATE: NOV. 15, 2010



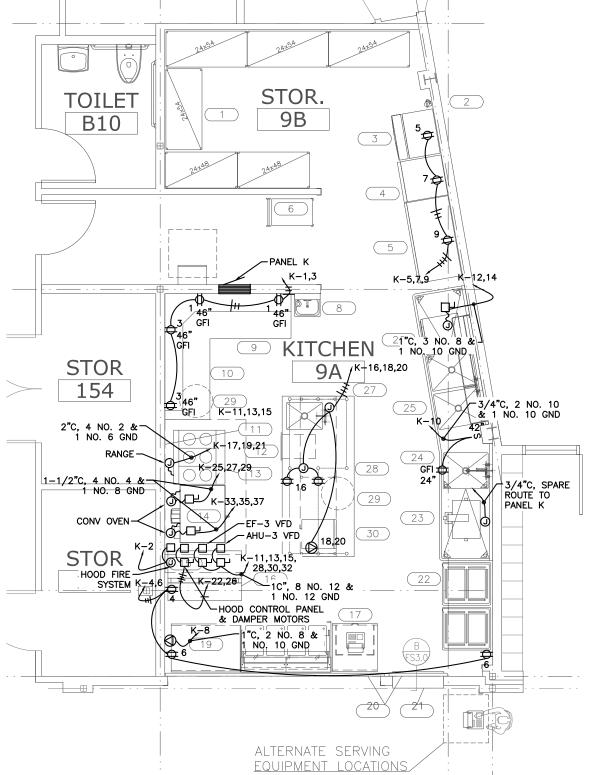

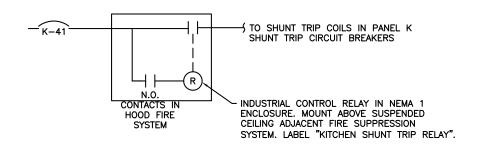SHUNT TRIP CIRCUIT SCHEMATIC


		КІТ	C H	ΗE	Ν	Ε	QU	I F	۱ د	ИΕΙ	N T S	SCHEDULE
ITEM NO	QTY	EQUIPMENT CATEGORY	STATUS	AMPS	KW	윺	VOLTS	PHASE	PLUG	NEMA PLUG	DISCONNECT	REMARKS
1	6	SHELVING, DRY STORAGE	D					Ħ	T			
2	1	FILTER SYSTEM, ICEMAKER	D					Ħ	T			
3	1	ICE MAKER W/ BIN	D	9.9		1/2	115	1	ĺχ	5-15P		
4	1	FREEZER, REACH-IN	D	10.4		1/2	115	1	ĺχ	5-15P		
5	1	REFRIGERATOR, REACH-IN	D	9.1		1/2	120	1	ĺχ	5-15P		
6	1	CART, UTILITY	D					Ħ	T			
7		- SPARE NUMBER -						\Box	T			
8	1	SINK, HAND	Α					\Box	T			
9	1	BASE CABINETS WITH S/S COUNTER TOP	Α	20.0			120	11 2	\lang			
10	1	WALL CABINETS	Α					\Box	T			
11	1	WALL FLASHING	Α					Ħ	T			
12	1	EXHAUST HOOD, CLASS ONE	Α	15.0			120	1 2	₹T		30/3	CONTROL PANEL, DAMPERS
13	1	RANGE, RESTAURANT, ELECTRIC	D	72.0	15.0		208	3 2	₹T			PROVIDE SHUNT TRIP CIRCUIT BREAKER
14	1	OVEN, CONVECTION, ELECTRIC (TOP)	E	58.0	12.0	1/2	208	3 2	₹T		100/3	PROVIDE SHUNT TRIP CIRCUIT BREAKER
	1	OVEN, CONVECTION, ELECTRIC (BOTTOM)	E	58.0	12.0	1/2	208	3 2	₹T		100/3	PROVIDE SHUNT TRIP CIRCUIT BREAKER
15	1	FIRE SUPPRESSION SYSTEM	Α	15.0			120	1 3	╗			
16	1	MILK COOLER	D	9.1		1/2	120	1	x	5-15P		
17	1	CASHIER STATION	D				120	1	ĺχ	5-15P		
18	1	HOT FOOD STATION	D	25.0	3.0		120	1	ĺχ	5-50P		
19	1	DRY/COLD FOOD STATION	D					Ħ	T			
20	2	ROLL DOWN COUNTER DOORS	С					Ħ	T			
21	1	PASS THRU COUNTER LEDGE	Α					Ħ	T			
22	2	TRANSPORT CABINETS	D					Ħ	T			
23	1	GREASE INTERCEPTOR	С	3.4			120	1	ĺχ			
24	1	SINK, 3 COMPARTMENT	Α					Ħ	T			
25	_	POT RACK	D					\sqcap	\top			
26	1	WAREWASHER, UNDERCOUNTER, HIGH TEMP	Α	37.7			208	1 3	×T		60/3	
27	_	COUNTER, PREPARATION WITH SINK	Α	20.0			120	11 3	×Τ			(2) GFI RECEPTACLES PROVIDED WITH COUNTER
28	1	SHELF, TABLE MOUNTED	Α					\sqcap	\top			
29	_	TRASH CAN	В					\sqcap	\top			
30	1	MICROWAVE OVEN, CONVECTION	D		3.3		208	1	Τx	6-20P		
31		- SPARE NUMBER -						\sqcap	\top			
32	1	WASHER	В	10.0			120	1	Τx	5-15P		
	1	DRYER	В	35			240	11	Τx			

NOTE:

ALL KITCHEN ELECTRICAL WITH EXCEPTION OF CONNECTION OF RANGE TO JUNCTION BOX WITH FLEX CONDUIT IS IN BASE BID. FINAL CONNECTION OF RANGE IN ALTERNATE NO.2





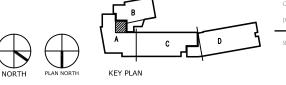





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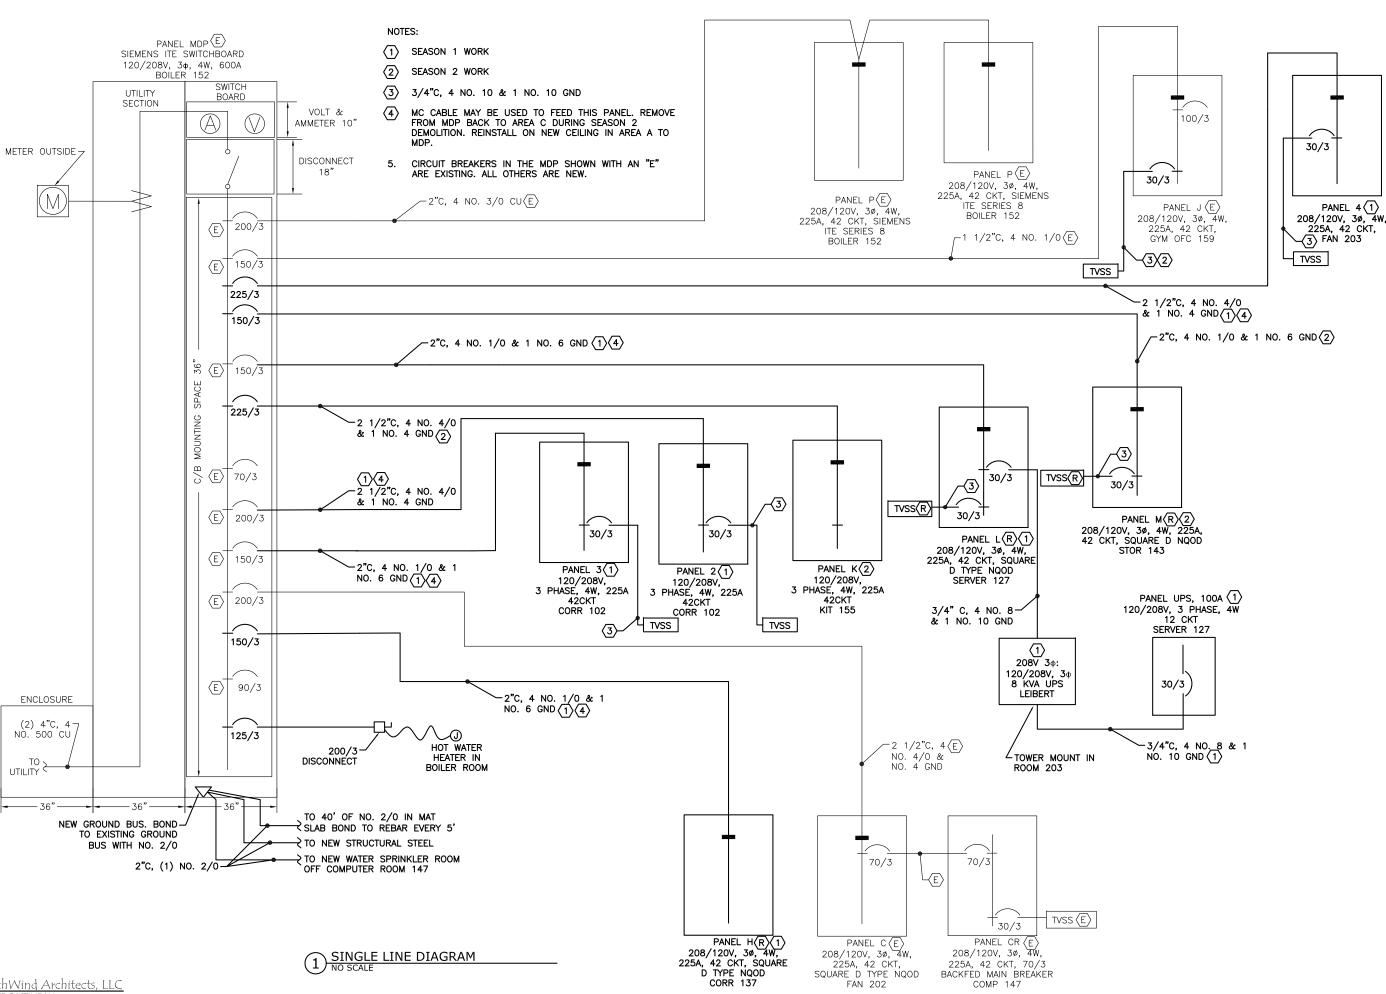
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SCHOOL GASTINEAU ELEMENTARY RENOVATION

FOOD SERVICE PLAN AND SCHEDULE POWER

DATE: NOV. 15, 2010

MGMCHECKED BY DMP







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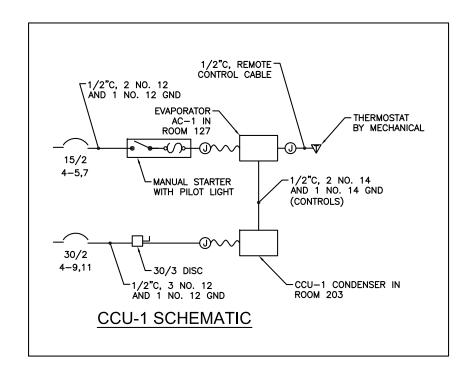
SCHOOL GASTINEAU ELEMENTARY RENOVATION

DIAGRAM

SINGLE LINE

DATE: NOV. 15, 2010

RÉVISION:



		N	<mark>ЛЕСНА</mark>	NICAL EQ	UIPM	ENT SCHE	DULE	
EQUIPMENT	LOCATION	HP/KW	VOLTS/PH	STARTER TYPE/ NEMA SIZE	STARTER SWITCH	STARTER LOCATION	DISCONNECT AT MOTOR	REMARKS
BOILER B1	BOILER RM	3/4	120/1	MANUAL	ON/OFF	BOILER ROOM STARTER BOARD		
BOILER B2	BOILER RM	3/4	120/1	MANUAL	ON/OFF	BOILER ROOM STARTER BOARD		
PUMP P-1A	BOILER RM	5	208/3	VFD		BOILER ROOM STARTER BOARD	60/3	DISCONNECT AT VFD
PUMP P-1B	BOILER RM	5	208/3	VFD		BOILER ROOM STARTER BOARD	60/3	DISCONNECT AT VFD
PUMP P-2	BOILER RM	1/2	120/1	MAG φ	НОА	BOILER ROOM STARTER BOARD		
PUMP P-3	BOILER RM	1/2	120/1	MAG φ	НОА	BOILER ROOM STARTER BOARD		
PUMP P-4	203	1/2	120/1	MAG φ ⟨4⟩	НОА	ROOM 203 STARTER BOARD	30/3	
PUMP P-5	201	1/2	120/1	MAG ⊕ (R)	НОА	ROOM 203 STARTER BOARD		
HWRP-1	BOILER RM	1/8	120/1	MAG φ	НОА	BOILER ROOM STARTER BOARD	30/3	
HWH-1	BOILER RM	30KW	208/3	NONE			200/3	
AHU-1 SF	203	20HP	208/3	NEMA 34		ROOM 203 STARTER BOARD	100/3	
AHU-1 RF	203	15HP	208/3	NEMA 3 4		ROOM 203 STARTER BOARD	100/3	
AHU-1	203		120/1	NONE			30/3	LTG + REC CIRCUIT
AHU-2	201A	5HP	208/3	MAG 1	НОА	ROOM 201 STARTER BOARD	60/3	
AHU-3	201A	1HP	208/3	VFD		ROOM 201	(2) 30/3	VFD IN KITCHEN EXHAUST HOOD. DISCONNECT AT VFD AND AHU-3
VU−4 ⟨E⟩	201		208/3	MAG	НОА	ROOM 201 STARTER BOARD		
VU−5 ⟨E⟩	201		208/3	MAG	НОА	ROOM 201 STARTER BOARD		
VU−6 ⟨E⟩	202		208/3	MAG	НОА	ROOM 202 STARTER BOARD		EXTG TO REMAIN— BASE BID, REMOVE IN ALT NO. 6
EF-1	203	1	208/3	MAG ϕ $\boxed{4}$	НОА	ROOM 203 STARTER BOARD		
EF-2	201	1	208/3	MAG ∳ ⟨R⟩	НОА	ROOM 201 STARTER BOARD		
EF-3	ROOF	1 1/2	208/3	VFD		ROOM155	(2) 30/3	STAINLESS STEEL DISC. AT ROOF. VFD IN KITCHEN HOOD DISC. AT VFD
EF-4	203	1/2	120/1	MAG ϕ $\boxed{4}$	НОА	ROOM 203 STARTER BOARD	30/3	
RF−4 ⟨E⟩	201		208/3	MAG	НОА	ROOM 201		
RF−5 ⟨E⟩	201		120/1	MAG	НОА	ROOM 201		
UNIT HEATER (UH)	E) 201		120/1	MANUAL	ON/OFF	ROOM 201		
CCU (E)	202+R00F		ļ					
CCU-1	203		208/1	NONE			30/3	
CONTROL PANEL	BOILER RM		120/1					POWER CONTROL PANEL
CONTROL PANEL	201		120/1					POWER CONTROL PANEL
CONTROL PANEL	203		120/1			WALL NO		POWER CONTROL PANEL
CUH−1⟨E⟩	VESTIBULE 162	1/12	120/1	MANUAL	ON/OFF	WALL MOUNT AT		
CUH-1	VESTIBULE 101	1/12	120/1	MANUAL	ON/OFF	WALL MOUNT AT		MOUNT NEXT TO UNIT BEHIND COVER
CUH-2	VESTIBULE 146	1/10	120/1	MANUAL	ON/OFF	WALL MOUNT AT UNIT		MOUNT NEXT TO UNIT BEHIND COVER
AC-1	127		208/1	MANUAL	ON/OFF			
KITCHEN HOOD	155		120/1					MELINK PROCESSOR
KITCHEN HOOD	155		120/1					VENTILATION DAMPER MOTORS
VU-6 (ALT-6)	202	7.5HP	208/3	VFD		ROOM 202	60/3	DISCONNECT AT VFD ALT NO. 6

- 1. ALL EQUIPMENT IS NEW UNLESS OTHERWISE NOTED.
- 2. ALL MAGNETIC STARTERS SHALL BE NEMA RATED, NON-FUSIBLE COMBINATION STARTER/DISCONNECTS WITH HOA SWITCH UNLESS OTHERWISE NOTED.
- ALL DISCONNECTS SHALL BE HEAVY DUTY, 600V, NON-FUSIBLE, WITH LOCKABLE HANDLE.
- 4 PROVIDE MAGNETIC STARTER ONLY





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SCHOOL

GASTINEAU ELEMENTARY RENOVATION

MECHANICAL EQUIPMENT SCHEDULE

DATE: NOV. 15, 2010

MECHANICAL EQUIPMENT SCHEDULE
NO SCALE

PA	NEL MDP NEW CONFIG	SIZE	VOLT	S, PHAS	E	MOUNT	ING	MAIN	LO	CATION	
' /	THE WIDT NEW CONTIN	600A	120/	208V, 3	δφ, 4W	SURFA	CE	6	во	ILER ROOM	
	DESCRIPTION	C/B SIZE	KVA			•		C/B S	SIZE	DESCRIPTION	СКТ
NO				Аф	Вф	Сф	CKT	1			NO
1	PANEL P(E)	200/3	8.0	21.0			13.0	*225/	' 3	PANEL 4	2
3			8.0		23.2		15.2				4
5			8.0			22.4	14.4				6
7	PANEL J (E)	150/3	7.9	7.9			0.0				8
9			7.3		7.3		0.0				10
11			4.9			4.9	0.0				12
13	PANEL M(R)	*150/3	16.7	16.7			0.0	200/3	3	PANEL C (E)	14
15			8.9		8.9		0.0				16
17			9.1			9.1	0.0				18
19	PANEL L R	150/3	11.5	21.5			10	*125/	'3	HWH-1	20
21			9.6		19.6		10				22
23			9.4			19.4	10				24
25	PANEL K	*225/3	22.9	33.0			10.1	*150/	'3	PANEL H (R)	26
27			19.6		32.7		13.1				28
29			19.7			30.3	10.6				30
31	PANEL 2	200/3	9.9	9.9			0.0				32
33			10.1		10.1		0.0				34
35			9.4			9.4	0.0				36
37	PANEL 3	150/3	13.4	13.4			0.0				38
39			9.5		9.5		0.0				40
41			12.3			12.3	0.0				42
TOTA	AL CONNECTED LOAD = 342.5KVA	/951A		123.4	111.3	107.8					

* NEW CIRCUIT BREAKER

PANF	L P SECTION 1 NEW CONFIG	SIZE	VO	LTS, P	PHASE	MOU	INTING	MAIN	LOCATION	PΑ	NFI	P SECTION 2 NEW CONFIG	SIZE	VOL	TS, PH	ASE	MOUN	ING	MAIN	LOCATION	
, ,		225A	120	/208V 4W	γ 3φ,	SUF	RFACE	LUGS	BOILER ROOM			2 1 22 3 1 2 1 1 1 2 1 1 1 2 1 1 1 2 1 1 1 2 1 1 2 1 1 1 2 1 1 1 2 1 1 1 2 1 1 1 2 1 1 1 2 1 1 1 1 2 1	225A	120/	/208VY 4W	Зφ,	SURF	CE	LUGS	BOILER ROOM	
CKT NO	DESCRIPTION	C/B SIZE		Аф	KVA		СКТ	C/B SIZE	DESCRIPTION	кт скт	NO	DESCRIPTION	C/B SIZE	СКТ	Αφ	KVA Bø	Сф	СКТ	C/B SIZE	DESCRIPTION	CKT NO
1	B1 BOILER	*20/1			1	1	0.0		SPARE	2 43	3	VU-4 (E)	15/3						20/3	RF−4 ⟨E⟩	44
3	B2 BOILER	*20/1					0.0	15/1	SPARE	4 4	5			0.0				0.0			46
5	SPARE	*20/1	0.0				0.0	1	SPARE	6 47	7			0.0				0.0			48
7	SPARE	*20/1					0.0	20/1	SPARE	8 49	9	VU−5 ⟨E⟩	15/3	0.0				0.6	20/1	$RF-5\langle E \rangle$	50
9	SPARE	*20/1					0.0	15/1	$P-4 \langle E \rangle$	0 5	1			0.0				0.0	20/1	RF−6⟨E⟩	52
11	REC	*20/1					0.2	20/1		2 5	3			0.0				0.0	20/1	SPARE	54
13	P-1A	*35/3						20/2	SPARE 1	4 5	5	VU-6, PDC CONTROLS MZ-11,12,13,14 $\langle E \rangle$	20/1	0.0				0.0	20/1	SPARE	56
15							0.0			6 5	7	CUH-1(E)	15/1	0.0				0.0	20/1	UH FAN ROOM (E)	58
17			1.8				0.0		SPACE '	8 59	9	SPARE	15/1	0.0				0.0	20/1	LGT FAN ROOM 200 (E)	60
19	P-2	*25/1	0.8				0.0	20/2	SPARE 2	20 6	i1	REC. (E)	*20/1	0.0				0.0	20/1	2 DUPLEX REC FOR 200 $\langle E \rangle$	62
21	P-3	*25/1	0.8				0.0		2	22 63	3	RIGHT OF PANEL (E)	*20/1	0.0				0.0	20/1	SPARE	64
23	CCI COMPUTER CONTROL (E)	20/1	0.0				0.0	20/1	SPARE 2	24 65	5	ROOM 201 MECHANICAL CONTROL PANEL (E)	*20/1	0.1				1.1	20/1	BOILER ROOM LIGHTING	66
25	P-1B	*35/3	1.8				0.0	15/3	SPARE 2	26 67	7	EF-2	15/3	0.3				0.0	20/2	PARKING LOT LIGHTS (E)	68
27			1.8				0.0		:	28 69	9			0.3				0.0			70
29			1.8				0.0		;	50 7	'1			0.3				1.7	*35/2	AHU-2	72
31	SPACE		0.0				0.0	20/3	SPARE :	32 7:	3	SPARE	15/3	0.0				1.7			74
33	P-5	15/1	0.2				0.0			34 75	5			0.0				1.7			76
35	SPACE		0.0				0.0		;	36 7	7			0.0				0.0		SPACE	78
37	SPARE	20/3	0.0				0.0	20/1	SPARE :	38 79	9	SPARE	15/3					0.0	20/3	SPARE	80
39			0.0				0.0	30/2	SPARE 4	8 04	11			0.0				0.0			82
41			0.0				0.0			2 8	3			0.0				0.0			84
	TOTAL ESTIMATED LOAD = 24KVA/66AMPS																				

* NEW CIRCUIT BREAKER * NEW CIRCUIT BREAKER

PANEL SCHEDULES - BOILER ROOM
NO SCALE





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RENOVATION
CBJ Contract No. E11-157
JUNEAU, ALASKA

GASTINEAU ELEMENTARY

PANEL SCHEDULES BOILER ROOM

DATE: NOV. 15, 2010

REVISION: CHECKED BY:

Г		SIZE	VOI	_TS, Pl	IASE	MOLII	NTING	MAIN	LOCATION	
	PANEL J NEW CONFIG			/208V			JSH	LUGS	GYMNASIUM OFFICE	
		225A	120	4W	, υψ,		5511		O'IMIN GIOM O'I I I I	
CKT NO	DESCRIPTION	C/B			KVA			C/B	DESCRIPTION	СКТ
CKI NO	DESCRIPTION	SİZE	CKT	Аф	Вф	Сф	CKT	SiZE	DESCRIPTION	NO
1	LIBRARY LAPTOP	*20/1	0.4	1.9			1.5	20/1	BASE164,A2R163,2R160,GYM159 LTG	2
3	CARD ACCESS	*20/1	0.1		1.1		1.0	20/1	GYM 159 (E)	4
5	COMMONS SCREENS	*20/1	1.0			2.0	1.0	20/1	GYM 159 ⟨E⟩	6
7	JAN 149 WASHER	20/1	0.6	0.8			0.2	20/1	GYM 159 ⟨E⟩	8
9	JAN 149 DRYER	30/2	1.0		2.0		1.0	20/1	GYM 159 ⟨E⟩	10
11	JAN 149 DRYER		1.0			1.5	0.5	20/1	GYM 159⟨E⟩	12
13	JAN 149,150,151,CORR 165	20/1	1.2	1.8			0.6	20/1	COVERED PLAY AREA 100(E)	14
15	RESTROOM156,STOR154,KITHALL	20/1	1.0		2.0		1.0	20/1	COVERED PLAY AREA 100(E)	16
17	GYM SOUND SYS	20/1	0.5			0.9	0.4	20/1	COVERED PLAY AREA 100(E)	18
19	GYM OFFICE	20/1	0.6	2.0			1.4	20/1	PLAY AREA 100 (E)	20
21	A2R OFFICE 160, VEST 162	20/1	1.0		1.6		0.6	20/1	SPARE	22
23	GYM EAST WALL	20/1	0.4			0.4	0.0	*30/3	TVSS	24
25	A2R GROUP 163	20/1	1.4	1.4			0.0			26
27	BASE 164	20/1	0.6		0.6		0.0			28
29	GYMNASIUM 159(E)	20/1	0.0			0.0	0.0	20/1	LIBRARY WORK AREA	30
31	RALLY 157(E)	20/1	0.0	0.0			0.0	20/1	EXTERIOR LTG (E)	32
33	STOR 159A,B,C(E)	20/1	0.0		0.0		0.0	20/1	EXTERIOR LTG (E)	34
35	COVERED PLAY AREA 100 (E)	20/1	0.0			0.0	0.0		EXTERIOR LTG (E)	36
37	PROJECTION SCREEN GYM 159(E)	20/1	0.0	0.0			0.0	20/1	RALLY 157 LTG (E)	38
39	UNKNOWN (E)	20/1	0.0		0.0		0.0	20/1	STORAGE 159A,B,C(E)	40
41	CUH-1	20/1	0.1			0.1	0.0	20/1	MAGNETIC DOOR HOLDER	42
TOT	TAL CONNECTED LOAD = 20.1 KVA/ 56	AMPS		7.9	7.3	4.9		•	•	

* NEW CIRCUIT BREAKER

	PANEL 4	SIZE	VC	LTS, PI	HASE	MOUN	ITING	MAIN	LOCATION	
		225A	120/	′208V, 🤅	3φ, 4W	SURF	ACE	LUGS ONLY	203	
CKT NO	DESCRIPTION	C/B SIZE	СКТ	Αф	KVA Bø	Сф	СКТ	C/B SIZE	DESCRIPTION	CKT NO
1	SPARE	20/1	0.0	0.0			0.0	20/1	SPARE	2
3	LTG	20/1	0.7		1.3		0.6	20/1	PUMP P-4	4
5	AC-1 EVAPORATOR	15/2	0.5			1.1	0.6	20/1	PUMP P-5	6
7			0.5	7.5			7.0	100/3	AHU-1 SF	8
9	CCU-1 CONDENSER	30/2	1.0		8.0		7.0			10
11			1.0			8.0	7.0			12
13	MECH CONTROL PANEL	20/1	0.2	5.2			5.0	90/3	AHU-1 RF	14
15	EF-5	20/1	0.6		5.6		5.0			16
17	EF-1	20/3	0.3			5.3	5.0			18
19			0.3	0.3			0.0	20/1	AHU-1 LIGHTS & RECEPTACLES	20
21		T	0.3		0.3		0.0	30/3	TVSS	22
23			0.0			0.0	0.0			24
25			0.0	0.0			0.0			26
27			0.0		0.0		0.0			28
29			0.0			0.0	0.0			30
31										32
33										34
35										36
37										38
39										40
41										42
TOTA	L CONNECTED LOAD = 42.6 KVA/ 11	B AMPS		13.0	15.2	14.4				



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JUNEAU, AK 99801
PH #907.586.6150
FX #907.586.6181 WWW.NORTHWINDARCH.COM

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SCHOOL GASTINEAU ELEMENTARY

RENOVATION
CBJ Contract No. E11-137
JUNEAU, ALASKA

SHEET TITLE:

PANEL SCHEDULES J & 4

DATE: NOV. 15, 2010

revision: CHECKED BY:


	PANEL M NEW CONFIG	SIZE	VC	LTS, PH	HASE	MOUN	ITING	MAIN	LOCATION	
	1 / (I V LL IVI NEW CONFIG	225A	120/	208V, 3	3φ, 4W	SUR	ACE	LUGS	STORAGE 143	
CKT NO	DESCRIPTION	C/B SIZE	СКТ	Аф	KVA Bø	Сф	СКТ	C/B SIZE	DESCRIPTION	CKT
1	BOYS 412, GIRLS 141, STOR, LTG		8.0	Aφ 8.6	Бψ	Сф	0.6	20/1	BOYS 142, GIRLS 141, RESTR 139	110
3	ADMIN, PRINCIPAL, CONF. LTG	20/1	1.9	0.0	2.5		0.6	20/1	NURSE 138	4
5	MUSIC 140	- ' .	1.7		2.5	2.7	1.0	20/1	NURSE 138	6
7	COMMONS LT	· / /	1.4	2.0		2.7	0.6	20/1	CORRIDOR, ENTRY 146	8
9	COMMONS LT	= -, -	0.8	2.0	1.6		0.8	20/1	STOR 143, 144, ADMIN 144	10
			1.4		1.6	2.2	0.8	20/1	CONF 144	
11			1.0	4.0		2.2	0.8	,		12
13		rg 20/1	1.6	1.8				20/1	PRINCIPAL 144	14
15	KITCHEN LT				2.0		0.4	20/1	ADMIN 144	16
17	STOR & JAN LTG	- ,	0.9			1.3	0.4	*20/1	ADMIN 144	18
19	VEST 162, CORR 161 LT	G 20/	0.4	0.8			0.4	*20/1	ADMIN 144	20
21	EXTERIOR ENTRY CANOPY LT	G 20/1	0.4		0.4		0.0	*20/1	SPARE	22
23	EXTERIOR STAIRS & SIGN LT	rG 20/1	0.7			1.3	0.6	*20/1	COMMONS SOUND SYS	24
25	EXTERIOR POLES FRONT DOOR LT	rg *30/2	0.8	1.6			0.8	*20/1	MUSIC 140	26
27	ALT NO. 3		0.8		1.4		0.6	*20/1	MUSIC 140	28
29	CUH-2	20/1	0.1			0.9	0.8	*20/1	MUSIC 140	30
31	TVSS	*30/3	0.0	0.6			0.6	*20/1	COMMONS 145 WEST WALL	32
33	{R}		0.0		0.6		0.6	*20/1	COMMONS 145 EAST WALL	34
35			0.0			0.4	0.4	*20/1	COMMONS 145 SOUTH WALL	36
37	EF-2	*20/3	0.3	1.3			1.0	*20/1	DISPLAY CASES	38
39			0.3		0.4		0.1	*20/1	CARD ACCESS	40
41			0.3			0.3	0.0	*20/1		42
1	TOTAL CONNECTED LOAD = 34.7 KVA	/ 96 AMPS	•	16.7	8.9	9.1			·	

	PANEL H NEW CONFIG	SIZE	VC	LTS, PI	HASE	MOUN	ITING	MAI	N LOCATION	
	T / (T V CONTIG	225A	120/	'208V, 3	3φ, 4W	FLU	ISH	LUGS	ONLY CORRIDOR 137	
CKT NO	DESCRIPTION	C/B SIZE	СКТ	Αф	KVA Bø	Сф	Скт	C/B SIZE	DESCRIPTION	CKT NO
1	FOYER 117 & CORRIDOR 137	20/1	0.8	1.2			0.4	20/1	JAN 119, TOILET 11	2
3	ELL 120	20/1	1.2		1.4		0.2	20/1	STAFF 115 REF	4
5	RESOURCES 121	20/1	0.8			1.4	0.6	20/1	STAFF 115 KITCHEN COUNTERS	6
7	KINDERGARTEN 124	20/1	0.8	1.2			0.4	20/1	STAFF 115 KITCHEN COUNTERS	8
9	KINDERGARTEN 124	20/1	1.0		1.2		0.2	20/1	STAFF 115 MICROWAVE	10
11	KINDERGARTEN 124	20/1	1.0			1.8	0.8	20/1	STAFF 115 LOUNGE	12
13	WIRELESS ACCESS POINT	20/1	0.2	0.8			0.6	*20/1	STAFF 118	14
15	BOYS 123, GIRLS 122, 125 LTG	20/1	1.8		2.6		0.8	*20/1	STAFF 118	16
17	STAFF 118, 115	20/1	1.5			1.9	0.4	*20/1	STAFF 118	18
19	CLASSROOM 128	20/1	1.8	2.3			0.5	*20/2	STAFF COPIER	20
21	CLASSROOM 130	20/1	1.8		2.3		0.5			22
23	132,133,134,135 SPECIAL ED	20/1	1.9			2.3	0.4	*20/1	BOYS & GIRLS 122 & 123	24
25	NURSE 138, SPECIAL ED	20/1	1.7	2.3			0.6	*20/1	OFFICE 125	26
27	KINDERGARTEN 124	20/1	1.9		2.7		0.8	*20/1	OFFICE 125	28
29	ELL & RESOURCES	20/1	1.0			2.6	1.6	*20/1	CLASSROOM 128	30
31	SPARE	20/1	0.0	0.8			0.8	*20/1	CLASSROOM 128	32
33	SPARE	20/1	0.0		1.4		1.4	*20/1	CLASSROOM 128	34
35	SPARE	20/1	0.0			0.6	0.6	*20/1	CORRIDOR 137	36
37	TVSS	*30/3	0.0	1.5			1.5	*20/1	CORRIDOR 137 LIGHTING	38
39			0.0		1.5		1.5	*20/1	CORRIDOR 137 LIGHTING	40
41			0.0			0.0	0.0	*20/1	SPARE	42
Ī	OTAL CONNECTED LOAD = 33.8 KVA/ 9	94 AMPS		10.1	13.1	10.6				

△ PROVIDE FLUSH COVER

Р	ANEL L NEW CONFIG	SIZE	VO	LTS, PH	IASE	MOU	NTING	MAI	LOCATION	
	, ii vee e wew contro	225A	120)/208V, 4W	Зφ,	SUR	FACE	LUG	S SERVER 127	
CKT NO	DESCRIPTION	C/B			KVA			C/		СКТ
	DESORT HOR	SiZE	СКТ	Аф	Вф	Сф	CKT	Siz	E DESCRIPTION	NO
1	TOILETS AND STORAGE 129, 124	20/1	8.0	2.2			1.4	20/	/1 KINDERGARDEN 129	2
3	SPARE	20/1	0.4		1.2		0.8		KINDERGARDEN 129	4
5	STORAGE 126	20/1	0.4			1.2	0.8		KINDERGARDEN 129	6
7	STORAGE 126	20/1	0.4	2.0			1.6		CLASSROOM 131	8
9	SPARE	20/1	0.0		0.8		0.8		CLASSROOM 131	10
11	STORAGE, TOILET & SERVER LTG	20/1	1.1			2.5	1.4		CLASSROOM 131	12
13	KINDERGARDEN 129	20/1	1.9	3.3			1.4		CLASSROOM 136	14
15	CLASSROOM 131	20/1	1.9		2.7		0.8		CLASSROOM 136	16
17	CLASSROOM 136	20/1	0.3			1.7	1.4		CLASSROOM 136	18
19	UPS	*30/3	0.8	0.8			0.0		SPARE	20
21			0.8		1.2		0.4		CORRIDOR 137	22
23			0.8			1.8	1.0		SPECIAL EDU 135	24
25	MAGNETIC DOOR HOLDER	20/1	1.0	1.8			0.8		SPECIAL EDU 135	26
27	CARD ACCESS SYSTEM	20/1	0.5		1.7		1.2		SPEC EDU SP, STOR, REST R.	28
29	SPARE	20/1	0.0			0.6	0.6		PSYCH 134	30
31	SPARE	20/1	0.0	0.6			0.6		OT/PT 133	32
33	SPARE	20/1	0.0		0.6		0.6		SPEECH 132	34
35	SPARE	20/1	0.0			1.6	1.6		CLASSROOM 130	36
37	TVSS	30/3	0.0	0.8			0.8		CLASSROOM 130	38
39			0.0		1.4		1.4	П	CLASSROOM 130	40
41			0.0			0.0	0.0		SPARE	42
TOTA	AL CONNECTED LOAD = 30.5 KVA/ 8	5 AMPS		11.5	9.6	9.4		•	<u> </u>	

	UPS	SIZE	VO	LTS, Ph	HASE	MOUN	NTING	MA	dΝ	LOCATION	
	01 0	100A	120	/208V, 4W	, 3φ,	SURI	FACE	LUGS	ONLY	SERVER 127	
CKT NO	DESCRIPTION	C/B SIZE	СКТ	Аф	KVA B¢	Сф	СКТ	C/B SIZE		DESCRIPTION	CKT NO
1	SPARE	20/1	0.0	0.4			0.4	20/1	DATA	RACK 102B	2
3	SPARE	20/1	0.0		0.4		0.4		DATA	RACK 102A	4
5	SPARE	20/1	0.0			0.4	0.4		DATA	RACK 137C	6
7	SPARE	20/1	0.0	0.2			0.2		DATA	RACK 137B	8
9	SPARE	20/1	0.0		0.2		0.2		VIDEO	RACK 127	10
11	SPARE	20/1	0.0			0.2	0.2		DATA	RACK 127	12
13	SPARE	20/1	0.0	0.2			0.2		INTERO	COM RACK 127	14
15	SPARE	20/1	0.0		0.2		0.2		FIRE A	ALARM 127	16
17	SPARE	20/1	0.0			0.2	0.2		TTB 1	27	18
ТОТ	TAL CONNECTED LOAD = 2.4 KVA/ 7	AMPS		0.8	0.8	0.8		•	•		,

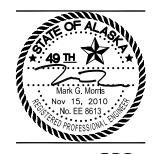



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GASTINEAU ELEMENTARY SCHOOL

RENOVATION
CBJ Contract No. E11-137
JUNEAU, ALASKA

SHEET TITI

PANEL SCHEDULES M, H, L, & UPS

DATE: NOV. 15, 2010

REVISIÓN: CHECKED BY:

DRAWN:

F7 10

MGM

	DANIEL	Louze		N.TO DI	IACE.		ITIN 10	I I	LOCATION	
	PANEL K	SIZE	VC	DLTS, PI	HASE	MOUN		MAIN	LOCATION	
		225	120/	′208V, 3	3φ, 4W	FLU	12H	LUGS ONLY	KITCHEN	
CKT NO	DESCRIPTION	C/B			KVA			C/B	DESCRIPTION	СКТ
CKI NO	DESCRIPTION	SÍZE	СКТ	Аф	Вф	Сф	СКТ	SÍZE		NO
1	COUNTER REC 🗘	20/1	0.4	0.5			0.1	20/1	KITCHEN FIRE SUPPRESSION SYS	2
3	COUNTER REC	20/1	0.4		1.5		1.1	20/1	MILK COOLER	4
5	ICE MAKER	20/1	1.2			1.6	0.4	20/1	REC AT NORTH END	6
7	FREEZER	20/1	1.3	4.3			3.0	50/1	HOT FOOD STATION	8
9	REFRIGERATOR	20/1	1.1		2.6		1.5	30/1	GARBAGE DISPOSAL	10
11	AHU-3 VFD	20/3	0.3			4.3	4.0	50/2	WARE WASHER	12
13	(KITCHEN EXHAUST HOOD)		0.3	4.3			4.0			14
15	(KITCHEN EXHAUST HOOD)		0.3		2.1		1.8	20/1	PREP COUNTER ()	16
17	KITCHEN RANGE	100/3	5.0			5.4	0.4	20/2	MICROWAVE OVEN	18
19	WITH SHUNT TRIP	T	5.0	5.4			0.4			20
21			5.0		5.1		0.1	20/1	KITCHEN HOOD PROCESSOR	22
23			0.1			0.1	0.0		WITH SHUNT TRIP	24
25	CONVECTION OVEN (TOP)	80/3	4.0	4.1			0.1	20/1	HOOD DAMPER MOTORS	26
27	WITH SHUNT TRIP		4.0		4.3		0.3	20/3	EF-3 VFD	28
29			4.0			4.3	0.3		(KITCHEN EXHAUST HOOD)	30
31			0.0	0.3			0.3		(KITCHEN EXHAUST HOOD)	32
33	CONVECTION OVEN (BOTTOM)	80/3	4.0		4.0		0.0	20/1	SPARE	34
35	WITH SHUNT TRIP		4.0			4.0	0.0	20/1	SPARE	36
37			4.0	4.0			0.0	20/1	SPARE	38
39			0.0		0.0		0.0	20/1	SPARE	40
41	SHUNT TRIP CKT	20/1	0.0			0.0	0.0	20/1	SPARE	42
TOT	TAL CONNECTED LOAD = 62.2KVA / 173	AMPS		22.9	19.6	19.7		•		-

	PANEL 3	SIZE	VC	DLTS, PI	HASE	MOUN	ITING	M	AIN	LOCATIO	ON	
	1711122 0	225A	120/	′208V, 3	3φ, 4W	FLU	ISH	LUGS	ONLY	CORRIDOR	102	
CKT NO	DESCRIPTION	C/B SIZE	СКТ	Аф	KVA Bø	Сф	СКТ	C/B SIZE		DESCRIPTION		CKT NO
1	SPARE	20/1	0.0	1.0	·		1.0	20/1	CLASS	ROOM 104	ф	2
3	CLASSROOM 104 LIGHTING	20/1	1.9		3.1		1.2	20/1			Ï	4
5	CLASSROOM 106 LIGHTING	20/1	1.9			3.3	1.4	20/1				6
7	CLASSROOM 108 LIGHTING	20/1	1.9	3.5			1.6	20/1	CLASS	ROOM 106		8
9	CLASSROOM 103 LIGHTING	20/1	1.9		2.7		0.8	20/1				10
11	CLASSROOM 105 LIGHTING	20/1	1.9			3.3	1.4	20/1				12
13	CLASSROOM 107 LIGHTING	20/1	1.9	3.5			1.6	20/1	CLASS	ROOM 108		14
15	CUH-1	20/1	0.1		0.9		0.8	20/1				16
17	DOOR 101 CARD ACCESS	20/1	0.1			1.5	1.4	20/1				18
19	SPARE	20/1	0.0	1.6			1.6	20/1	CLASS	ROOM 107		20
21	SPARE	20/1	0.0		0.8		0.8	20/1				22
23	SPARE	20/1	0.0			1.4	1.4	20/1				24
25	SPARE	20/1	0.0	1.6			1.6	20/1	CLASS	ROOM 105		26
27	SPARE	20/1	0.0		0.8		0.8	20/1				28
29	SPARE	20/1	0.0			1.4	1.4	20/1				30
31	SPARE	20/1	0.0	1.6			1.6	20/1	CLASS	ROOM 103		32
33	SPARE	20/1	0.0		0.8		0.8	20/1				34
35	SPARE	20/1	0.0			1.4	1.4	20/1				36
37	TVSS	30/3	0.0	0.6			0.6	20/1	CORRI	DOR 102		38
39			0.0		0.4		0.4	20/1	DATA	CLOSET		40
41			0.0			0.0	0.0	20/1	SPARE			42
TO	TAL CONNECTED LOAD = 35.2 KVA/ 98	AMPS		13.4	9.5	12.3						

PANEL 2		SIZE	VOLTS, PHASE		MOUNTING		MA		LOCATION		
		225A	120/	′208V,	3φ, 4W	FLU	ISH	LUGS		CORRIDOR 102	
CKT NO	DESCRIPTION	C/B SIZE	СКТ	Аф	KVA Bø	Сф	СКТ	C/B SIZE	DE	SCRIPTION	CK NO
1	SPARE	20/1	0.0	1.4			1.4	20/1	CLASSROOM 110	Φ	2
3	CLASSROOM 110 LIGHTING	20/1	1.9		2.7		0.8	20/1	CLASSROOM 110		4
5	CLASSROOM 109 LIGHTING	20/1	1.9			3.3	1.4	20/1	CLASSROOM 110		6
7	CLASSROOM 112 LIGHTING	20/1	1.0	2.2			1.2	20/1	CLASSROOM 112		8
9	CLASSROOM 114 LIGHTING	20/1	1.0		1.8		0.8	20/1	CLASSROOM 112		10
11	CLASSROOM 111 LIGHTING	20/1	1.0			2.2	1.2	20/1	CLASSROOM 114		12
13	CLASSROOM 113 LIGHTING	20/1	1.0	1.8			0.8	20/1	CLASSROOM 114		14
15	CORRIDOR 102 LIGHTING	20/1	0.9		2.5		1.6	20/1	CLASSROOM 109		16
17	CORRIDOR 102 LIGHTING	20/1	0.9			1.7	0.8	20/1	CLASSROOM 109		18
19	WEST PARKING LIGHTING	20/2	0.8	2.2			1.4	20/1	CLASSROOM 109		20
21	ALT NO. 4		0.8		2.0		1.2	20/1	CLASSROOM 111		22
23	MAGNETIC DOOR HOLDERS	20/1	1.0			1.8	0.8	20/1	CLASSROOM 111		24
25	EXTERIOR LIGHTS PLAY GROUND SIDE	20/1	0.7	1.9			1.2	20/1	CLASSROOM 113		26
27	EXTERIOR LIGHTS PLAY WEST END	20/1	0.3		1.1		0.8	20/1	CLASSROOM 113		28
29		20/1	0.0			0.4	0.4	20/1	CORRIDOR 102		30
31		20/1	0.0	0.4			0.4	20/1	DATA CLOSET		32
33		20/1	0.0		0.0		0.0	20/1		•	34
35		20/1	0.0			0.0	0.0	20/1			36
37	TVSS	30/3	0.0	0.0			0.0	20/1			38
39			0.0		0.0		0.0	20/1			40
41			0.0			0.0	0.0	20/1			42
ТО	TAL CONNECTED LOAD = 29.4 KVA/ 82	AMPS	•	9.9	10.1	9.4		-			





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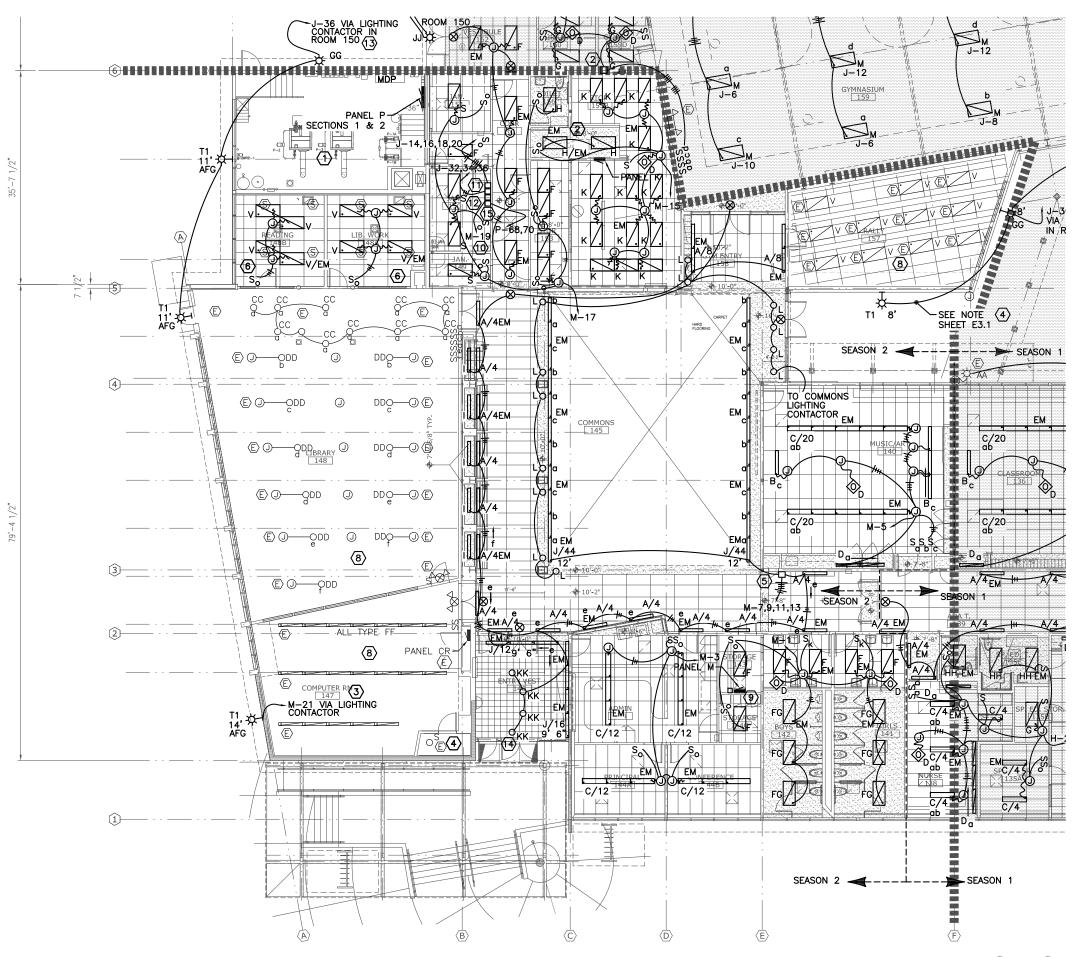
RENOVATION
CBJ Contract No. E11-137
JUNEAU, ALASKA

SHEET TITLE:

PANEL SCHEDULES K, 2, & 3

DATE: NOV. 15, 2010 REVISION:

CHECKED BY:





- SEE SHEET E2.4 FOR ELECTRICAL IN BOILER ROOM 154.
- SEE SHEET E2.4 FOR ELECTRICAL IN ROOM 201+201A LOCATED ABOVE KITCHEN 155.
- (3) SEE SHEET E2.4 FOR ELECTRICAL IN ROOM 202 LOCATED ABOVE ROOM 147.
- SEE SHEET EO.1 FOR EXTERIOR LIGHTING AT ENTRY AND ON NORTH WALL OF AREA A.
- LIGHTING CONTACTOR FOR COMMONS AND ADJACENT CORRIDOR, MOUNT AT 72" AFF. MOUNT LIGHTING SWITCHES Sa-Sf IN CLOSET AT 48" AFF UNDER CONTACTOR.
- REINSTALL EXISTING LUMINAIRES AS SHOWN. RECIRCUIT AS SHOWN. FEED FROM EXISTING LIGHTING CIRCUIT THAT FED THIS ROOM (PANEL C).
- LIGHTING CONTACTOR FOR CORRIDOR BY COMMONS ENTRY, MOUNT AT 72" AFF. MOUNT Se AND Sf UNDER CONTACTOR IN CLOSET AT 48" AFF.
- THE EXISTING LUMINAIRES IN THIS ROOM ARE TO REMAIN. THE LUMINAIRES IN RALLY ROOM 157 ARE FED FROM PANEL J. THE LUMINAIRES IN LIBRARY 148 AND COMPUTER ROOM 147 ARE FED FROM PANEL C. ALL CIRCUITING INCLUDING HOME RUNS IS TO REMAIN. REMOVE EXISTING RELAY IN RALLY ROOM 157 CIRCUIT
- EXTERIOR LIGHTING CONTACTOR FOR FRONT ENTRY AND DRIVE LIGHTING AT 72" AFF.
- (10) LIGHTING CONTACTOR FOR VEST 162 AND CORR 161.
- (11) LIGHTING CONTACTOR FOR COVERED PLAY AREA AND PLAY GROUND FLOOD LIGHTS. MOUNT AT 72" AFF.
- LIGHTING CONTACTOR FOR EXTERIOR LIGHTING AREA A SOUTH AND AREA B. MOUNT AT 72" AFF.
- MOUNT TYPE GG AND T1 LUMINAIRES TO OUTSIDE WALL FEED FROM JUNCTION BOX MOUNTED ON INTERIOR SIDE OF WALL WITH NIPPLE THROUGH TO LUMINAIRE. ROUTE CONDUIT CONCEALED ABOVE SUSPENDED CEILING, SURFACE MOUNTED IN BOILER ROOM, AND USE WIREMOLD 500 AND SURFACE JUNCTION BOX IN LIBRARY. FEED FROM LIGHTING CONTACTOR IN ROOM 150.
- ADJUST TYPE KK LUMINAIRE TO ILLUMINATE TOTEM. LUMINAIRES SHALL BE NON-SWITCHED. CENTER LUMINAIRES IN 12 $^{\rm w}$ X 12 $^{\rm w}$ CEILING TILES.
- LIGHTING CONTACTOR FOR SOUTH PARKING AREA LIGHTING.





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ELEMENTAR RENOVATION
CBJ Contract No. E11-157
JUNEAU, ALASKA


SHEET TITLE: AREA A

STINEAU

FLOOR PLAN LIGHTING

DATE: NOV. 15, 2010


MGM

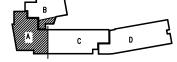





- NOT USED
- 2 PROVIDE CONDUIT AND WIRING FROM GYM LIGHTING CIRCUIT JUNCTION BOX LOCATED ABOVE KITCHEN TO NEW CONTACTOR ABOVE GYM OFFICE, CONNECT NEW SWITCHING TO CONTACTOR, UNDER ALTERNATE NO. 5, REPLACE GYM LIGHTING WITH TYPE M LUMINAIRES. REUSE EXISTING CONDUIT AND CONDUCTORS. REPLACE EXISTING WIRING AS
- RETAIN EXISTING EMERGENCY LIGHTING UNITS. REUSE EXISTING WIRING.
- POWER NEW TYPE T1 AND GG LUMINAIRES WITH SURFACE MOUNTED CONDUIT TO SURFACE MOUNTED JUNCTION BOXES. MOUNT LUMINAIRES ON BOXES. ROUTE CONDUIT TO LIGHTING CONTACTOR IN ROOM 150.
- INSTALL TYPE R AND BB LUMINAIRES AT EXISTING JUNCTION BOX LOCATIONS. USE UNISTRUT AS REQUIRED TO MOUNT LUMINAIRES. REUSE EXISTING WIRING AND CONDUIT BACK TO JUNCTION BOX ABOVE KITCHEN, THEN NEW CONDUIT AND WIRING TO LIGHTING CONTACTOR IN ROOM 150. REPLACE EXISTING WIRING IF REQUIRED. THIS WORK IS INCLUDED IN ALTERNATED NO. 8
- REUSE EXISTING WIRING TO POWER NEW TYPE GG AND REINSTALL TYPE AA LUMINAIRES MOUNTED AT EXISTING JUNCTION BOXES. ANCHOR LUMINAIRES TO EXTERIOR WALLS USING ANCHOR BOLTS OR OTHER FASTENERS OF APPROPRIATE TYPE. REUSE EXISTING CONDUIT AND WIRING TO JUNCTION BOXES ABOVE CEILING AT KITCHEN, THEN NEW CONDUIT AND WIRING TO LIGHTING CONTACTOR IN ROOM 150. REPLACE EXISTING WIRING IF REQUIRED.

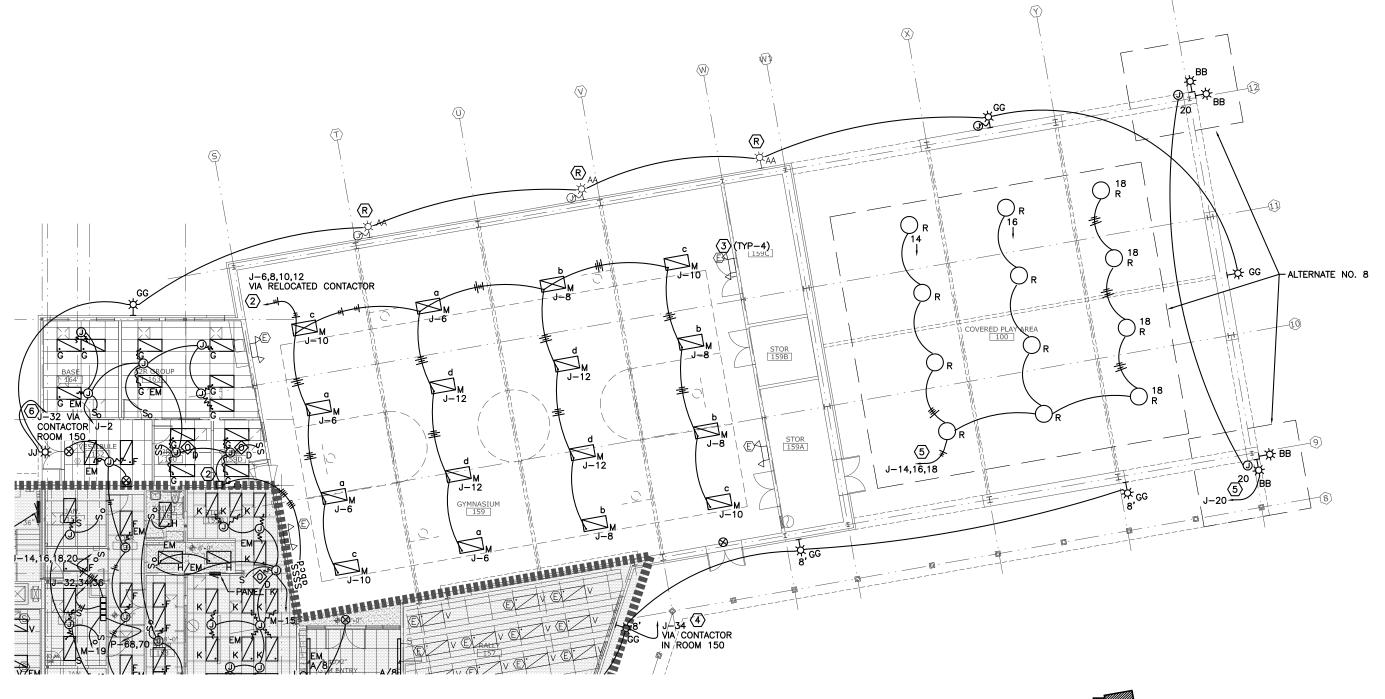





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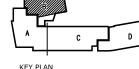
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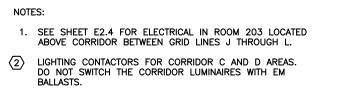
SHEET TITLE: AREA B FLOOR PLAN LIGHTING

DATE: NOV. 15, 2010











3 LIGHTING CONTACTOR FOR EXTERIOR LIGHTING AREAS C AND D, AND WEST PARKING. PROVIDE HOME RUN TO PANEL 2

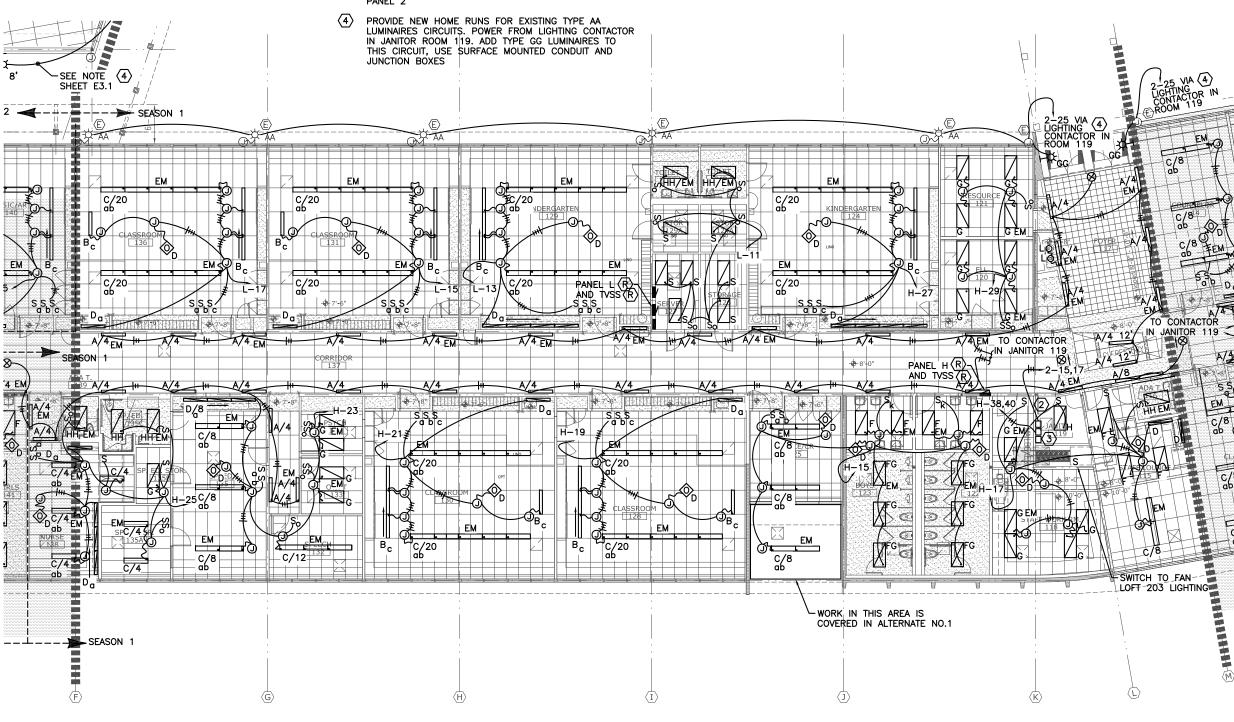







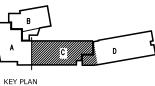





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JUNEAU, ALASKA

SHEET TITLE:

AREA C
FLOOR PLAN
LIGHTING


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MGM

- PROVIDE SURFACE CONDUIT AND JUNCTION BOXES TO MOUNT TYPE GG LUMINAIRES. POWER FROM LIGHTING CONTACTOR IN JAN ROOM 119.
- (2) RE-FEED EXISTING TYPE AA LUMINAIRES CIRCUIT WITH NEW HOME RUN TO LIGHTING CONTACTOR IN JAN ROOM 119.
- (3) FEED LUMINAIRES IN WEST PARKING AREA FROM LIGHTING CONTACTOR IN JANITOR ROOM 119.







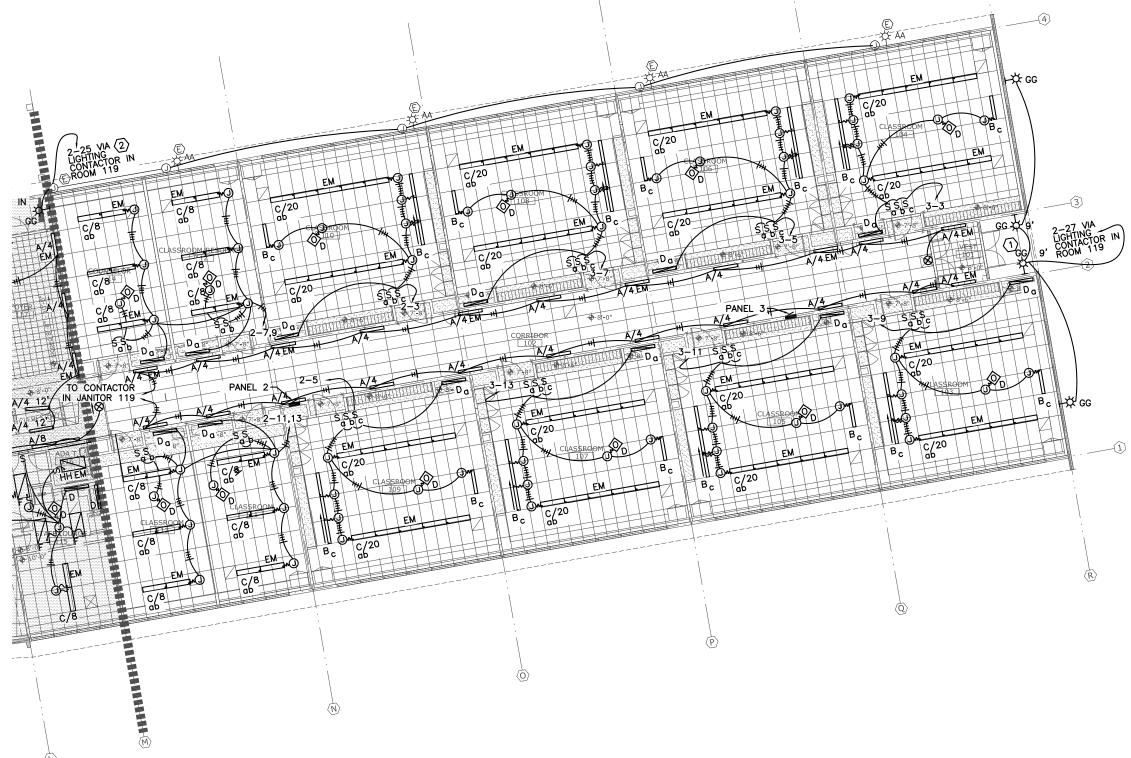







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SHEET TITLE: AREA D FLOOR PLAN LIGHTING

DATE: NOV. 15, 2010

LUMINAIRE SCHEDULE					
TYPE DESCRIPTION		MANUFACTURER	LAMPS	REMARKS	
A	WALL MOUNT DIRECT/ INDIRECT WITH ROUND PERFORATIONS AND STRAIGHT BLADE BAFFLE. WHITE OPAL OVERLAY. DUST COVER. WHITE. ROW LENGTH SHOWN NEXT TO TYPE LETTER.	PEERLESS CERRA: CRW4232PERFWHR4FTR4120GEB10PSEELSCTLP8 35C210DU PART NO. GIVEN (1) 4' LUMINAIRE MODIFY FOR LONGER ROW.	(2) 32W T8 PER 4' SECTION	MOUNT AT 6'-8" TO BOTTOM OF LUMINAIRE. UNLESS OTHERWISE NOTED	
В	ASYMMETRIC RECESSED WALL WASH. WHITE. INTERNAL BALLAST.	LITHONIA AVANTE AVG232MDRASYMVOLTGEB1015	(2) 32W T8	LAY IN CEILING GRID WHERE SHOWN	
С	SUSPENDED LINEAR DIRECT/INDIRECT ROUND PERFORATIONS AND STRAIGHT BLADE BAFFLE. WHITE OPAL OVERLAY. SUSPENDED 18" ON AIRCRAFT CABLE FROM T-BAR CEILING WITH J-BOX. DUST COVER. WHITE.	PEERLESS CERRA 10: 10CRM432WHR20FTR4120GEB10PSEELDCTLP835 FIA/18C210DU PART NO. GIVEN FOR (1)20' ROW. MODIFY PART NO. FOR DIFFERENT ROW LENGTH. MAX 4' SECTION.	(4) 32W T8 PER 4' SECTION	SWITCH (2) LAMPS SEPARATELY	
D	LOW PROFILE UNDER CABINET LIGHT W/ HIGH IMPACT ACRYLIC LENS. 48" LONG.	LITHONIA: 2UC132AR120GEB10RS	(1) 32W T8	MOUNT UNDER CABINET AT FRONT OF CABINET. FACE LENS TOWARD WALL	
F	DIRECT/INDIRECT FLUORESCENT TROFFER METAL DIFFUSER, ROUND HOLES WITH WHITE ACRYLIC DIFFUSER & ACRYLIC LITTER GUARD. (2 'X 4')	LITHONIA 2AVG232MDRMVOLTGEB10RSALGEL	(2) 32W T8	LAY IN CEILING GRID WHERE SHOWN	
G	DIRECT/INDIRECT FLUORESCENT TROFFER METAL DIFFUSER, ROUND HOLES WITH WHITE ACRYLIC DIFFUSER & ACRYLIC LITTER GUARD. (2 'X 4')	LITHONIA: 2AVG332MDRMVOLTGEB10RSALGEL	(3) 32W T8	SWITCH (1) LAMP SEPARATELY LAY IN CEILING GRID WHERE SHOWN	
н	17"X48" SURFACE ARCHITECTURAL W/ ACRYLIC LENS	LITHONIA: 2AW332120GEB10RSEL	(3) 32W T8	SURFACE MOUNT TO CEILING	
I	6"X4' RECESSED, FLANGED TROFFER	LITHONIA: 6NATF132152W	(1) 32W T8	FLUSH MOUNT IN GYPSUM CEILING	
J	WALLMOUNT LINEAR ASYMMETRIC CEILING WASH WHITE.	ELLIPTIPAR: F106T155S021VCO, AFE06070	(1) 54W T5 HO PER 4' SECTION	WALL MOUNT AT HEIGHT SHOWN	
К	2X4 CLEAN ROOM FLUORESCENT RECESSED 1125" ACRYLIC LENS	LITHONIA: 2SRTG432FWA12125VMVOLTGEB10RS	(4) 32W T8	LAY IN CEILING GRID WHERE SHOWN	
L	3" DIA, SEMI DIFFUSED DOWN LIGHT LED WITH WHITE FLANGE	AMERLUX E2.9R-12-LED-E-120-E2.9RD-SD-W-FL- 3000	12W LED 460 LUMENS	FLUSH MOUNT IN BOTTOM OF SOFFIT OR IN CEILING	
М	2X4 FLUORESCENT HIGH BAY. SPECULAR ALUMINUM REFLECTOR WITH WIRE GUARD	LITHONIA: FGB24654T5H0S1X20NLWGMVOLTGEB10PSLP 835	(6) 54W T5 HO	MOUNT TO UNISTRUT ON CEILING	
N	UP/DN SCONCE MACHINED ALUMINUM	ARCHITECTURAL LTG WKS CAS GX10201DREM120AL	20W CMH	MOUNT 8' AFG	
0	WHITE LOW PROFILE CUTOFF AREA LUMINAIRE WITH HOUSE SIDE SHIELD AND TRANSITION TO POLE TOP TENON	GARDCO G1313XL140CMPEUNIVWPHS WITH TR1 TRANSITION TO POLE 05TRS2011T2FPGV	(1) 140W MH COSMOPOLIS	20' GALVANIZED THEN PAINTED TAPERED POLE. WHITE. 130 MH RATING WITH LUMINAIRE	
Р	WALL RECESSED. VANDAL RESISTANT FLUORESCENT	SISTEMALUX: S.4619-120 & S.4523	(1) 26W QUAD G24q 3	MOUNT IN CONCRETE WALL AT 24" AFG	
Q	120V LED ROPE LIGHTING. WARM WHITE. 36 LED/METER	WIDE LOYAL LIGHTING FLEXILIGHT IFLA-65W	LED WARM WHITE	MOUNT TO BACK OF SIGN INTERIOR. PLUG INTO RECEPTACLE IN SIGN	
R	CANOPY LUMINAIRE WITH POLYCARBONATE DROP LENS AND WIRE GUARD	LITHONIA: KACM250MDPP120KACWG	250W MH	MOUNT TO UNISTRUT AT J-BOX LOCATION PROVIDE SUPPORT, CONDUIT AND WIRING AS REQUIRED	
s	2' X 4' RECESSED FLUORESCENT LENSED TROFFER	LITHONIA GT2MV	(2) 32W T8		

LUMINAIRE SCHEDULE					
TYPE	DESCRIPTION	MANUFACTURER	LAMPS	REMARKS	
T1	DOWN LIGHT SHIELDED WITH DIFFUSED GLASS	ARCHITECTURAL AREA LIGHTING ES1-370MHLDLSMB	70W MH	MATCH COLOR TO TYPE O LUMINAIRE. WALLMOUNT AT HEIGHT SHOWN	
T2	DOWN LIGHT SHIELDED WITH DIFFUSED GLASS	ARCHITECTURAL AREA LIGHTING ES1439MHT6LDLSMB	39W MH	MATCH COLOR TO TYPE O LUMINAIRE. WALLMOUNT AT HEIGHT SHOWN	
U	1X4 SURFACE MOUNT FLUORESCENT W/ LENS	EXISTING	(2) 40W T12	Œ	
٧	2X4 PARABOLIC TROFFER, 3X8 CELL GRID	EXISTING	(3) 40W T12	Œ	
w	FLUORESCENT PENDANT	EXISTING	(2) 40W T12	Œ	
Y	EXTERIOR WALL MOUNTED AREA LIGHT FIXTURE	EXISTING	(1) INCANDESCENT OR COMPACT FLUORESCENT	E	
Z	10"X10" SURFACE MOUNT AREA LIGHT	EXISTING	(1) INCANDESCENT OR COMPACT FLUORESCENT	Œ	
AA	EXTERIOR WALL MOUNTED AREA LIGHT FIXTURE	LITHONIA	(1) HPS TWAC	REINSTALL (3) LUMINAIRES WHERE SHOWN	
BB	WET LOCATION FLOOD LIGHT YOKE ADJUSTABLE MOUNT WITH WALL MOUNT ADAPTER	HOLOPHANE PF32LPMMTKW3GPFWGBKT-2-HG	(1) 320W MH	AIM AS DIRECTED BY OWNER	
СС	5" ROUND RECESSED DOWN LIGHT	EXISTING	INCANDESCENT	E	
DD	PENDANT BOWL LIGHT	EXISTING	FLUORESCENT	Œ	
FF	PENDANT DIRECT/INDIRECT LINEAR ARCHITECTURAL	EXISTING	FLUORESCENT	Ē	
FG	DIRECT/INDIRECT FLUORESCENT TROFFER METAL DIFFUSER, ROUND HOLES WITH WHITE ACRYLIC DIFFUSER & ACRYLIC LITTER GUARD. (2 'X 4')	LITHONIA 2AVG232MDRMVOLTGEB10RSALGEL DGA24 DRYWALL ADAPTER	(2) 32W T8	PROVIDE WITH DRYWALL ADAPTER TO FLUSH MOUNT IN GYP BOARD CEILING	
GG	SHIELDED WALLMOUNT DIFFUSE LENS AND VANDAL GUARD WIDE THROW	LITHONIA WSR70MWT120DWHGLPI	70W MH	WALLMOUNT AT HEIGHT SHOWN	
нн	SURFACE MOUNT DIRECT/INDIRECT	LITHONIA AVSM232MDRDLSMVOLTGEB10PSALG	(2) 32W T8		
JJ	6" DIAMETER DOWNLIGHT FLUORESCENT WITH FRESNEL LENS	LITHONIA LI6F 26/32TRT 6LB4 MVOLT	(1) 26W TRT	FLUSH MOUNT IN SOFFIT	
кк	ADJUSTABLE LED DOWNLIGHT 4.75" DIAMETER, 10K LUMENS, NARROW FLOOD, WHITE FLANGE	AMERLUX E4.75RA24LED 120 WTNF 3000 AND E4.75 FLANGE TRIM	LED	FLUSH MOUNT IN CEILING. AIM TO LIGHT TOTEM.	
	EMERGENCY LIGHTING UNIT	EXISTING	HALOGEN	E	

- LUMINAIRE PART NOS. MAY BE INCORRECT. VERIFY WITH MANUFACTURER TO ASSURE ALL FEATURES ARE INCLUDED INCLUDING CONFIGURATION, ROW LENGTH, SECTION LENGTH, NO. OF BALLASTS REQUIRED FOR SEPARATE SWITCHING, ETC.
- 2. PROVIDE WITH EMERGENCY BALLAST WHERE SHOWN ON PLAN VIEW WITH "EM"
- (3) TYPE A LUMINAIRES WITH EM BALLASTS SHALL BE NON SWITCHED (ALL BALLASTS).





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SHEET TITL

LUMINAIRE SCHEDULE

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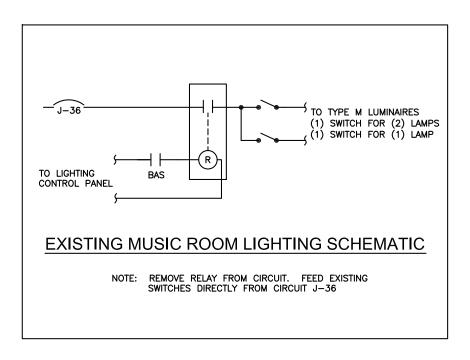
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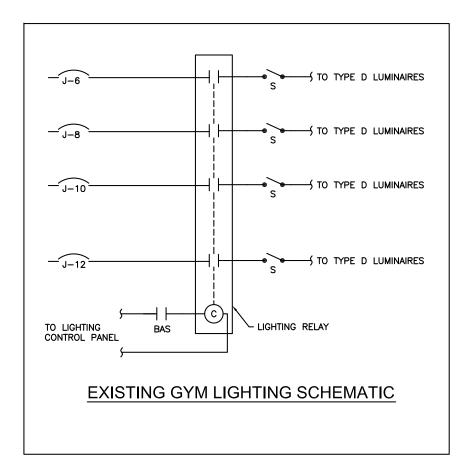
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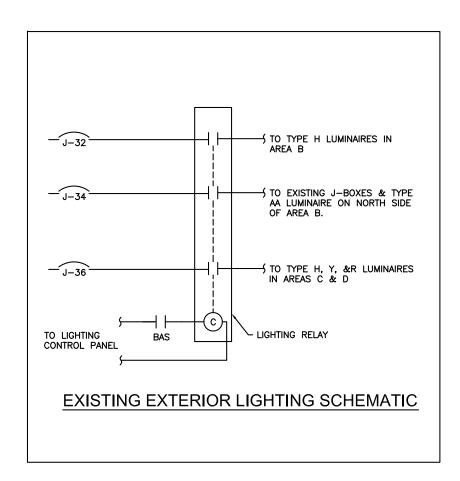
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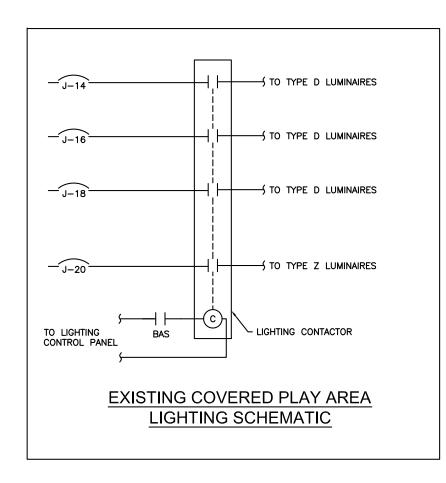
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1 LUMINAIRE SCHEDULE NO SCALE









REMOVE LIGHTING CONTROL PANEL AND ALL LIGHTING RELAYS. PROVIDE JUNCTION BOXES ON STRUCTURAL CEILING ABOVE RELAYS. ROUTE WIRING TO LUMINAIRES INTO THESE J-BOXES. PROVIDE NEW HOME RUNS TO NEW LIGHTING CONTACTORS FROM THESE J-BOXES.





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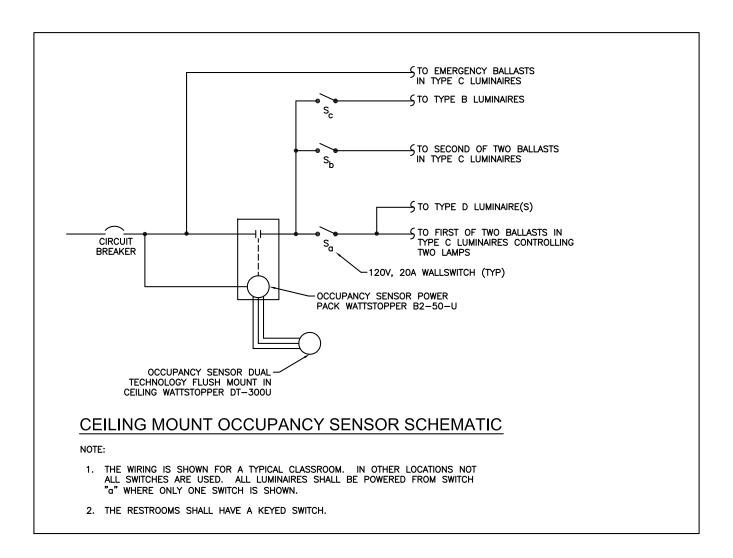
EXISTING LIGHTING CONTROL SCHEMATICS


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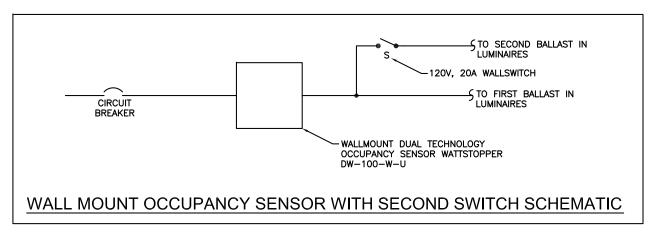
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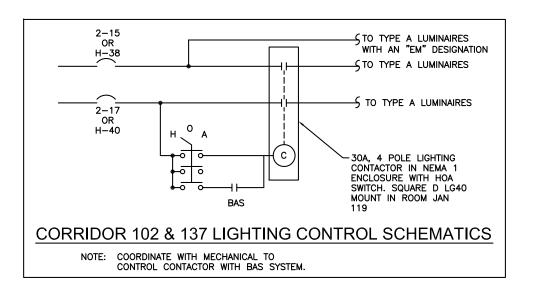
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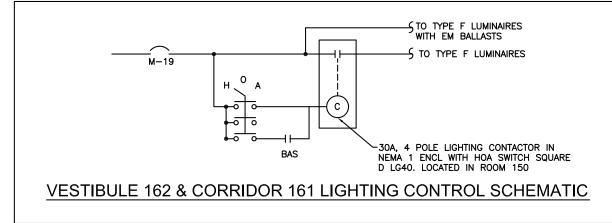
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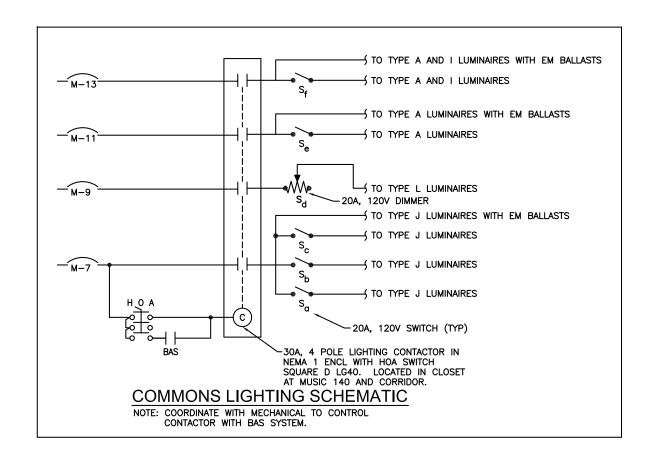
LIGHTING CONTROL SCHEMATICS 1


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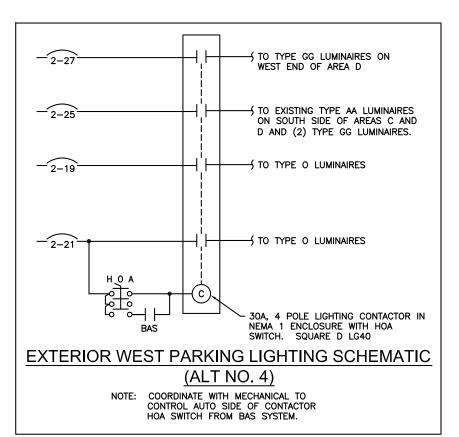
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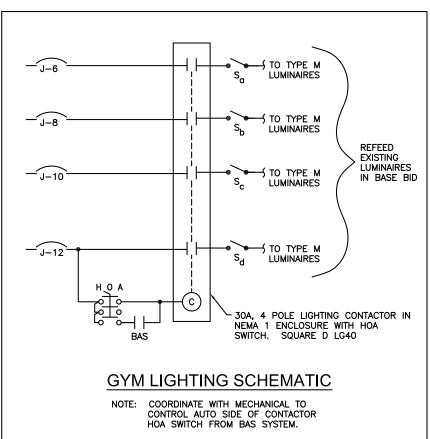
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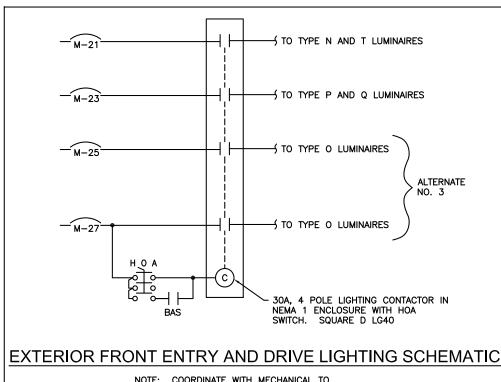
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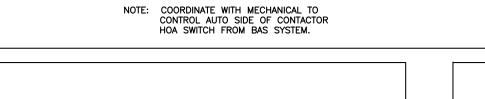
LIGHTING CONTROL SCHEMATICS 2

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-J-32

—(J−34

- J-36

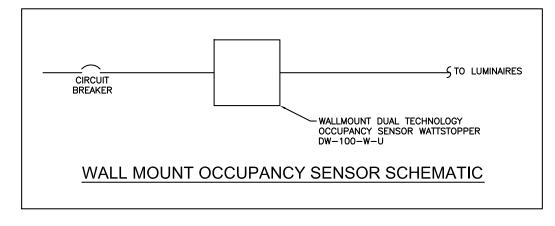TO TYPE JJ, GG, AND REINSTALLED AA LUMINAIRES

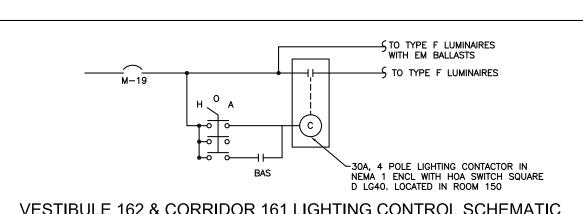ON SOUTH SIDE OF AREA B

LUMINAIRES ON NORTH SIDE

LUMINAIRES ON LIBRARY AND

BOILER ROOM EXTERIOR WALL


30A, 4 POLE LIGHTING CONTACTOR IN


NEMA 1 ENCLOSURE WITH HOA

TO TYPE GG AND T1

TO TYPE GG AND T1

OF AREA B

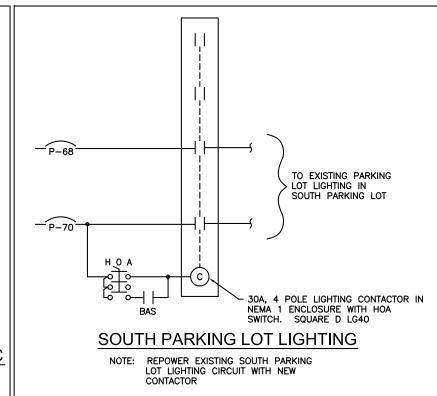

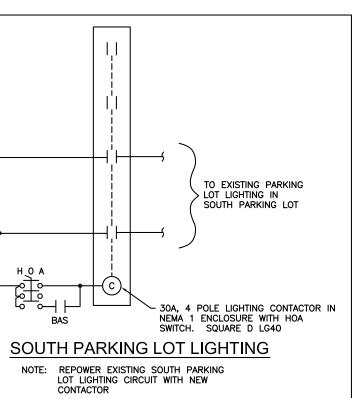



Nov 15, 2010

.No. EE 8613

PROFESSIONAL

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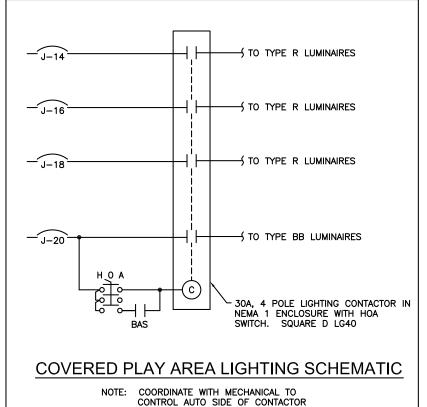
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AFFECTING ALL LABELED SCALES



COORDINATE WITH MECHANICAL TO CONTROL AUTO SIDE OF CONTACTOR HOA SWITCH FROM BAS SYSTEM.

1 LIGHTING CONTROL SCHEMATICS

EXTERIOR BUILDING LIGHTING AREA B AND AREA A SOUTH SCHEMATIC


COORDINATE WITH MECHANICAL TO CONTROL AUTO SIDE OF CONTACTOR

HOA SWITCH FROM BAS SYSTEM.

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PROVIDE A DEDICATED TELEPHONE RECEPTACLE FOR A FAX LINE, PROVIDE A HOME RUN TO SERVER ROOM DISTRIBUTION BLOCKS, CROSS CONNECT TO TELEPHONE

COMMONS SOUND SYSTEM HEAD END EQUIPMENT

LINES COORDINATE WITH OWNER. D = PA SPEAKER

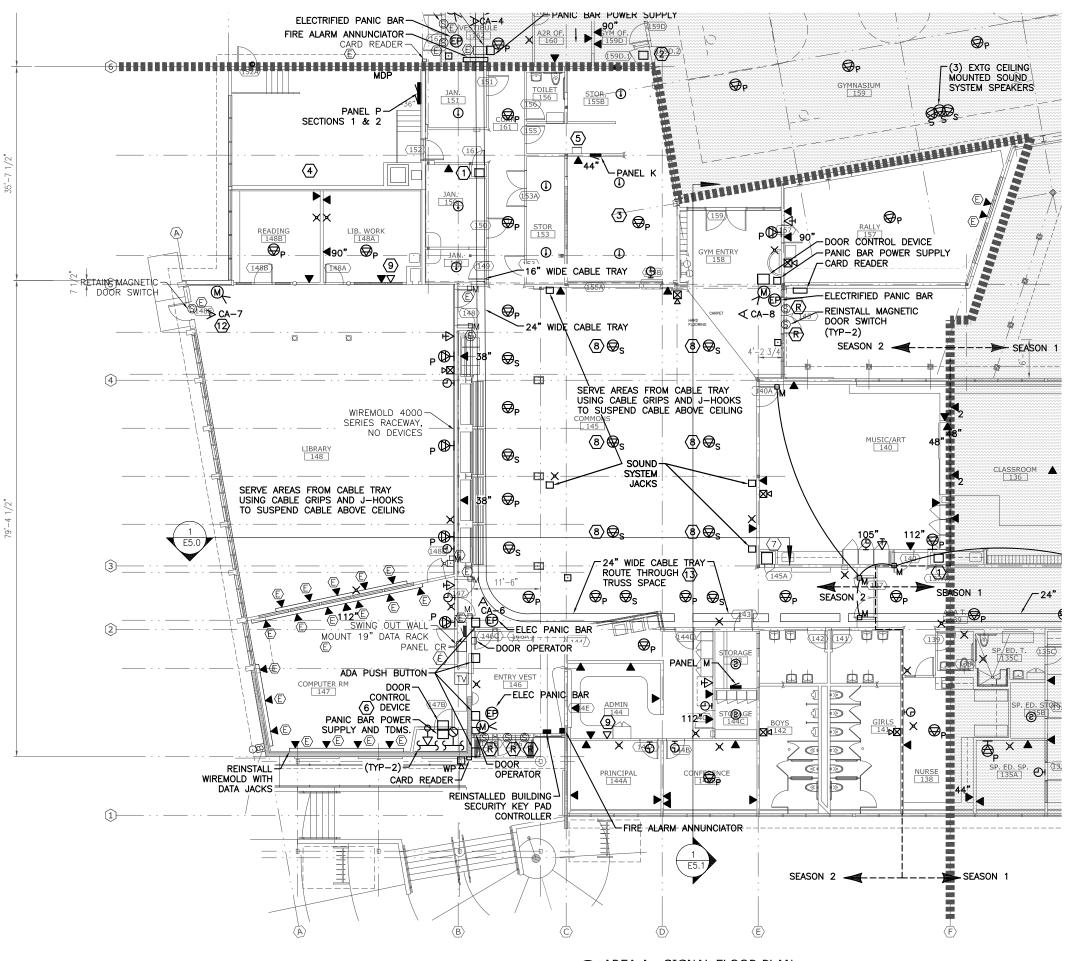WALL MOUNT NETWORK RACK

LOCATED ABOVE KITCHEN 155.

IN KITCHEN HOOD

ABOVE ROOM 147.

REINSTALLED GYM SOUND SYSTEM EQUIPMENT.

PROVIDE IDC CONNECTION TO FIRE SUPPRESSION SYSTEM

SEE SHEET E2.4 FOR ELECTRICAL IN BOILER ROOM 152.

SEE SHEET E2.4 FOR ELECTRICAL IN ROOM 201 & 201A

SEE SHEET E2.4 FOR ELECTRICAL IN ROOM 202 LOCATED

 Θ_{S} = sound system speaker

SURFACE MOUNT SPEAKER

NOTES:

4

6

 $\langle 7 \rangle$

(8)

12 FEED WITH WIRE MOLD 500 RACEWAY WHERE WIRING IS EXPOSED. CONCEAL ABOVE SUSPENDED CEILINGS IN 148A

START AND STOP TRAY BETWEEN CEILING JOISTS AND MECHANICAL EQUIPMENT AS REQUIRED. SUPPORT CABLES FROM J-HOOKS ON CEILING WHERE TRAY STOPS. ROUTE AROUND BUILDING STRUCTURE AND MECHANICAL

AFFECTING ALL LABELED SCALES


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SHEET TITLE: AREA A FLOOR PLAN SIGNAL


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- 1 WALL MOUNT NETWORK RACK
- REINSTALLED GYM SOUND SYSTEM HEAD END EQUIPMENT IN NEW RACK
- 3 PROVIDE NEW HOME RUN TO CATV SYSTEM IN SERVER ROOM.





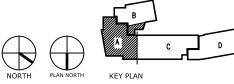

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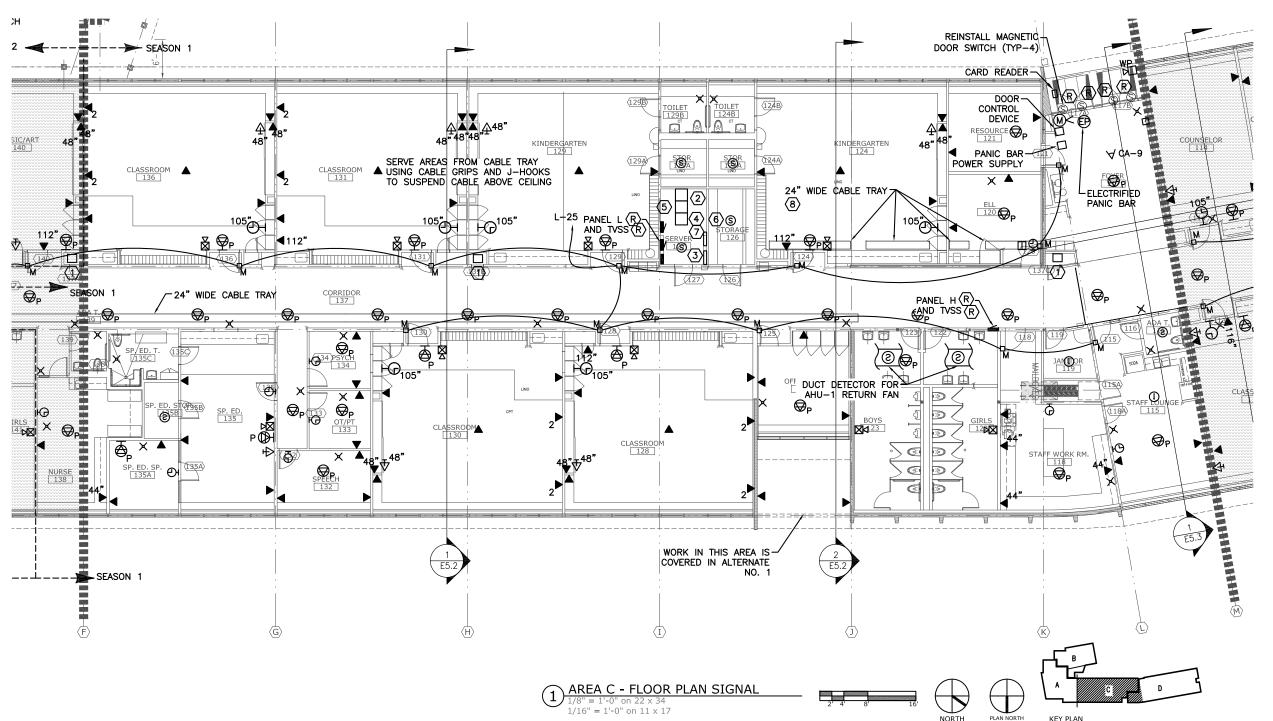
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DATE: NOV. 15, 2010

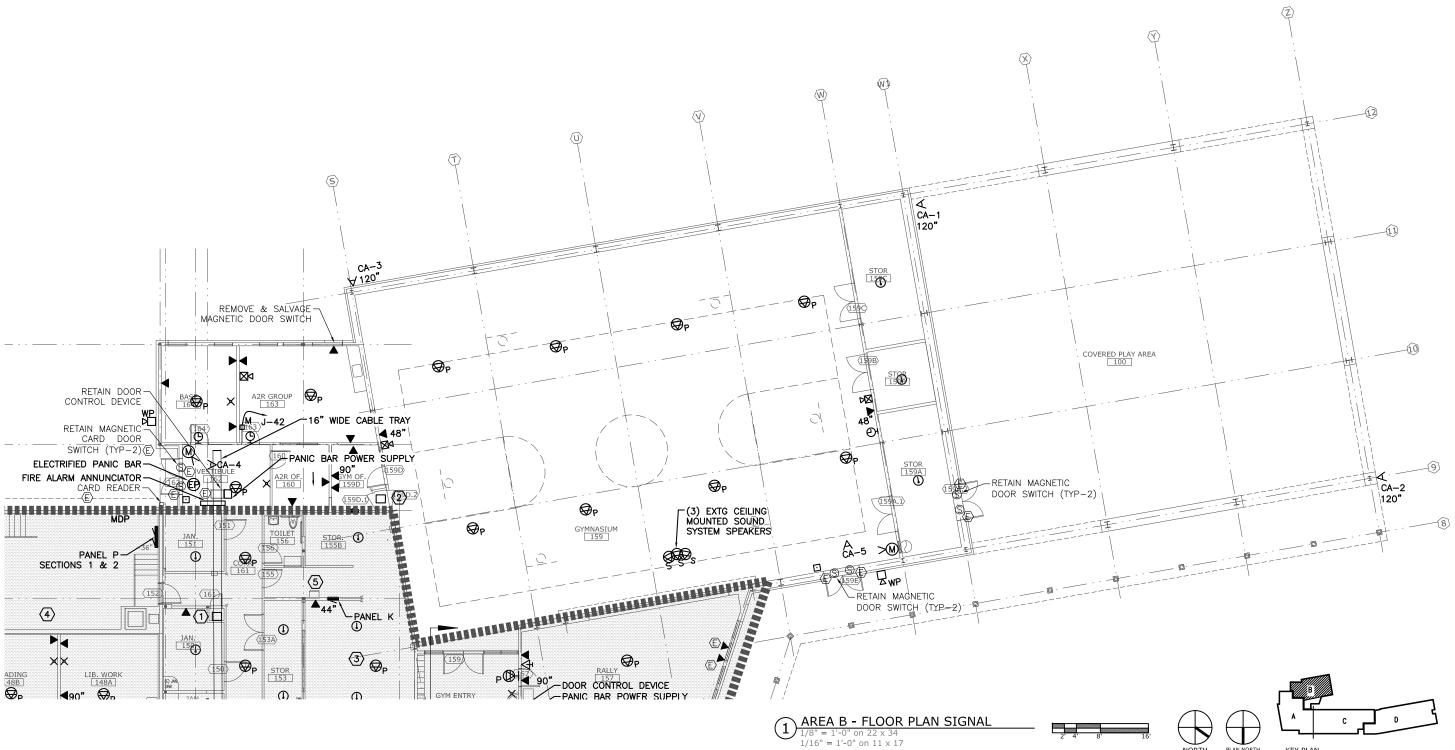- (1) WALL MOUNT NETWORK RACK
- (2) NETWORK DATA RACK
- 3 TELEPHONE TERMINAL BOARD
- 4 INTERCOM HEAD END EQUIPMENT MOUNTED IN A NETWORK RACK
- (5) VIDEO SURVEILLANCE SYSTEM MOUNTED IN A NETWORK RACK
- $\ensuremath{\overleftarrow{\texttt{6}}}\xspace$ motion detection system panel. Relocate existing motion sensors where shown
- 7 CARD ACCESS HEAD END EQUIPMENT
- (8) START AND STOP TRAY BETWEEN CEILING JOISTS AND MECHANICAL EQUIPMENT AS REQUIRED. SUPPORT CABLES FROM J-HOOKS ON CEILING WHERE TRAY STOPS. ROUTE AROUND BUILDING STRUCTURE AND MECHANICAL EQUIPMENT.







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ELEMENTARY

SHEET TITLE:

AREA C
FLOOR PLAN
SIGNAL


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revision: Checked by:

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E4.2

- 1 WALL MOUNT NETWORK RACK
- (2) ROUTE CABLES ACROSS GAP IN CABLE TRAY. SUPPORT CABLES USING CABLE GRIPS SUSPENDED FROM THE TRUSSES OR CEILING.





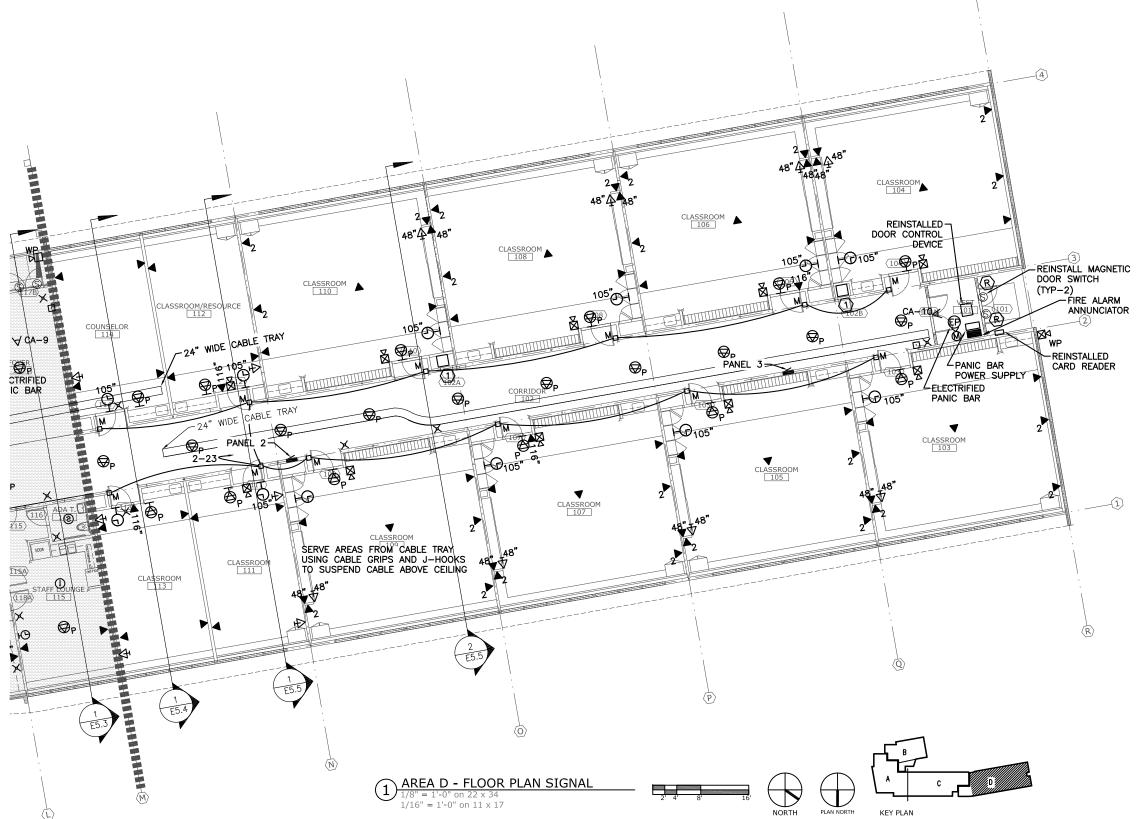

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SCHOOL LABELED S

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SHEET TITLE:

AREA D
FLOOR PLAN
SIGNAL

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DATE: NOV. 15, 2010


REVISION: CHECKED BY:

CKED BY: MGM
NN: DMP

E4.3

- PROVIDE AN ADDRESSABLE MAIN FACP. SIMPLEX 4100U OR APPROVED EQUAL. PROVIDE ADDRESSABLE HORN STROBES ON THE INDICATING CIRCUITS.
- PROVIDE SHOP DRAWINGS DURING SUBMITTALS. AFTER 2. CONSTRUCTION, PROVIDE AS-BUILTS SHOWING ALL CIRCUITING. SHOW WHICH DEVICES ARE ON EACH IDC CIRCUIT, AND WHICH DEVICES ARE ON EACH NAC CIRCUIT. SHOW ALL CIM AND ALL OTHER CONTROL WIRING. PROVIDE (3) SETS OF AS-BUILT DRAWINGS TO THE ENGINEER.
- 3. ROUTE ALL WIRING IN CONDUIT. ALL WIRING SHALL BE RED JACKETED FIRE ALARM CABLE, PERFORM INDICATING DEVICE CIRCUIT LOAD CALCULATIONS PRIOR TO CONSTRUCTION. SIZE CONDUCTORS BASED ON THE LOAD CALCULATIONS. ALL CIRCUITS SHALL USE NO. 14 AWG CONDUCTORS MINIMUM. LABEL EACH CONDUCTOR IN EVERY J-BOX WITH ITS CIRCUIT DESIGNATION, PAINT J-BOX COVERS RED.
- WHEN HORNS ARE SILENCED, THEY SHALL ALL SILENCE 4. TOGETHER. WHEN THE SYSTEM IS RESET, THE INDICATING CIRCUITS SHALL ALL RESET TOGETHER. ALL STROBES AND HORN STROBES VIEWABLE FROM ANY ONE POINT IN THE BUILDING SHALL BE SYNCHRONIZED TOGETHER.
- 5. THE FIRE ALARM SYSTEM DEVICES AND PANEL SHALL BE LOCATED AND INSTALLED PER THESE DRAWINGS, THE SPECIFICATIONS, AND PER THE SHOP DRAWINGS PROVIDED BY THE FIRE ALARM MANUFACTURER'S DISTRIBUTOR THAT HAVE BEEN APPROVED BY THE ENGINEER DURING THE SUBMITTAL PROCESS. NO DEVIATIONS FROM THESE DOCUMENTS MAY BE MADE WITHOUT THE WRITTEN CONSENT OF THE ENGINEER.
- THE FIRE ALARM DEVICES AND PANEL SHALL BE INSTALLED BY AN INSTALLER CERTIFIED BY THE STATE OF ALASKA TO INSTALL FIRE ALARM SYSTEMS. THE SYSTEM PROGRAMMING, TESTING, AND CERTIFICATION SHALL BE DONE BY A MANUFACTURER CERTIFIED TECHNICIAN EMPLOYED BY THE MANUFACTURER'S DISTRIBUTOR THAT SUPPLIED THE FIRE ALARM SYSTEM MATERIALS FOR THE
- 7 THE ADDRESS FOR EACH INITIATING DEVICE SHALL BE PROGRAMMED IN THE BASE OF EACH INITIATING DEVICE (SMOKE OR HEAT DETECTOR), NOT IN THE DEVICE ITSELF. A DEVICE SHALL BE ABLE TO BE REPLACED WITHOUT HAVING TO PERFORM ANY PROGRAMMING. PROVIDE CIRCUIT INTERFACE MODULES TO PROVIDE ADDRESSABILITY FOR ALL NON-ADDRESSABLE INITIATING & OTHER DEVICES (FLOW & TAMPER SWITCHES, FAN MOTOR STARTERS, ETC). PROVIDE ONE CIM PER DEVICE.
- PROVIDE STROBE INTENSITIES AS REQUIRED TO MEET NFPA 72.
- ALL DEVICES SHALL BE TESTED AND SOUND READINGS OF THE AMBIENT AND ALARM LEVELS SHALL BE TAKEN IN EVERY ROOM OF THE BUILDING. A WRITTEN REPORT OF THE TEST OF EVERY DEVICE PRODUCED BY THE SYSTEM SHALL BE PROVIDED TO THE ENGINEER 7 DAYS PRIOR TO REQUESTING A FINAL INSPECTION.

INDICATING DEVICES (HORN STROBES) INITIATING DEVICES (SMOKES, HEATS, PULL STATIONS) (NAC CKTS) (IDC CKTS)

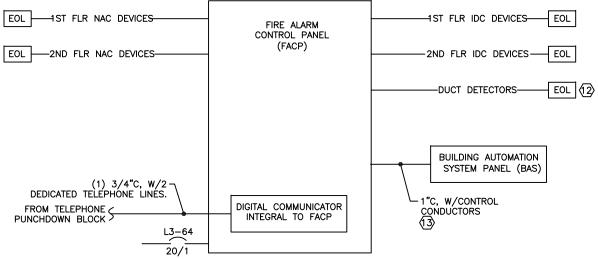

FIRE ALARM RISER DIAGRAM NO SCALE

NOTES (CON'T):

- 10. PROVIDE END OF LINE RESISTORS ON THE IDC CIRCUITS THAT CONTAIN CIRCUIT INTERFACE MODULES AS REQ'D. PROVIDE END OF LINE RESISTORS ON OTHER FACP CIRCUITS AS NECESSARY TO MEET NFPA 72.
- 11. ALL DEVICES SHALL BE FLUSH MOUNTED AT THE HEIGHTS INDICATED ON THE LEGEND. DEVICES MAY BE SURFACE MOUNTED ONLY IF SPECIFICALLY NOTED. THERE SHALL BE NO CHANGE TO THE LOCATION OR MOUNTING HEIGHT EXCEPT WITH WRITTEN PERMISSION FROM THE ENGINEER.
- 12 DUCT DETECTORS SHALL SHUTDOWN FANS DURING AN ALARM. PROVIDE FACP PROGRAMMING AS REQUIRED. COORD. W/MECH. AS
- PROVIDE CIRCUITS AND SYSTEM PROGRAMMING TO SHUT DOWN DDC CONTROLLED FANS DURING A FIRE ALARM. COORD. WITH MECH.

- 14. PROVIDE RELAY MODULES TO TRIP THE 120V CIRCUITS POWERING THE MAGNETIC DOOR HOLDERS.
- SEASON 1 PROVIDE FIRE ALARM CONTROL PANEL AND FIRE ALARM DEVICES IN AREAS C & D. CONNECT EXISTING FIRE ALARM SYSTEM TO NEW PANEL SO EITHER PANEL IN ALARM CAUSES THE OTHER PANEL TO BE IN ALARM. CONNECT DIGITAL COMMUNICATOR TO TELEPHONE PUNCHDOWN BLOCKS IN SERVER ROOM.
 COORDINATE WITH MONITORING SERVICE AND TEST COMMUNICATOR.

SEASON 2 - REMOVE REMAINDER OF EXISTING FIRE ALARM SYSTEM AND PROVIDE FIRE ALARM DEVICES IN AREAS A & B.

FIRE ALARM LEGEND DESCRIPTION MOUNTING HT. . PULL STATION 48" AFF HORN STROBE 86" AFF (8) SMOKE DETECTOR CEILING STROBE ONLY 86" AFF HEAT DETECTOR. RATE OF RISE. CEILING FIRE ALARM CONTROL PANEL JUNCTION BOX TAMPER SWITCH FLOW SWITCH (PRESSURE) (BOTH HI & LOW) END OF LINE RESISTOR CIRCUIT INTERFACE MODULE DUCT SMOKE DETECTOR INSIDE DUCT TKI HORN ONLY 86" AFF NOTIFICATION APPLIANCE CIRCUIT INITIATING DEVICE CIRCUIT





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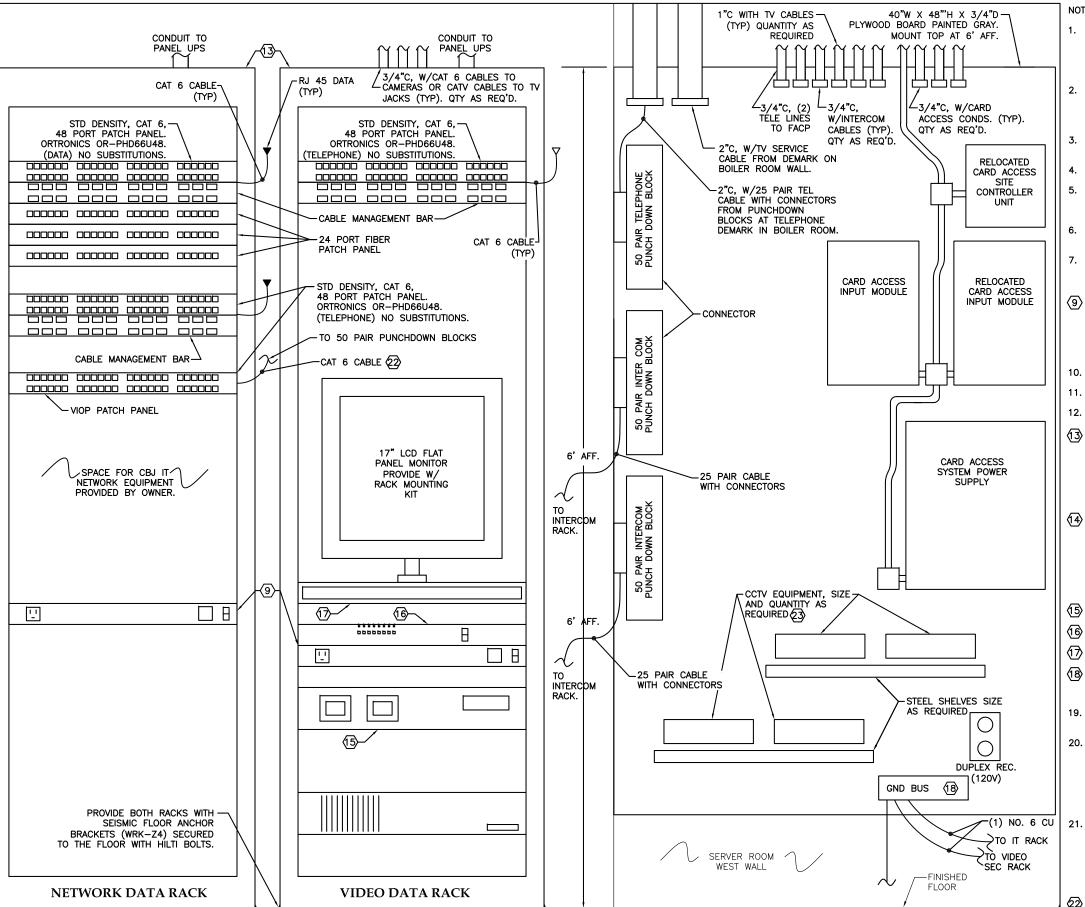
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RISER DIAGRAMS 1

DATE: NOV. 15, 2010


RÉVISION:



- ROUTE A PRECONNECTORIZED 25 PAIR TELEPHONE CABLE FROM PUNCHDOWN BLOCK IN BOILER ROOM. TERMINATE ON PRECONNECTORIZED PUNCHDOWN BLOCKS ON PLYWOOD BOARD IN SERVER ROOM. CROSS CONNECT TO CABLES FEEDING VOIP PATCH PANEL. SEE NOTE 22, THIS SHEET.
- TERMINATE ALL CAT 6 CABLES FROM DATA JACKS ON PATCH PANELS. OWNER TO PROVIDE IT NETWORK EQUIPMENT IN RACK SUPPLIED BY CONTRACTOR. PROVIDE PATCH PANELS, OUTLET STRIP, AND CABLE MANAGEMENT AS INDICATED.
- PROVIDE CAT 6 WIRING BETWEEN THE TELEPHONE PUNCHDOWN BLOCKS AND A 48 PORT PATCH PANEL
- CONNECT TWO PHONE LINES TO FIRE ALARM CONTROL PANEL.
- PROVIDE CABLE MANAGEMENT IN BOTH RACKS TO NEATLY TRAIN CABLES FROM CONDUIT NIPPLES IN CEILING, THROUGH RACKS TO THE PATCH PANELS
- PROVIDE A LABEL AT EACH JACK AND EACH PORT OF THE PATCH PANEL. LABEL NUMBERING CONVENTION PER OWNER.
- AFTER TERMINATING CAT 6 CABLES AT JACKS AND PATCH PANELS, TEST CABLES PER CAT 6 EIA/TIA STANDARDS AND PER THE SPECIFICATIONS. PROVIDE ELECTRONIC AND HARD COPIES OF TEST REPORTS. REPLACE CABLES THAT FAIL THE TEST.
- 15 AMP, 14 RECEPTACLE, 2 STAGE SURGE SUPPRESSOR OUTLET STRIP. MIDDLE ATLANTIC PRODUCTS PD-1415C OR EQUAL. POWER OUTLET STRIP FROM DEDICATED UPS RECEPTACLE. POWER ALL RACK EQUIPMENT FROM THE OUTLET STRIP. PROVIDE (1) OUTLET STRIP FOR
- 10. ALL CABLES DO NOT HAVE TO BE PLENUM RATED.
- 11. USE WHITE CABLING FOR ALL JACKS.
- PROVIDE 125 WHITE CAT 6 PATCH CORDS WITH FACTORY INSTALLED MALE CONNECTORS. 50 @ 18", 25 @ 3', 25 @ 7', 25 @ 10'.
- PROVIDE (2) 19" EIA, 26" DEEP, 70" HIGH FLOOR MOUNTED RACKS WITH 40 RACK UNITS CAPACITY MIN (40RU). (1) RACK FOR CBJ IT NETWORK EQUIPMENT. (1) RACK FOR VIDEO SECURITY SYSTEM EQUIPMENT. MIDDLE ATLANTIC PRODUCTS MRK-4026 OR EQUAL. PROVIDE WITH LOCKABLE FRONT DOOR, SOLID SIDE AND BACK DOORS AND WITH 10" TOP MOUNT FAN WITH INTEGRAL THERMOSTAT FOR ACTIVE THERMAL MANAGEMENT.
- SEASON 1 PROVIDE NEW DATA EQUIPMENT IN AREAS C & D. CONNECT RELOCATED NETWORK RACK FROM ROOM 29 INTO CLASSROOM 22 FOR INTERIM SCHOOL YEAR. CONNECT EXISTING DATA RACK IN COMPUTER ROOM 147. RECONNECT EXISTING DATA JACKS IN AREAS A & B THAT WERE CONNECTED TO THE RACK IN ROOM 29. SEASON 2 - PROVIDE NEW DATA EQUIPMENT IN AREAS A AND B WHERE SHOWN. DISCONNECT EXISTING RACK N COMPUTER ROOM TO ALLOW CONSTRUCTION, THEN RECONNECT.
 - DIGITAL VIDEO RECORDER (2 RACK UNITS).
- PoE NETWORK SWITCH (1 RACK UNIT).
- PROVIDE RACK WITH SLIDE OUT KEYBOARD TRAY (1 RACK UNIT).
- PROVIDE (1) NO. 2 INSULATED GROUND FROM BLDG. SERVICE GROUND TO GROUND BUS AT TELE TERMINAL BACKBOARD.
- 19. NOT ALL CONDUITS ARE SHOWN. PROVIDE ADDITIONAL CONDUIT AS REQUIRED. ADJUST LAYOUT FROM WHAT IS SHOWN AS NECESSARY.
- 20. PROVIDE THE FOLLOWING RECEPTACLES, FACEPLATES, JACKS AND INSERTS FOR ALL TELE/DATA RECEPTACLES. NO SUBSTITUTIONS:

ORTRONICS OR-40300158 FACE PLATES: SINGLE JACK INSERTS: ORTRONICS OR-S21600 ORTRONICS OR-S22600 DOUBLE JACK INSERTS: OR-40300164 BLANK INSERTS:

- SEASON 1 INSTALL CARD ACCESS SYSTEM IN AREAS C AND D. REMOVE, SALVAGE, AND REINSTALL EXISTING CARD ACCESS EQUIPMENT IN AREAS C & D. PROVIDE NEW EQUIPMENT AS SHOWN. RECONNECT EXISTING CARD ACCESS SYSTEM EQUIPMENT IN AREAS A & B TO HEAD END EQUIPMENT IN SERVER ROOM. SEASON 2 - PROVIDE CARD ACCESS SYSTEM IN AREAS A AND B. REMOVE, SALVAGE AND REINSTALL EXISTING EQUIPMENT. PROVIDE NEW EQUIPMENT AS SHOWN.
- TERMINATE 25 CABLES ON 50 PAIR PUNCHDOWN BLOCK AND ON TELEPHONE PATCH PANEL. CONNECT CENTER TWO PINS TO EACH **2**2
 - PROVIDE A BLONDER TONGUE CLOSED CIRCUIT TV SYSTEM. SEE E4.10. MOUNT EQUIPMENT ON STEEL SHELVES THAT CAN'T BE RACK MOUNTED

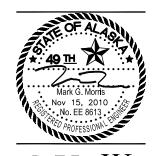



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SCHOOL ELEMENTARY

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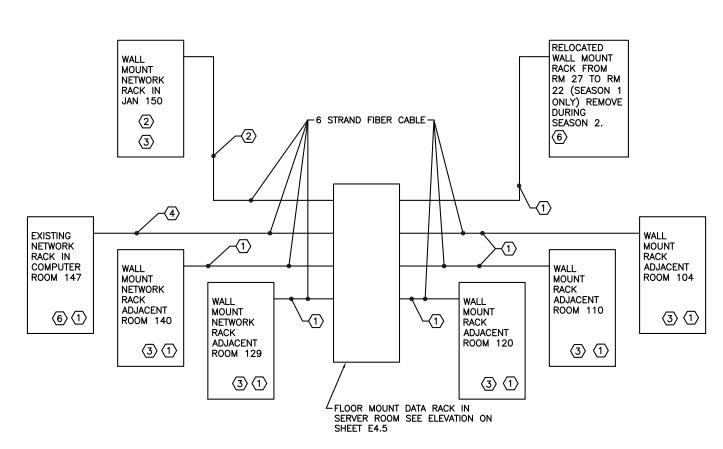
RISER DIAGRAMS 2

DATE: NOV. 15, 2010

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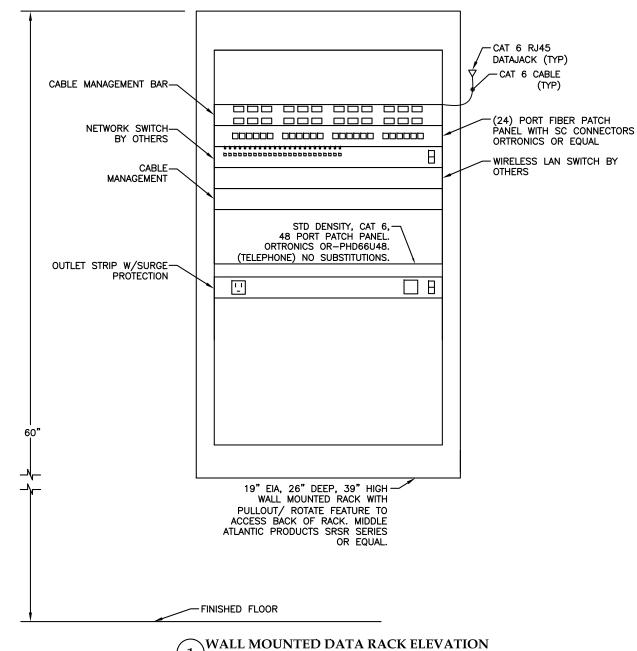
SERVER ROOM EQUIPMENT ELEVATION NO SCALE




1 NETWORK SCHEMATIC

NOTES:

- 1 SEASON 1 WORK.
- (2) SEASON 2 WORK.
- 3 SEE ELEVATION ON THIS SHEET
- THIS CONNECTION SHALL BE MADE IN SEASON 1, THEN REMOVED AT BEGINNING OF SEASON 2 AND REINSTALLED AFTER COMMONS IS CONSTRUCTED.
- 5. PROVIDE A HOME RUN FROM EVERY DATA JACK TO THE NEAREST WALLMOUNT NETWORK RACK. ALL JACKS IN ONE ROOM SHALL BE ROUTED TO ONE RACK
- (6) ADD A 24 PORT FIBER PATCH PANEL IN THIS RACK. SAME TYPE AS SHOWN ON RACK ELEVATION THIS SHEET.



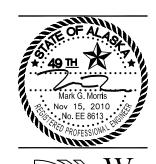



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SHEET TITLE:
RISER DIAGRAMS 3

DATE: NOV. 15, 2010

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E4.6

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- BACKBONE DATA CABLE. (1) NO. 22 STP WITH DRAINWIRE. BELDEN 82761
- POWER SUPPLY CABLE. (1) 2 NO. 16 COND. CABLE. BELDEN 6200UE OR EQUAL.
- ROUTE ALL CABLES & CONDUCTORS IN CONDUIT UNLESS IN CABLE TRAY ABOVE SUSPENDED CEILING. PROVIDE CONDUIT, J-BOXES, ETC. AS
- CARD READER CABLE. (1) 8 SHIELDED NO. 22 COND. CABLE. BELDEN 6506FE OR EQUAL. RÈWIRE EXISTING DOOR SWITCHES AS REQUIRED TO ROUTE CABLE TO RELOCATED HEAD END EQUIPMENT.
- DOOR SWITCH CABLE. (1) 4 NO. 22 COND. CABLE. BELDEN 6502UE OR EQUAL. REWIRE EXISTING DOOR SWITCHES AS REQUIRED
- EXISTING SITE CONTROLLER FOR MANAGING & POWERING DOOR CONTROL DEVICES. LENEL L-500. CONTROL VIA EXISTING SOFTWARE. MOUNT ON TTB BOARD, ROOM 127
- DOOR CONTROL DEVICE TO CONTROL CARD READERS, ELECTRIFIED PANIC (18) BARS, ETC. PROVIDE IN STANDARD BACK BOX. LENEL L-1320.
- 12VDC, 5 AMP SYSTEM POWER SUPPLY IN LOCKABLE NEMA 1 ENCLOSURE. LENEL LNL-AL400ULX. PROVIDE WITH BATTERY KIT ABT-12. (19) MOUNT ON TTB, ROOM 127.
- 9 1/2"C, 2 NO, 12 TO HINGE, 2 NO. 12 CABLE TO ELECTRIFIED PANIC BAR. WEST PENN WPW-227.
- WEATHERPROOF, LOW PROFILE, PROXIMITY CARD READER. 125 KHZ, COMPATIBLE WITH 26-BIT WIEGAND CARD FORMAT. MOUNTS DIRECTLY TO STANDARD SINGLE GANG BOX. HID THINLINE 2 5395 OR EQUAL. TYPICAL, UNLESS NOTED OTHERWISE.
- NOT USED
- MAGNETIC DOOR SWITCH INPUT MODULE LNL-1100.

NOTES (CON'T):

- (13) ELECTRIC HINGE
- 14. FURNISH 100 BLANK PROXIMITY CARDS TO OWNER, 125 KHZ, ISO STANDARD CARDS, HID CORP. ISOPROX II 1386 OR EQUAL. FURNISH 50 BLANK PROXIMITY KEY FOB TO OWNER. 125 KHZ, ISO STANDARD KEY FOB. HID CORP. PROXKEY II FOB 1346 OR EQUAL.
- PROGRAM ACCESS CONTROL SYSTEM PER OWNER'S REQUIREMENTS WITH FEATURES AND FUNCTIONALITY FOR OPERATING, MAINTAINING, AND UPDATING DOOR CONTROL DEVICES THROUGHOUT THE BUILDING. CONNECT SYSTEM TO SCHOOL COMPUTER NETWORK.
- 16. 2 DIGITAL INPUT, 2 FORM "C" RELAY OUTPUT CONTROL MODULE. ELK PRODUCTS, INC. ELK-MM220 OR EQUAL. PROGRAM AS REQ'D TO CONTROL CONNECTED DEVICES.
- ADA OPERATOR; (1) EXTERIOR AND (1) INTERIOR. SEE ARCHITECTURAL. DURING NORMAL BUSINESS HOURS ÓPERATORS SHALL CONTROL MOTORIZED DOOR OPERATOR. DURING NON-BUSINESS HOURS, EXTERIOR OPERATOR SHALL CONTROL DOOR ONLY AFTER VALID CARD READ IS MADE. PROVIDE CIRCUITING & PROGRAMMING AS REQ'D.
- PROVIDE MIN. 18" ARMORED CABLE CORD FROM DOOR FRAME TO HINGE SIDE OF DOOR. SECURITRON TSB-C DOOR CORD OR EQUAL. ROUTE REX AND ELECTRIFIED PANIC FEEDER CABLES IN CORD FROM DOOR CONCEALED UP INTO CEILING.
- MAGNETIC DOOR CONTACT SWITCH. SEE ARCHITECTURAL. CIRCUIT AS SHOWN
- PROVIDE LOCAL 12VDC POWER SUPPLY TO FEED THE ELECTRIFIED PANIC HARDWARE. STANLEY APEX2000 ELR-150 POWER SUPPLY OR EQUAL. PROVIDE WITH BATTERY BACKUP
- POWER SUPPLY CABLE. (1) 2 NO. 12 COND. CABLE. PLENUM RATED. BELDEN 6000UE OR
- ACCESS CONTROL EQUIPMENT & CIRCUITING IS SHOWN ON FLOOR PLANS DUE TO SPACE. PROVIDE AND CONNECT EQUIPMENT AS SHOWN IN SCHEMATIC, ON FLOOR PLANS, AND AS REQUIRED TO PROVIDE A COMPLETE, OPERATIONAL SYSTEM. MOUNT DEVICES IN CONCRETE BUILDING EXTERIOR AS REQUIRED. SEAL AROUND ALL EXTERIOR DEVICES. CONCEAL ALL WIRING. FLUSH MOUNT ALL DEVICES UNLESS OTHERWISE NOTED.

	ACCESS CONTI	ROL LEGEND
	DESCRIPTION	MOUNTING LOCATION/HT. (TYP)
DCD	DOOR CONTROL DEVICE	CONCEALED ABOVE CEILING
REX	REQUEST-TO-EXIT	
OPR	DOOR OPERATOR	
TDM	TIME DELAY MODULE	
(ADA)	ADA OPERATOR*	FLUSH IN WALL
(EP)	ELECTRIFIED PANIC BART	IN DOOR
(S)	MAGNETIC DOOR SWITCH*	IN DOOR
PP	PANIC HARDWARE POWER	CONCEALED ABOVE CEILING
M	CONTROL MODULE	CONCEALED ABOVE CEILING
EM	ELECTRIC MORTISE	IN DOOR HANDLE ASSEMBLY
\bowtie	CARD READER (10)	48" AFF
\boxtimes	DOOR CONTROL DEVICE (7)	CONCEALED ABOVE CEILING

CARD ACCESS SYSTEM SCHEMATIC

* DEVICE SPECIFIED IN ARCHITECTURAL COORDINATE INSTALLATION WITH GENERAL





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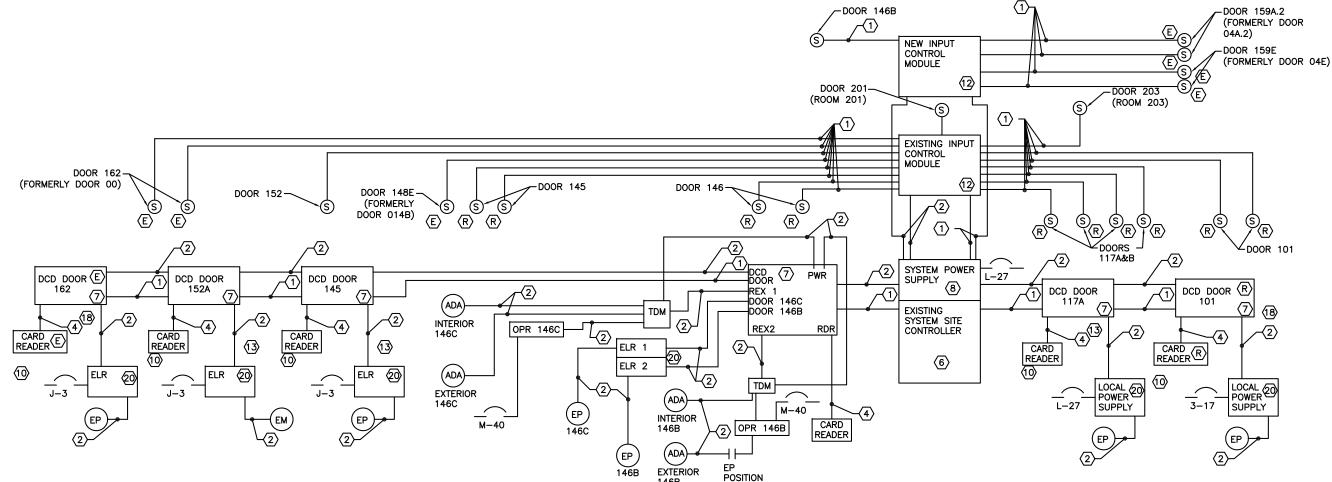


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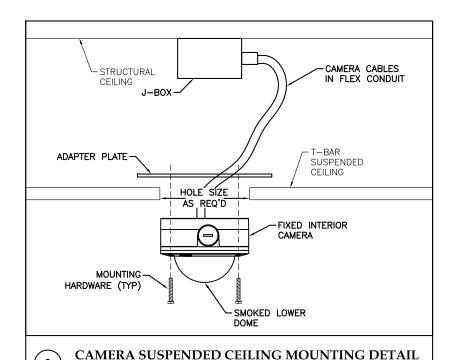
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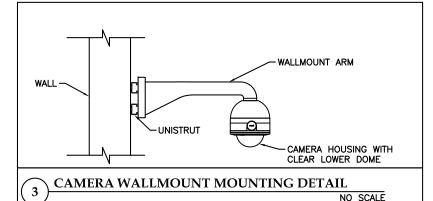
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SWITCH




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- NOTES:
- THIS DETAIL IS A GENERAL GUIDELINE ONLY. PROVIDE CAMERA CEILING MOUNT KIT & MOUNTING HARDWARE PER CAMERA MANUFACTURER REQUIREMENTS
- 2. LOCATE CAMERAS TO AVOID OBSTACLES AND PROVIDE AIMING PER CAMERA EQUIPMENT SCHEDULE.




NOTES:

- THIS DETAIL IS A GENERAL GUIDELINE ONLY. PROVIDE CAMERA WALL MOUNT KIT & MOUNTING HARDWARE PER CAMERA MANUFACTURER REQUIREMENTS.
- LOCATE CAMERAS TO AVOID OBSTACLES AND PROVIDE AIMING PER CAMERA EQUIPMENT SCHEDULE.
- FEED WITH FLEX CONDUIT FROM J-BOX MOUNTED NEXT TO CAMERA ON WALL

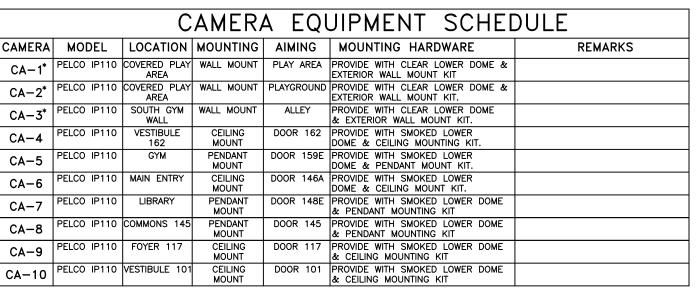


NOTES:

- INSTALL CAMERAS PER DETAILS, THIS SHEET, AND PER MANUFACTURER WRITTEN INSTRUCTIONS.
 - * PROVIDE CAMERA IN WEATHERPROOF, OUTDOOR ENCLOSURE WITH HEATER AND FAN.
- ALL VIDEO SECURITY SYSTEM WORK IS IN ALTERNATE NO. 7.
- PROVIDE HEAD END EQUIPMENT AND CAMERAS IN AREA C & D DURING SEASON 1. PROVIDE CAMERAS IN AREAS A & B IN SEASON 2.

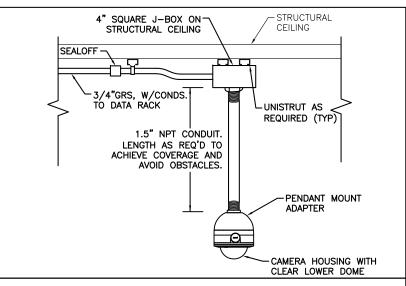

CAMERA PENDANT MOUNTING DETAIL NO SCALE

NOTES:

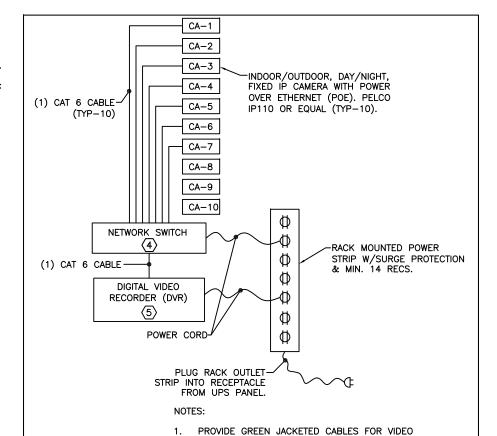

SECURITY SYSTEM CAT 6 CABLES. ALL VIDEO SECURITY

SYSTEM CABLING SHALL BE PLENUM RATED.

MOUNTED EQUIPMENT RACK. SEE VIDEO RACK

ELEVATION SHEET E4.06.

SFE2000P OR EQUAL.

VIDEO SECURITY SCHEMATIC

NOT USED.

PROVIDE VIDEO SECURITY EQUIPMENT IN A FLOOR

24 PORT 10/100 ETHERNET SWITCH WITH POWER OVER INTERNET (IEEE802.3AF) CAPABILITY. LINKSYS

16 CHANNEL, 1000GB DIGITAL VIDEO RECORDER. PELCO DVR5104DVD-1000. PROVIDE WITH LCD FLAT

PROVIDE ALL DVR AND VIDEO SYSTEM PROGRAMMING

NO SCALE

AS NECESSARY FOR COMPLETE SETUP OF VIDEO SECURITY SYSTEM, INCLUDING STANDARD CAMERA SETUP WORK, RECORDING LOOP SETUP, ETC.

Nov 15, 2010 .No. EE 8613 PROFESSIONAL



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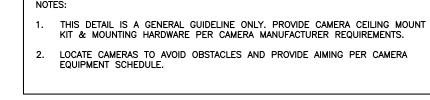
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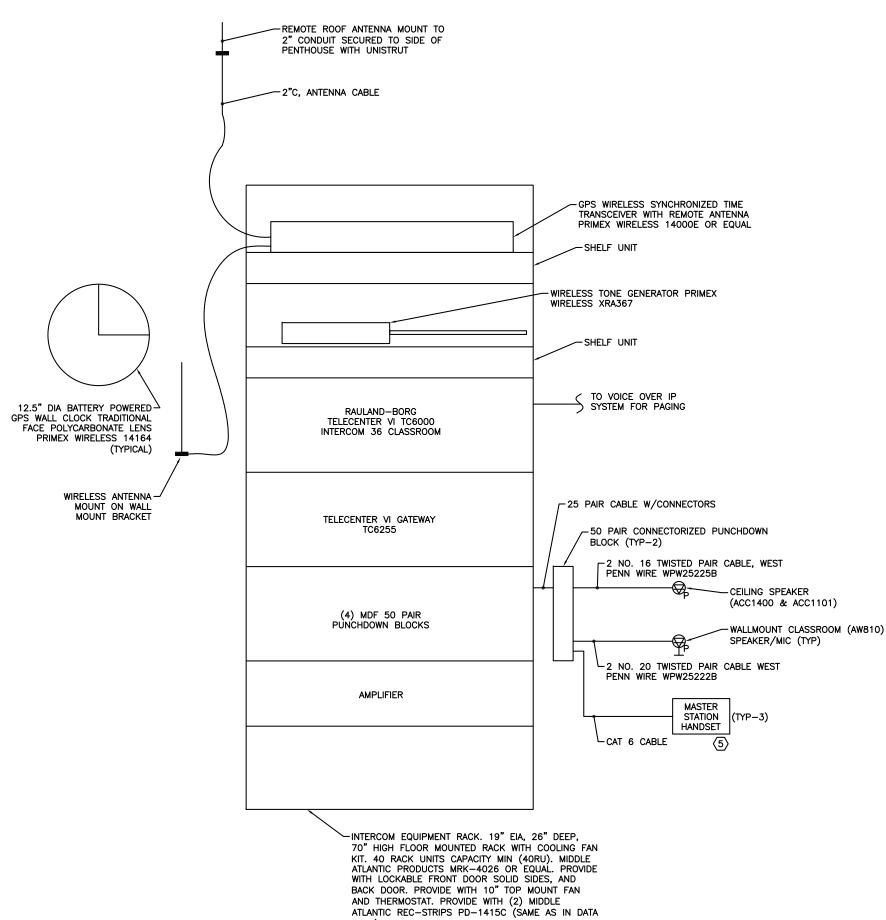
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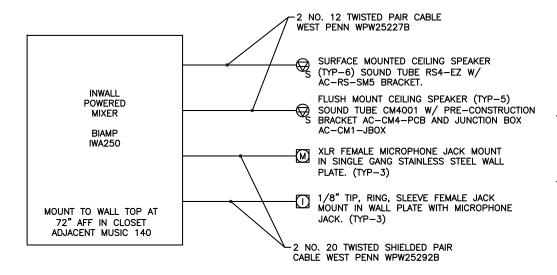
RISER DIAGRAMS 5

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RÉVISION:







- 1. PROVIDE A DEDICATED HOME RUN FOR EACH CLASSROOM SPEAKER/MIC AND FOR EACH CALL SWITCH.
- 2. UP TO (10) CEILING SPEAKERS MAY BE INSTALLED ON ONE HOME RUN.

COMMONS SOUND SYSTEM SCHEMATIC

- 5. DURING SEASON 1, PROVIDE 12 CEILING SPEAKERS IN AREA A AND B FOR INTERIM SCHOOL YEAR. INSTALL WHERE DIRECTED BY OWNER. INSTALL CABLES ABOVE SUSPENDED CEILING ON J HOOKS FROM STRUCTURAL CEILING.
- DURING SEASON 2, INSTALL SPEAKERS IN AREAS A & B WHERE SHOWN.
- PROVIDE A HANDSET IN THE ADMIN OFFICE, NURSES OFFICE, AND NEXT TO COMMONS SOUND SYSTEM. WALL MOUNT UNIT AT COMMONS SOUND SYSTEM





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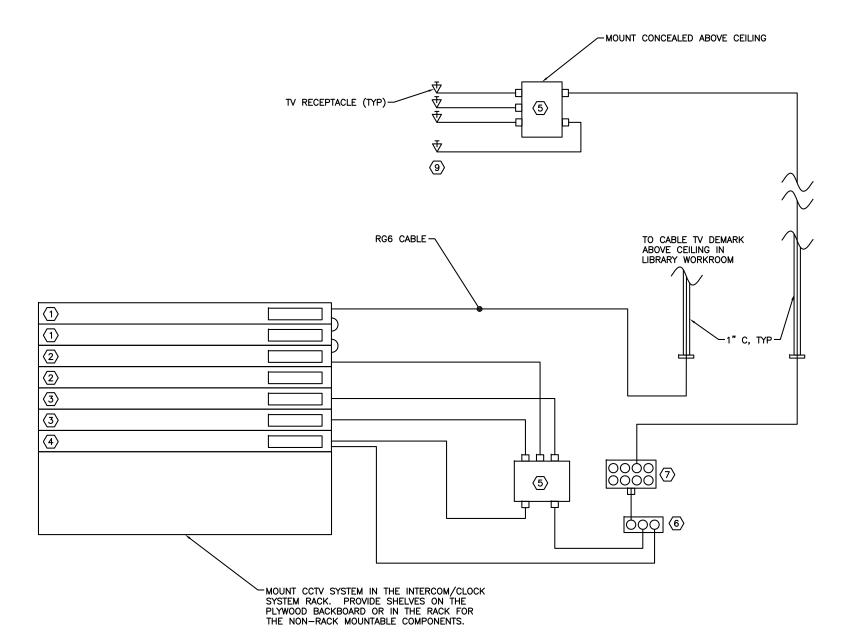
RISER DIAGRAMS 6

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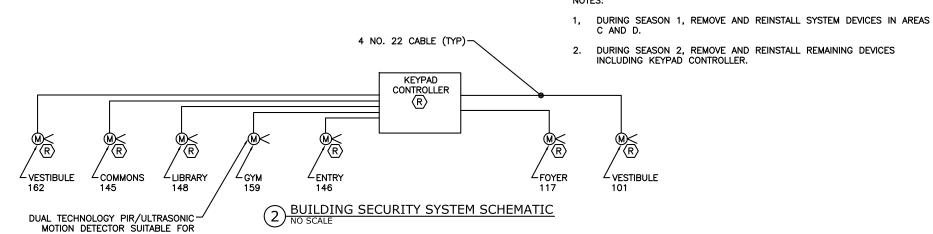


USE WITH EXISTING SYSTEM

NOTES:

- (1) RACK MOUNT CHANNEL ELIMINATION FILTER. BLONDER TONGUE
- RACK MOUNT DISTRIBUTION AMPLIFIER. BLONDER TONGUE RMDA SERIES
- CHANNELIZED AGILE MODULATOR AUDIO/VIDEO. BLONDER TONGUE MAVM SERIES
- (4) HETERODYNE PROCESSOR. BLONDER TONGUE AP SERIES
- FOUR WAY SPLITTER. BLONDER TONGUE SXRS-4
- MUX DEVICE. BLONDER TONGUE DSV SERIES
- EIGHT WAY SPLITTER. BLONDER TONGUE SXRS-8
- PROVIDE A CLOSED-CIRCUIT TELEVISION SYSTEM WITH TV RECEPTACLES IN ALL OF THE LOCATIONS SHOWN ON THE FLOOR PLANS. PROVIDE THE SYSTEM WITH THE CAPABILITY OF RECEIVING A SIGNAL FROM A CABLE TV SOURCE, A DVD PLAYER, TV CAMERA AND A DIGITAL VIDEO DEVICE (IPOD, ETC.). THE SYSTEM SHALL HAVE THE CAPABILITY TO OUTPUT A SIGNAL TO BE RECORDED BY A DVD RECORDER OR VIDEO RECORDING DEVICE. THE SYSTEM SHALL USE BLONDER TONGUE EQUIPMENT OR AN APPROVED EQUAL. THE SYSTEM SHALL HAVE THE MINIMUM COMPONENTS SHOWN. PROVIDE A DESIGN BY BLONDER TONGUE LABORATORIES, INC, 1-800-523-6049. PROVIDE CIRCUITING PER MANUFACTURER'S INSTRUCTIONS. PROVIDE ALL WIRING AND ADDITIONAL COMPONENTS NOT SHOWN HERE FOR A FULLY FUNCTIONAL SYSTEM. INCREASE CABLE SIZE, SPLITTER CONFIGURATOIN OR QUANTITY AS REQUIRED.
- (9) TV RECEPTACLE. LOCATE WHERE SHOWN ON THE FLOOR PLANS. LEVITON 40539-OMW OR EQUAL.

(1) CLOSED CIRCUIT TELEVISION (CCTV) SYSTEM SCHEMATIC



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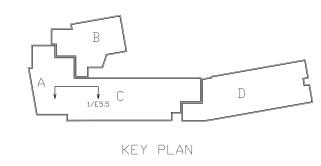
SCHOOL GASTINEAU ELEMENTARY RENOVATION


RISER DIAGRAMS 7

DATE: NOV. 15, 2010

RÉVISION:

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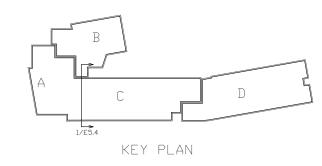
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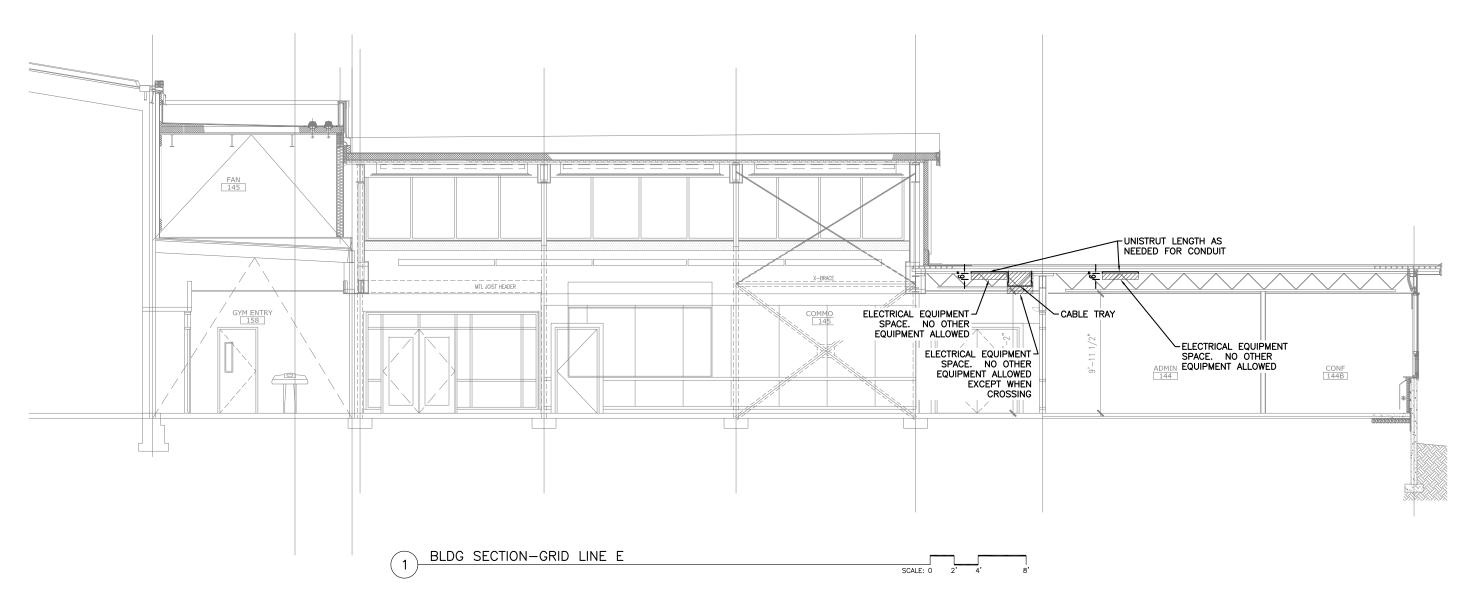
BUILDING SECTIONS 1

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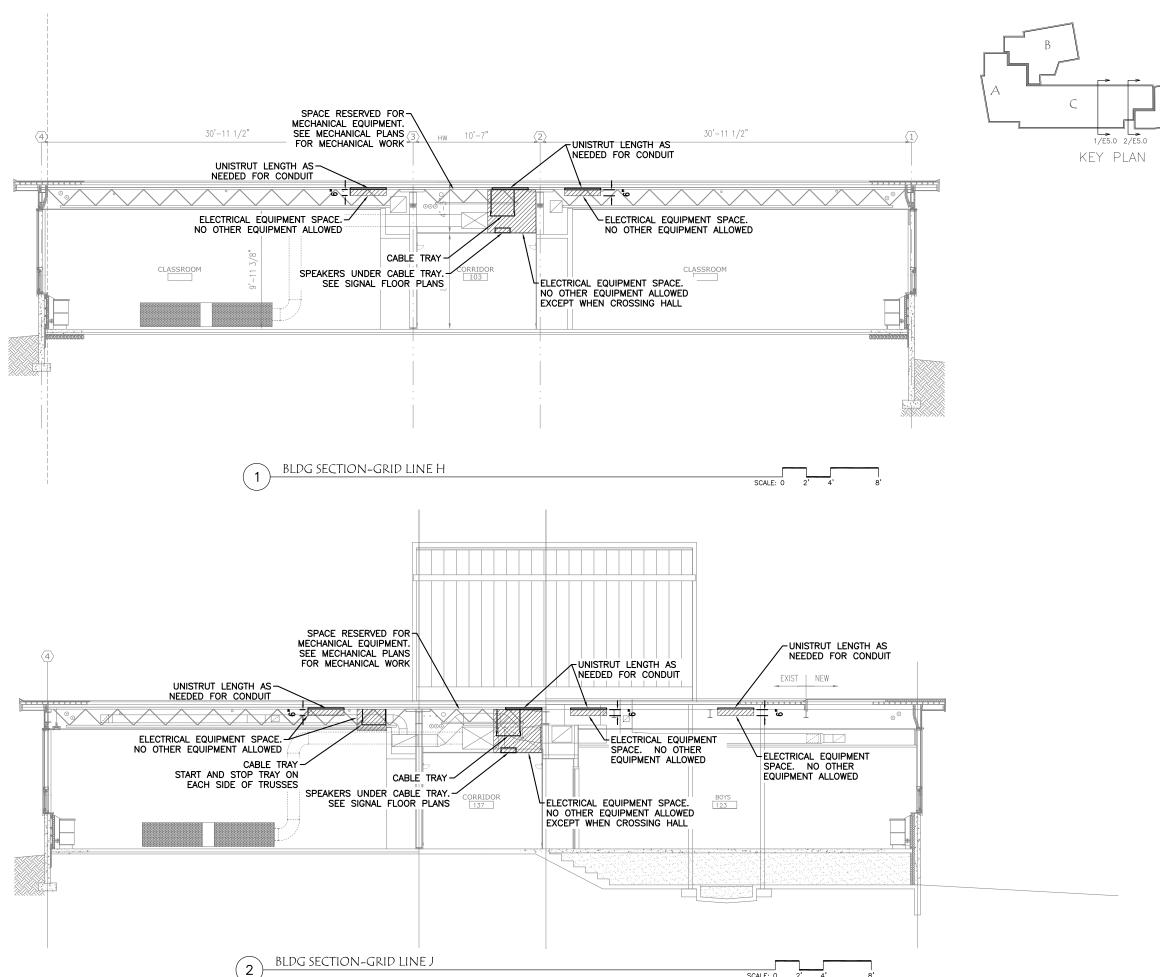
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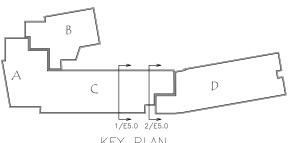
DATE: NOV. 15, 2010

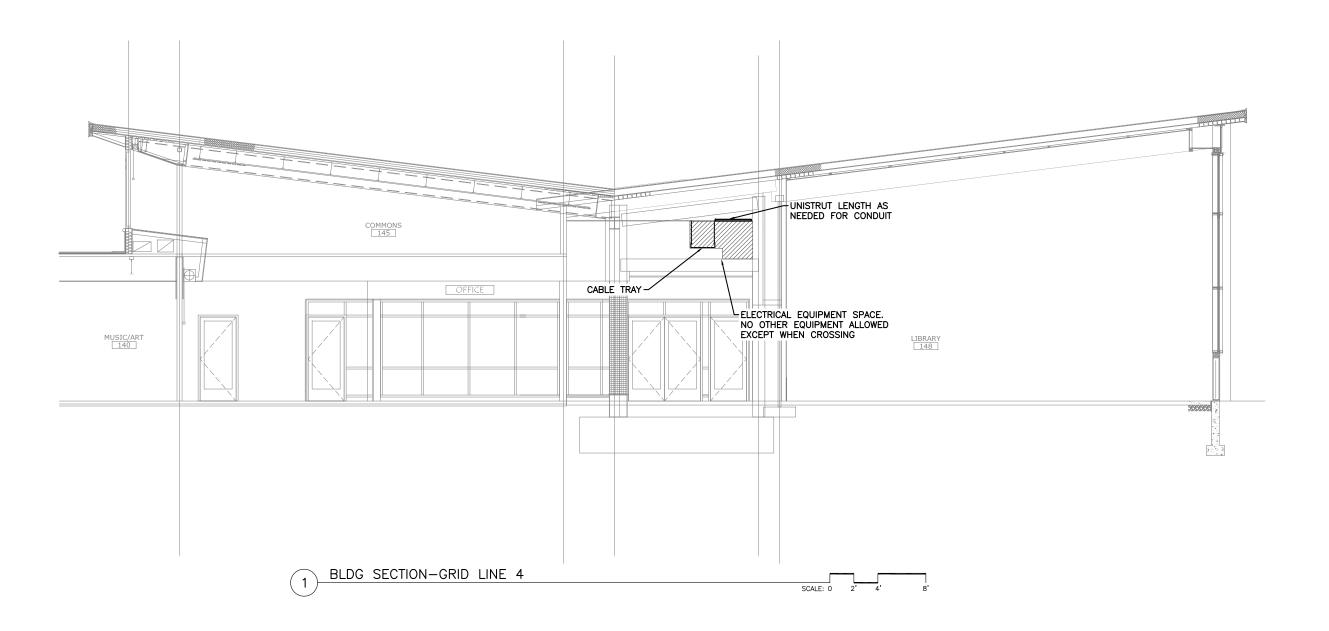révisión: checked by:

KED BY: MGM NN: DMP

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SCH00L GASTINEAU ELEMENTARY


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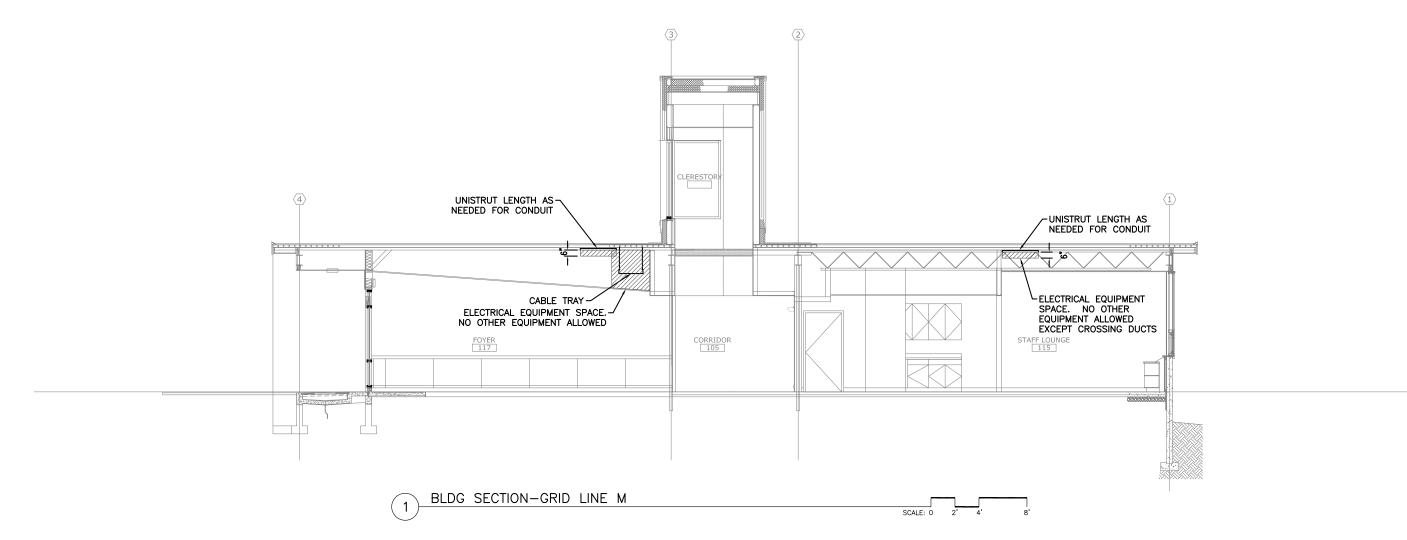
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HEET TITLE:
BUILDING
SECTIONS 4

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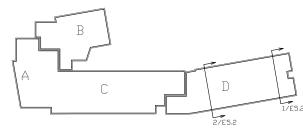
DATE: NOV. 15, 2010 REVISION:


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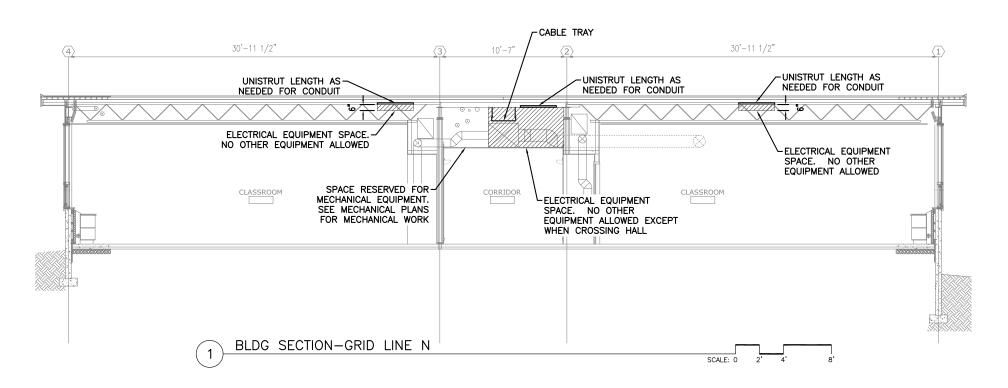
SCH00L


GASTINEAU ELEMENTARY BUILDING SECTIONS 5


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KEY PLAN

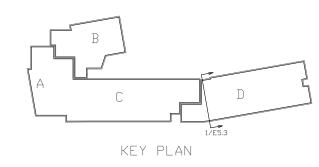

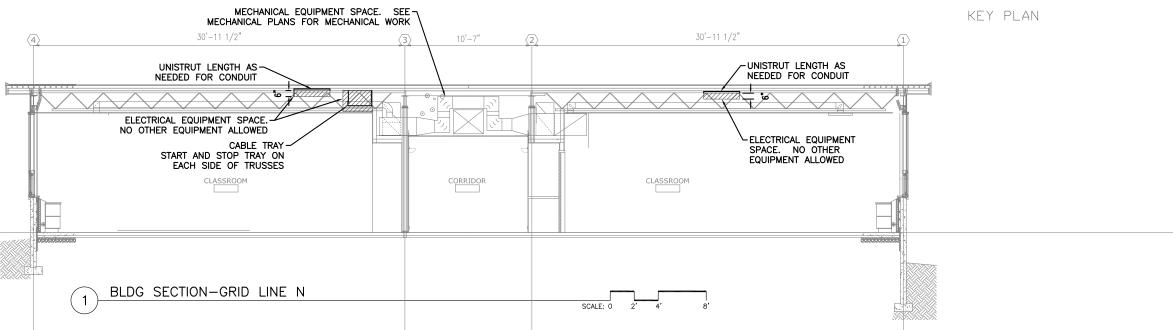

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RENOVATION

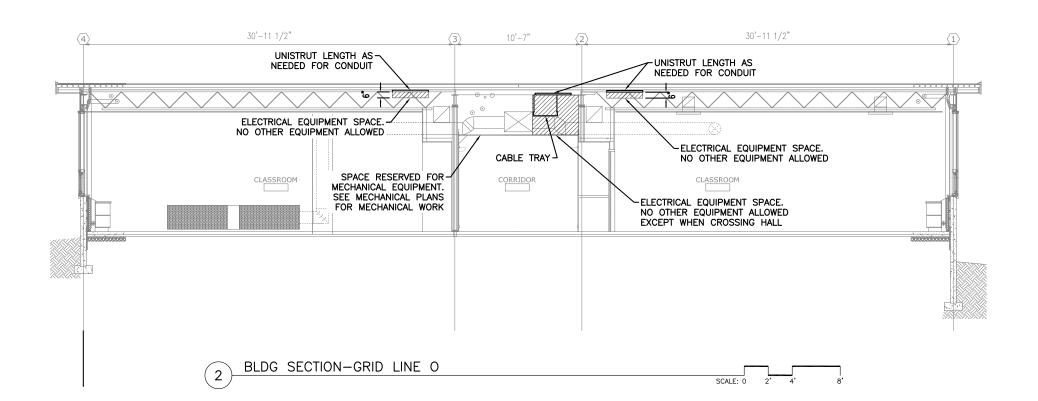GASTINEAU ELEMENTARY

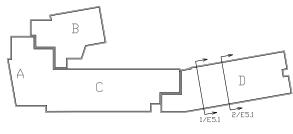BUILDING SECTIONS 6

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