

H STREET DOUGLAS STAIRS RECONSTRUCTION

CONTRACT NO. BE18-274

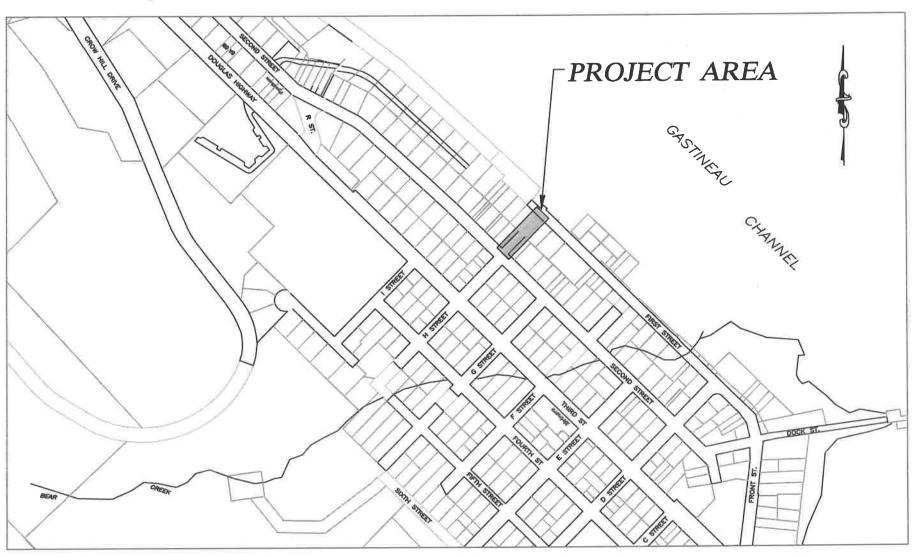



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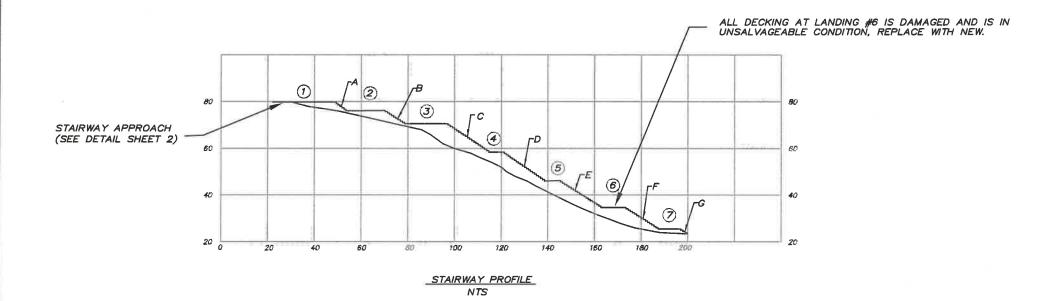
DESCRIPTION	SHEET NO.
COVER SHEET	1 OF 3
DETAILS	2 OF 3
PLAN AND PROFILE	3 OF 3

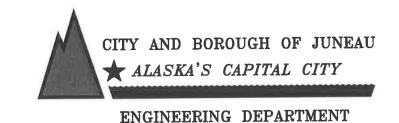

1 of z



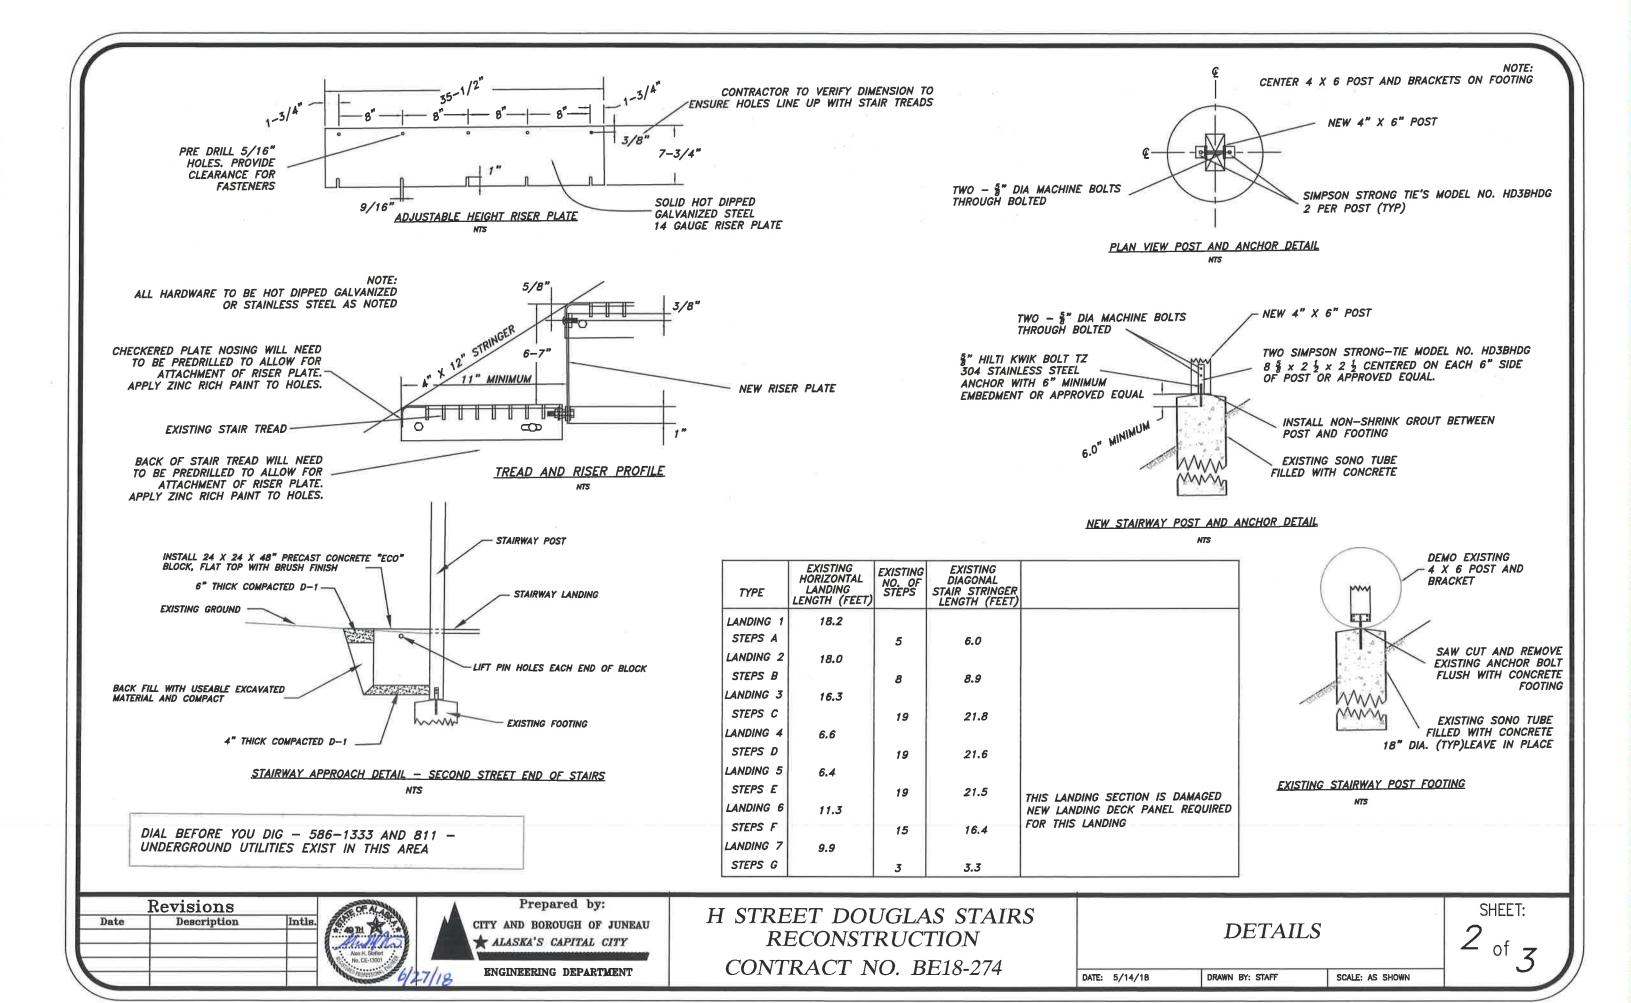

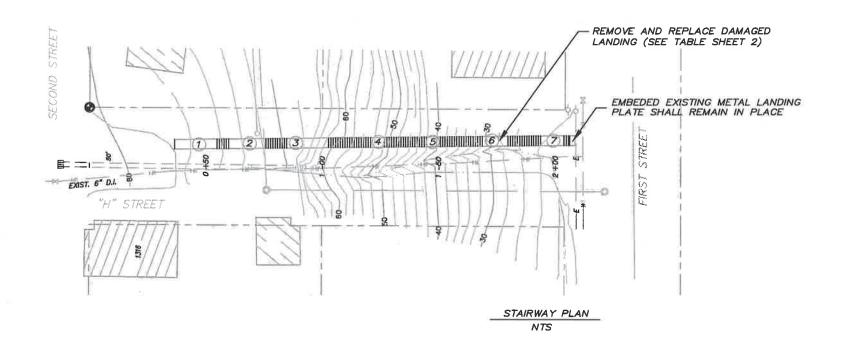

DIAL BEFORE YOU DIG - 586-1333 AND 811 -UNDERGROUND UTILITIES EXIST IN THIS AREA

Prepared by: Revisions Intls. Date Description CITY AND BOROUGH OF JUNEAU ALASKA'S CAPITAL CITY ENGINEERING DEPARTMENT

H STREET DOUGLAS STAIRS **RECONSTRUCTION** CONTRACT NO. BE18-274

SHEET: of

PLAN AND PROFILE

NO. 2 AND BETTER.

SCALE: AS SHOWN

STAIRWAY AND LANDING NOTES:

1. DEMOLISH AND DISPOSE OF ALL STAIRS, LANDINGS, POSTS, AND RAILS. SALVAGE USEABLE STAIR TREADS AND LANDING DECK PANELS. REBUILD WITH ALL NEW TIMBER AND HARDWARE

2. PRESERVE AND PROTECT ALL EXISTING FOOTINGS DURING THE DEMO OPERATIONS. THE EXISTING FOOTING REMAIN IN PLACE AND ARE TO BE REUSED FOR THE CONSTRUCTION OF THE NEW

3. EXISTING STAIRWAY WOOD SHALL BE REMOVED AND DISPOSED OF AT AN APPROVED DISPOSAL

4. CONTRACTOR SHALL TAKE AND RECORD MEASUREMENTS OF EXISTING STAIR STRUCTURE PRIOR TO DEMOLITION. THE NEW STAIRS SHALL BE CONSTRUCTED TO THE SAME DIMENSIONS AND CONFIGURATION OF ORIGINAL "UNDAMAGED"

5. FOLLOW CBJ STANDARD DETAILS 4TH EDITION DATED AUGUST 2011 AND CBJ STANDARD

7. THE NEWLY BUILT STAIRS WILL REQUIRE NEW RISER PLATES TO BE INSTALLED. EXISTING STAIR TREADS AND LANDINGS REQUIRE HOLES TO BE PREDRILLED FOR RISER PLATE ATTACHMENT. 8. ALL SALVAGED METAL TREADS AND LANDING

DECK SHALL BE REUSED WITH THE EXCEPTION OF DAMAGED TREADS AND LANDINGS AS DETERMINED BY THE ENGINEER. DAMAGED TREADS AND LANDINGS SHALL BE REMOVED AND DISPOSED OF AT AN APPROVED DISPOSAL SITE AND REPLACED WITH NEW TREAD OR LANDINGS.

9. NEW STAIRWAY TREADS AND LANDINGS SHALL

10. POST BASE HOLD DOWN BRACKETS SHALL BE HOT DIPPED GALVANIZED, SIMPSON STRONG—TIE NO. HD3BHDG OR APPROVED EQUAL.

GALVANIZED IN ACCORDANCE WITH ASTM-A-153 AND THE UNIFORM BUILDING CODE EXCEPT AS

12. ALL WOOD SHALL BE TREATED WITH ACA OR CCA IN ACCORDANCE WITH LP-22. RETENTION OF THE DRY SALT SHALL BE A MINIMUM OF 0.5 LBS. PER CUBIC FOOT. LUMBER SHALL BE HEM-FIR,

BE STEEL GRATING 1" X 3/16" BEARING BARS

AND 1/4" CROSS BARS, RYERSON 19W4 OR EQUAL. MINIMUM TREAD WIDTH SHALL BE 11". NEW

GRATING SHALL BE HOT DIPPED GALVANIZED

AFTER FABRICATION IN ACCORDANCE WITH

11. ALL HARDWARE SHALL BE HOT DIPPED

6. FOLLOW CBJ STANDARD DETAIL 122 -STANDARD STAIRWAY, AND THE CONTRACT

SPECIFICATIONS DATED DECEMBER 2003 AND ALL

STRUCTURE.

ASTM-A-153.

AND SALVAGED AND USEABLE TREADS AND LANDING DECK PANELS. INSTALL NEW RISER

DATE: 5/14/18

DRAWN BY: STAFF