

#### ADDENDUM TO THE CONTRACT

#### for the

## **CBJ-MIS & Server Room A/C Installation**

## Contract No. BE17-144

ADDENDUM NO.: TWO

**CURRENT DEADLINE FOR BIDS:** 

**February 1, 2017** 

PREVIOUS ADDENDA: ONE

**ISSUED BY:** 

City and Borough of Juneau ENGINEERING DEPARTMENT 155 South Seward Street

Juneau, Alaska 99801

#### DATE ADDENDUM ISSUED:

**January 23, 2017** 

The following items of the contract are modified as herein indicated. All other items remain the same. This is a faxed addendum. A confirming copy will not be mailed to you. This addendum has been issued and is posted online. Please refer to the CBJ Engineering Contracts Division webpage at: <a href="http://www.juneau.org/engineering">http://www.juneau.org/engineering</a> ftp/contracts/Contracts.php

## **Contractor Questions and Answers: (Electrical)**

1. On site it was brought to our attention that the proper clearance in front of the new F2 panel in the Penthouse will not be to code. The AHU is approximately 34 inches from the wall. With the additional depth of the panel we will have 30" of clearance in front of the panel.

Response: Panel F2 has been eliminated. See the revised electrical drawings issued 1-18-17.

2. On drawing E200, Penthouse plan-are the disconnects for CCU 2 and CCU3 fused or are non-fused disconnects permitted?

Response: Non-fused disconnects are permitted.

3. For Panel F2 will a load center panel be permitted or is a panelboard required?

Response: Panel F2 has been eliminated. See the revised electrical drawings issued 1-18-17.

## **DRAWINGS**:

Item No. 1 M001 SYMBOLS & SCHEDULES, *Add* the following to Air Conditioner Schedule, Description/Features of CCU-2 & 3:"WIND BAFFLE ACCESSORY."


Item No. 2 M001 SYMBOLS & SCHEDULES, *Add* the following to Air Conditioner Schedule, Description/Features of AC-3: "CONDENSATE PUMP ACCESSORY."

- Item No. 3 M200 MECHANICAL SITE PLAN, Add Construction Note #3 to all refrigerant piping stating: "REFRIGERANT PIPE SIZING ACCORDING TO MANUFACTURER'S RECOMMENDATIONS IS ACCEPTABLE"
- Item No. 4 M200 MECHANICAL SITE PLAN, Rotate AC-3 counter-clockwise 45° to align with ceiling grid. Add note on plan directed at MIS Server Room: "COORDINATE POTENTIAL SMOKE DETECTOR CONFLICTS WITH ELECTRICAL."
- Item No. 5 M200 MECHANICAL SITE PLAN, Add note to Sheet: "LOCATE AC-3 THERMOSTAT **NEXT TO EXISTING AC-1 THERMOSTAT"**
- Item No. 6 M200 MECHANICAL SITE PLAN, Enlarge graphics of AC-2A and B Units to 3'x3' (Currently displayed as 2'x2')
- Item No. 7 M200 MECHANICAL SITE PLAN, Add to Construction Note #2 the following: "MODIFY CEILING GRID TO CLEANLY INTEGRATE AC UNITS, LOCATE AC UNITS AS TO NOT INTERFERE WITH EXISTING LIGHTING"
- Item No. 8 M200 MECHANICAL SITE PLAN, Change plan scale lengths from 0-4'-8'-16' to the following: 0-2'-4'-8'
- Item No. 9 M200 MECHANICAL SITE PLAN, Add Construction Note #4 to each wall penetration of a pipe assembly. Construction Note #4 to state: "SEAL PIPE PENETRATION."
- Item No. 10 M200 MECHANICAL SITE PLAN, Add sheet note: "1. TEMPORARY PLASTIC PARTITION TO BE ERECTED AROUND CONSTRUCTION AREA IN SERVER ROOM FOR DUST PROTECTION. REMOVE IMMEDIATELY AFTER NO LONGER NEEDED. COORDINATE WITH MIS STAFF."
- Item No. 11 M201 PENTHOUSE MECHANICAL PLAN, Add Sheet note "1. ALL EXISTING CABLING IS NOT SHOWN, COORDINATE ONSITE."
- M201 PENTHOUSE MECHANICAL PLAN. Add Sheet note "2.COORDINATE PROJECT Item No. 12 WORK WITH NON RELATED CABLING AND TRANSMITTERS. COORDINATE WITH CBJ PERSONNEL IF RELOCATION OF EXISTING CABLING IS REQUIRED."
- Item No. 13 E100 MIS DEMOLITION PLAN, LEGEND, NOTES, Remove Sheet E100 DEMOLITION PLAN, LEGEND, NOTES and Replace with attached E100-R1 DEMOLITION PLAN, LEGEND, NOTES, REVISION DATE 1/18/17.
- E200 LEGEND, NOTES, SINGLE LINE, SITE PLAN, Remove Sheet E200 LEGEND, Item No. 14 NOTES, SINGLE LINE, SITE PLAN and Replace with attached E200-R1 LEGEND, NOTES, SINGLE LINE, SITE PLAN, REVISION DATE 1/18/17.

By: Greg Smith,

Contract Administrator

Total number of pages contained within this Addendum: 4

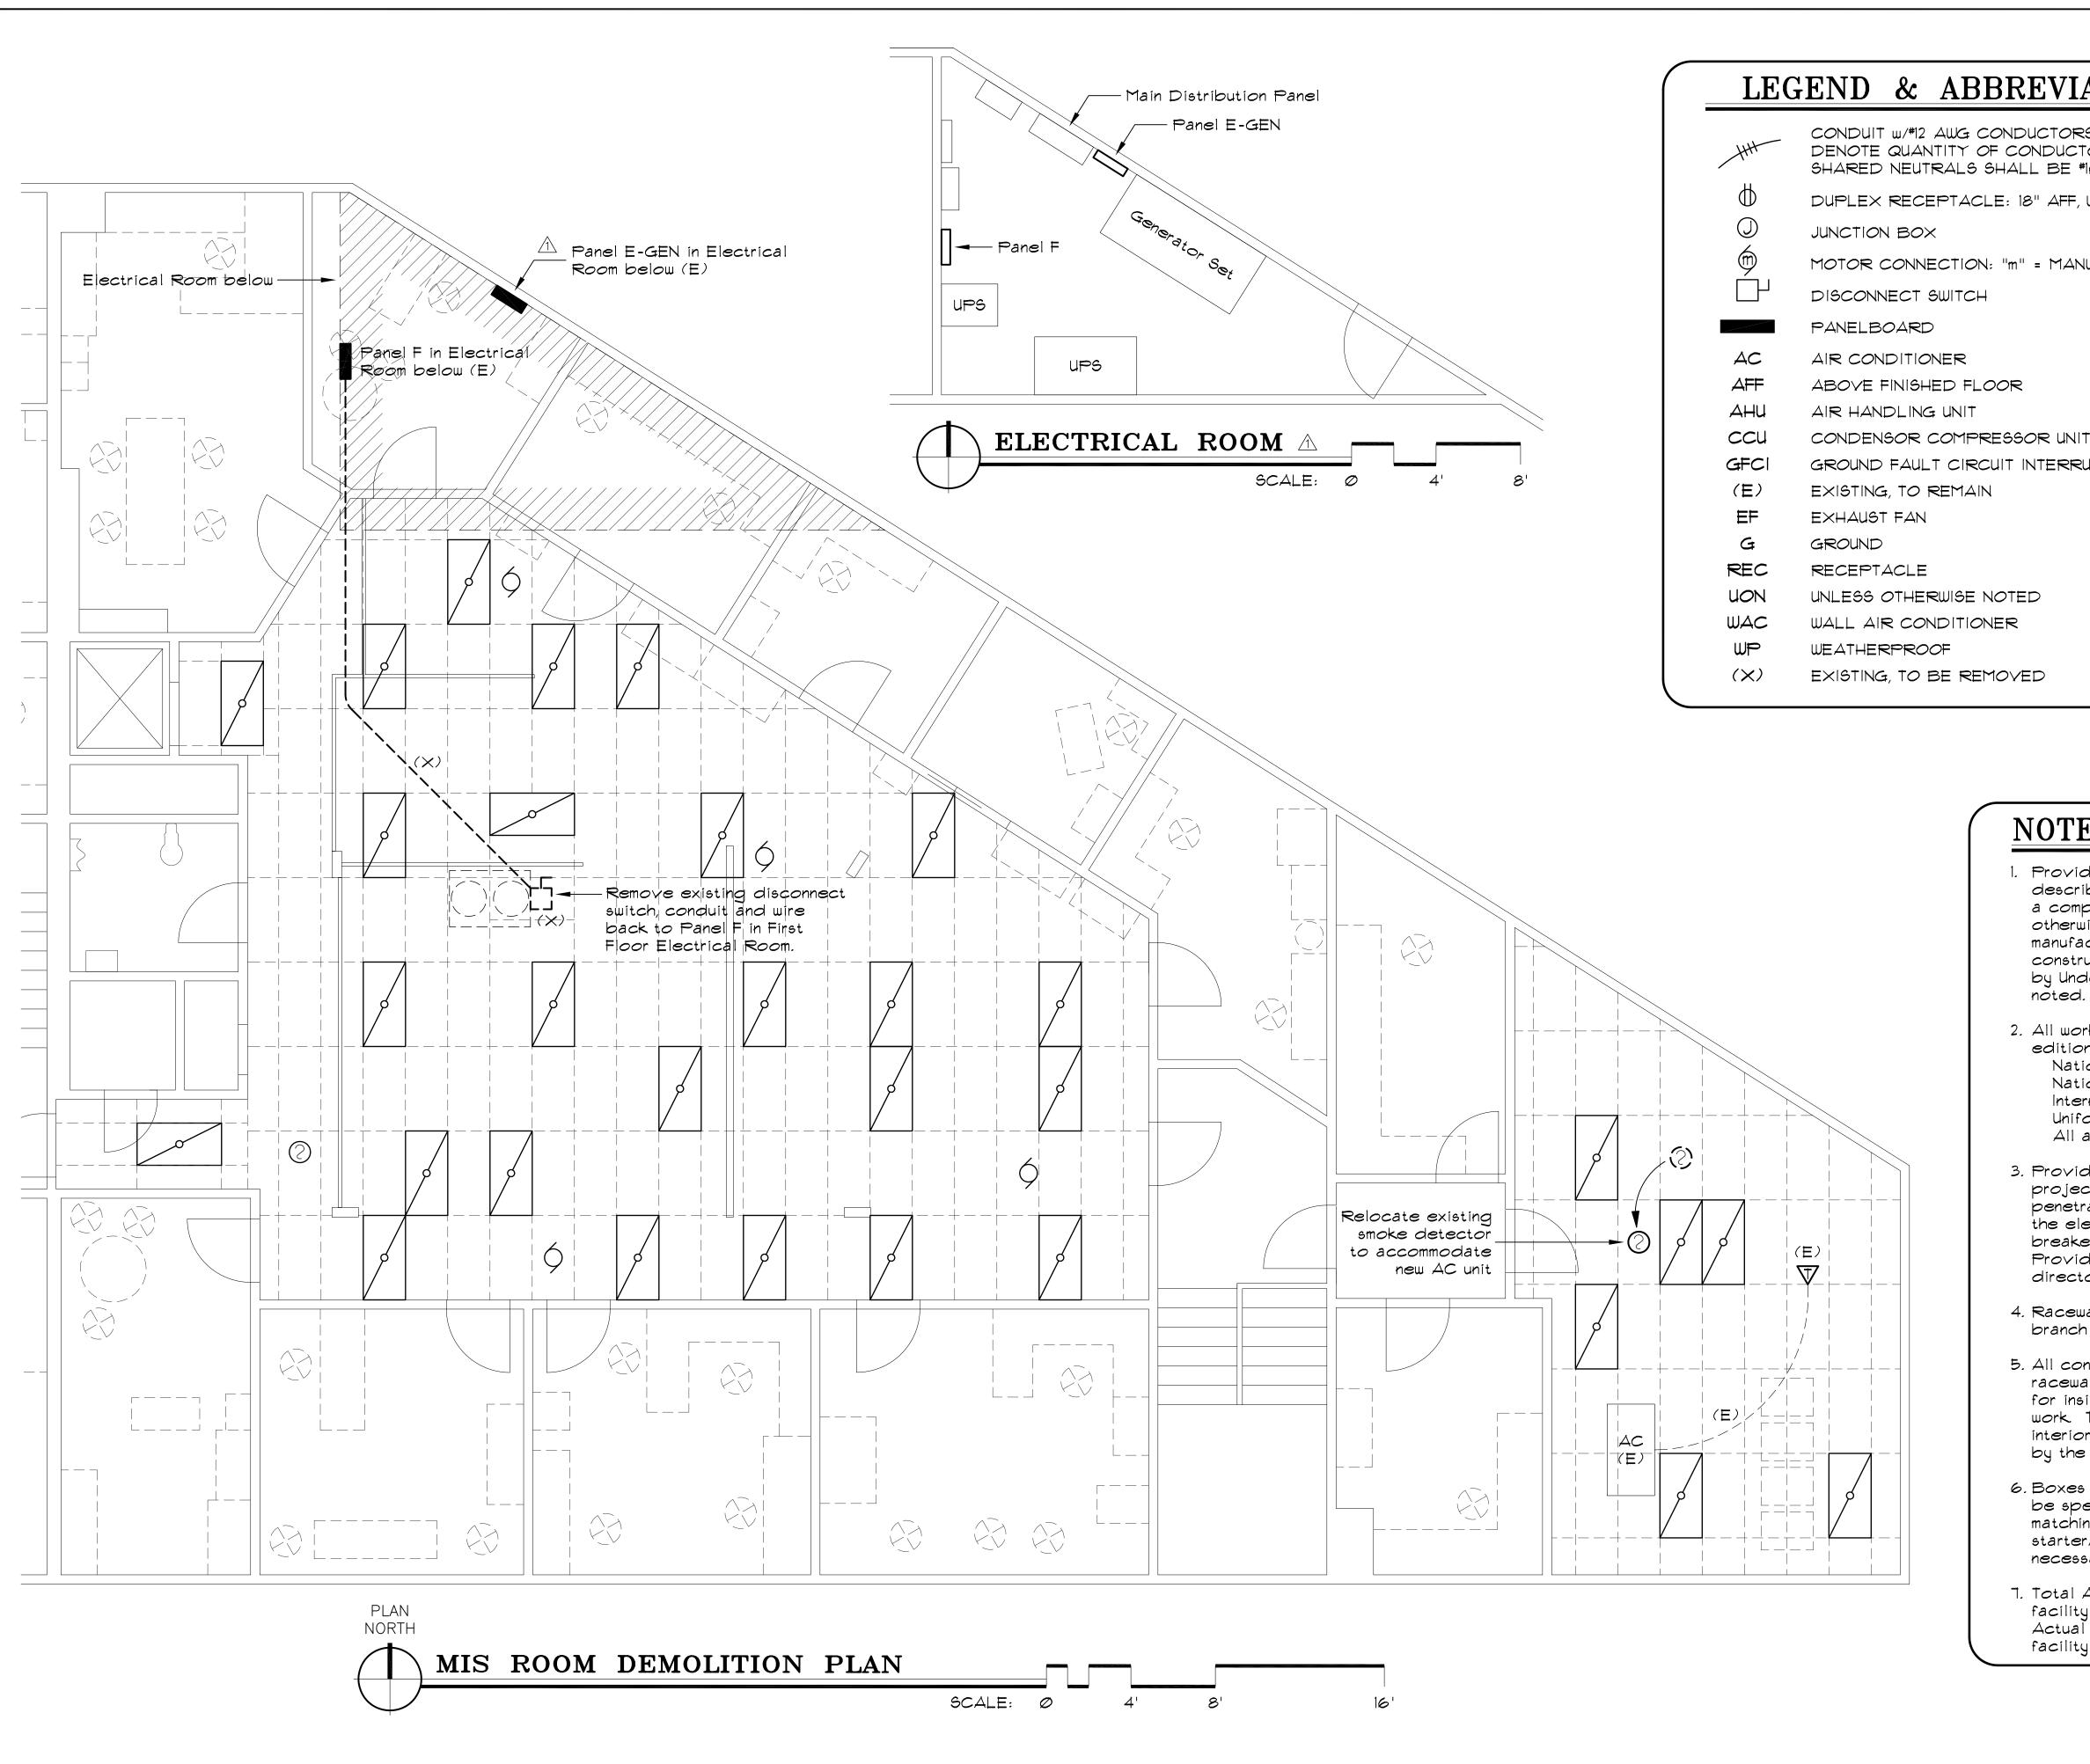

## LEGEND & ABBREVIATIONS

CONDUIT w/#12 AWG CONDUCTORS, UON. SLASHES DENOTE QUANTITY OF CONDUCTORS IF NOT TWO. SHARED NEUTRALS SHALL BE #10 AWG.

DUPLEX RECEPTACLE: 18" AFF, UON

MOTOR CONNECTION: "m" = MANUAL STARTER

GROUND FAULT CIRCUIT INTERRUPTER

# NOTES & SPECIFICATIONS

- 1. Provide all work as shown on the drawings and described in the specifications and notes for a complete and functional installation. Unless otherwise noted, all material shall be of new manufacture and of the manufacturer's standard construction. All material shall be approved by Underwriters Laboratories (UL) and so
- 2. All work shall comply with the latest approved editions of the:

National Electrical Code (NEC) National Fire Protection Association Codes International Building Code (IBC) Uniform Federal Accessibility Standards All applicable Federal, State & Local regs

- 3. Provide two sets of as-built drawings at project completion. Minimize and seal penetrations of the vapor barrier caused by the electrical installation. Label all new circuit breakers, junction boxes, controls, etc. Provide a new accurate, typed circuit directory for each revised panelboard.
- 4. Raceway systems shall be EMT for feeder and branch circuits and rigid steel for exterior.
- 5. All conductors shall be copper. Conductors in raceways shall have type THHN/THWN insulation for inside work and type XHHW-2 for exterior work. Type MC cable is acceptable for interior work where concealed and approved by the local authority, the Owner and the NEC.
- 6. Boxes shall be steel. All wiring devices shall be specification grade, screw connected, with matching nylon plates. Provide a manual starter/disconnect for motor loads as necessary.
- 7. Total Additional Connected Load for the facility is 3.0 kVA (8.3 Amperes). Actual Additional Demand Load for the facility is 3.0 kVA (8.3 Amperes).



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Room

and Server

MIS

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SHEET TITLE: MIS DEMOLITION PLAN, LEGEND,


REVISION 1 1/18/17 SCALE: AS SHOWN DATE: 09/28/2016 DRAWN: PG/SB/KB DESIGNED:

SHEET NO.

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**NOTES** 

E100-R1



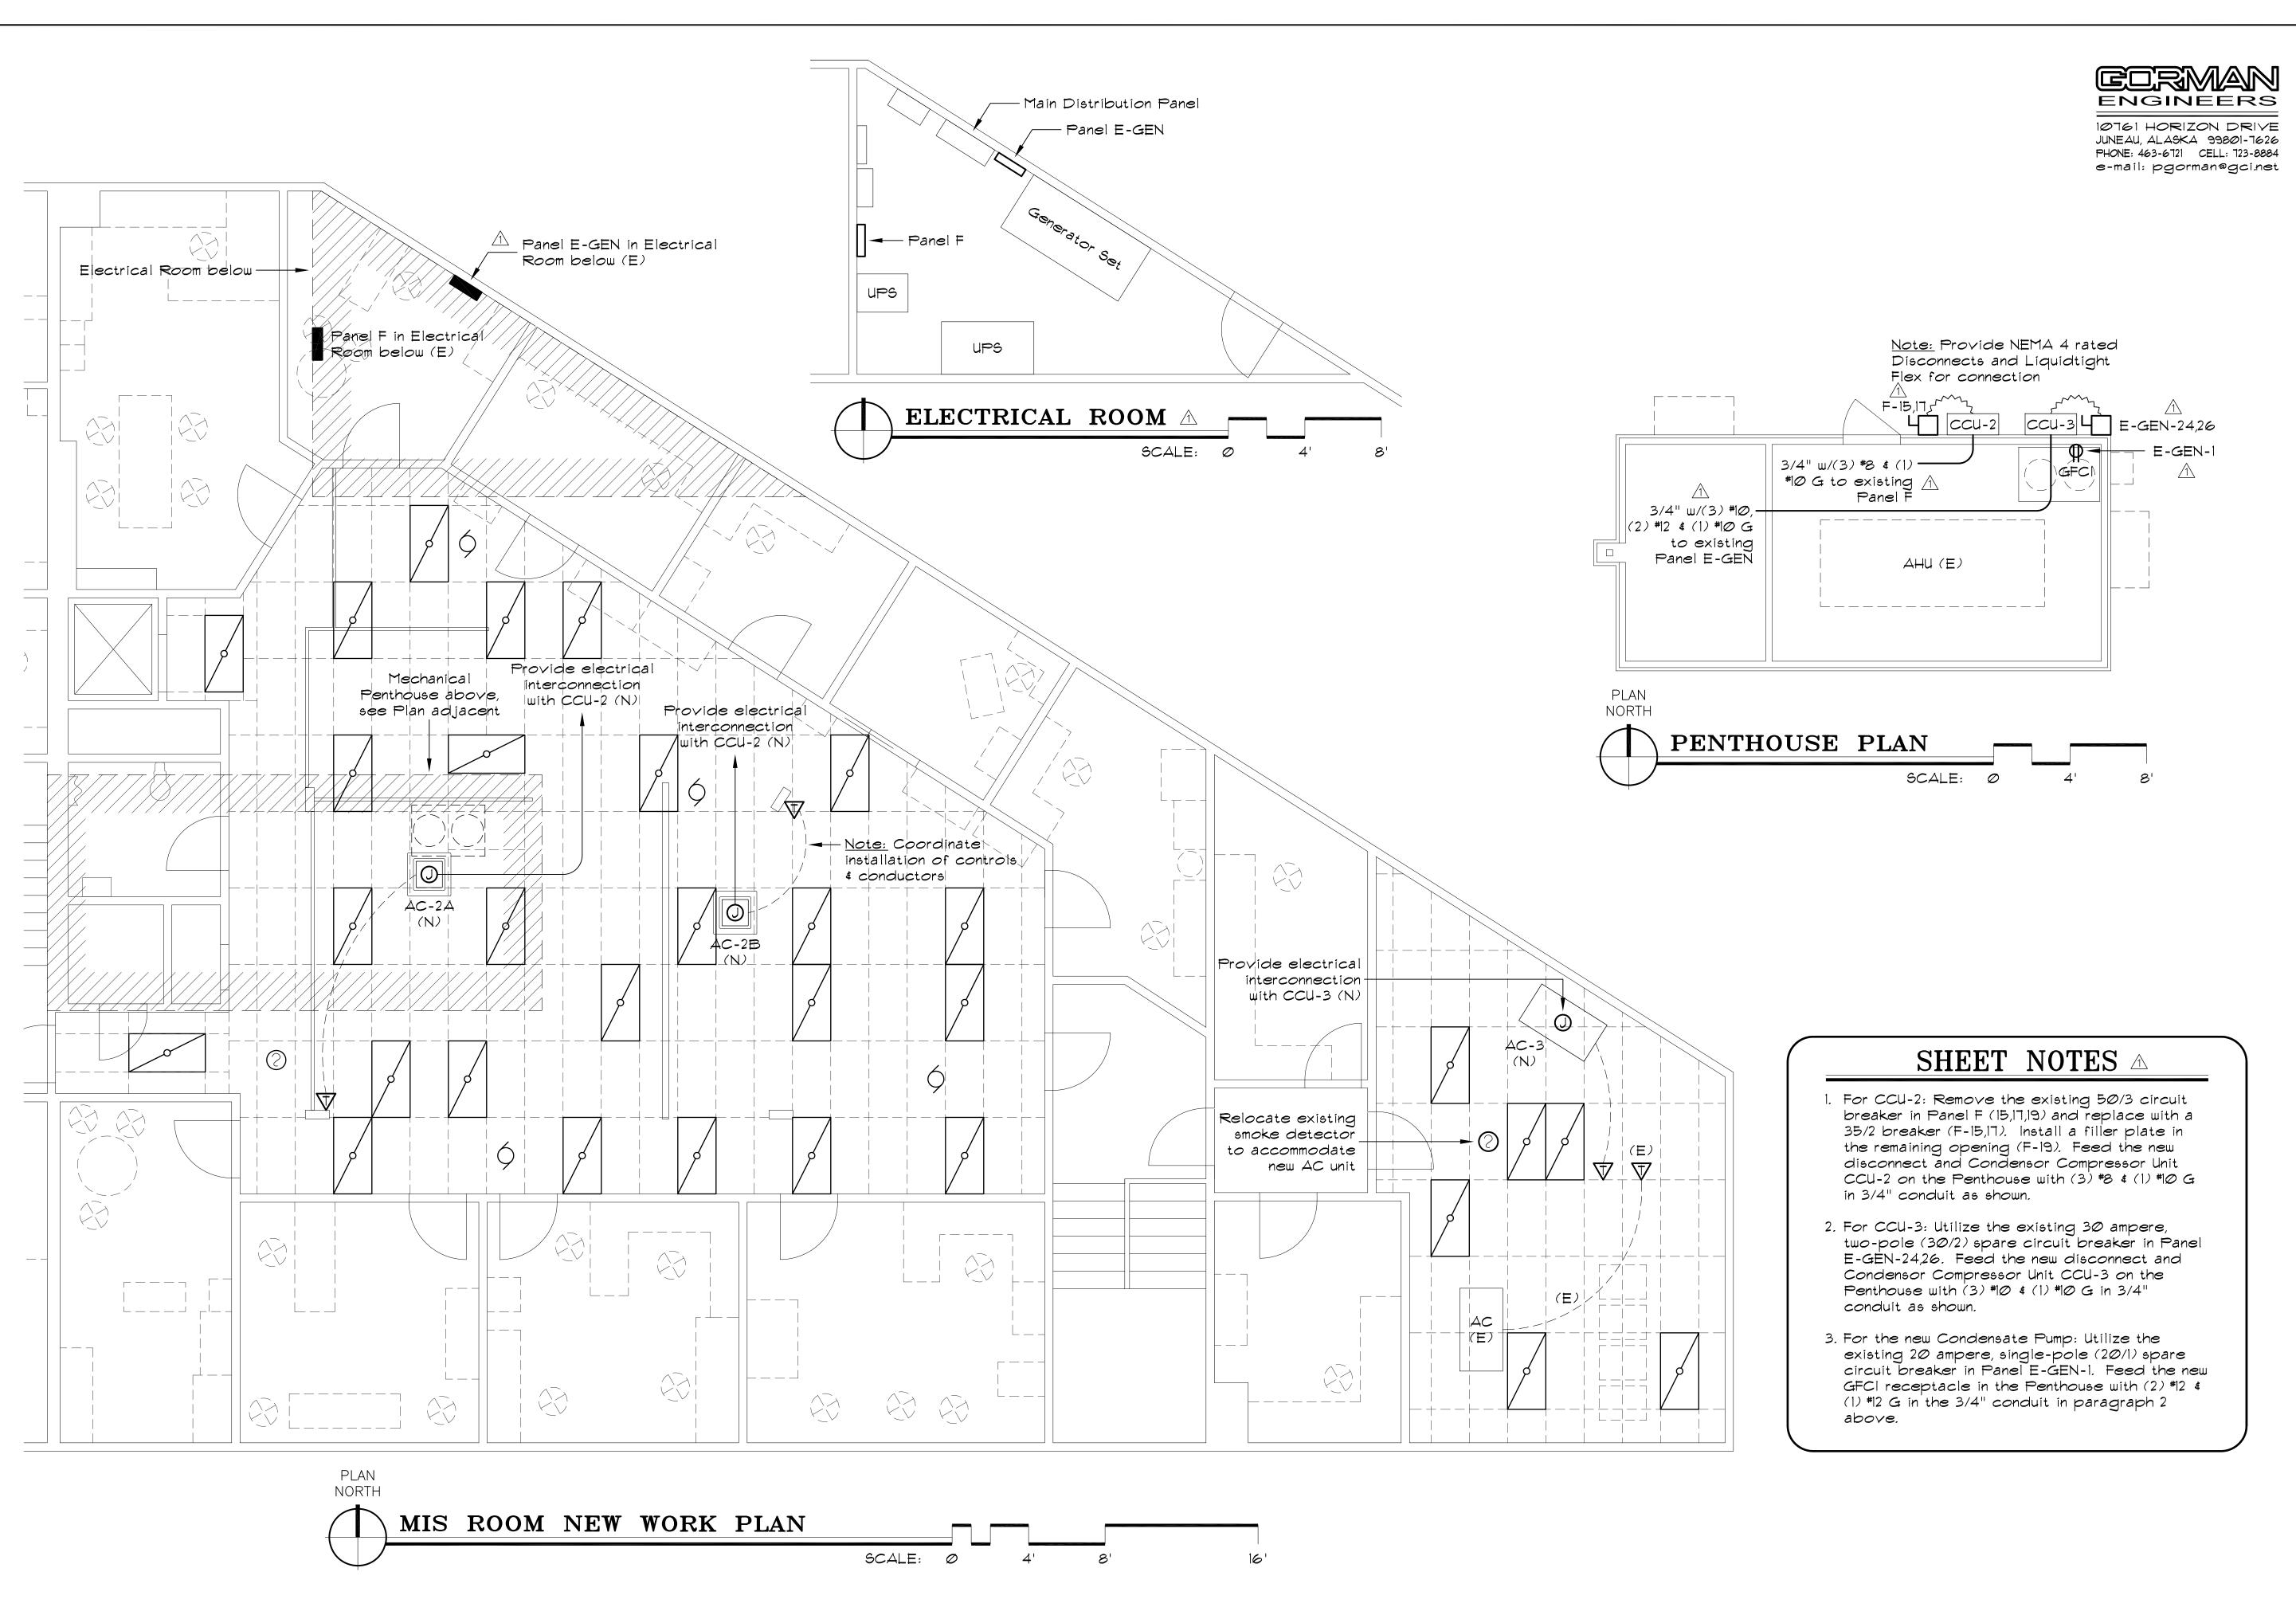



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SHEET TITLE: LEGEND, NOTES, SINGLE LINE,

SITE PLAN A REVISION 1 1/18/17

SCALE: DATE: AS SHOWN 09/28/2016 DRAWN: PG/SB/KB DESIGNED:

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CBJ

E200-R1