

## SAVIKKO BALL FIELDS RESURFACING PROJECT CONTRACT NO. E14-203


## **INDEX**

DESCRIPTION	SHEET NO.
COVER SHEET	1 of 10
SURVEY CONTROL AND LAYOUT	2 of 10
DETAILS	3 of 10
EXISTING GRADES FIELD 1	4 of 10
SITE AND GRADING PLAN FIELD 1	5 of 10
CROSS SECTIONS FIELD 1	6 of 10
EXISTING GRADES FIELDS 3 AND 4	7 of 10
SITE AND GRADING PLAN FIELDS 3 AND 4	8 of 10
CROSS SECTIONS FIELDS 3 AND 4	9 of 10
CROSS SECTIONS FIELDS 3 AND 4	10 of 10

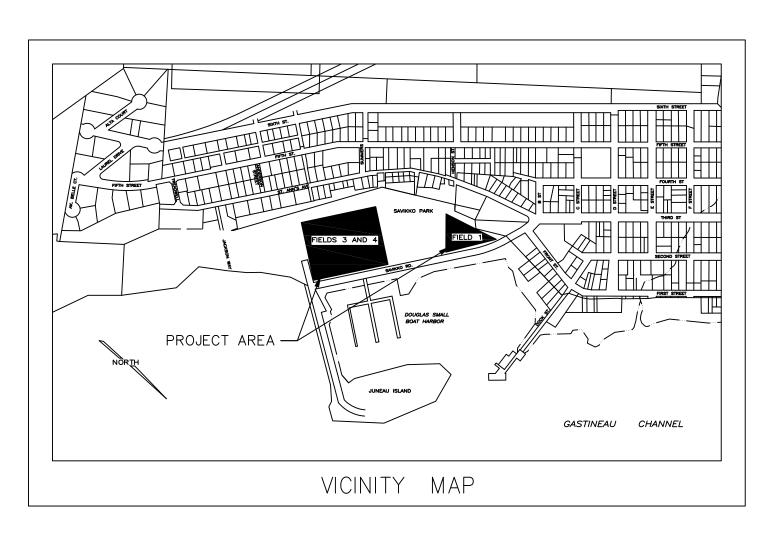

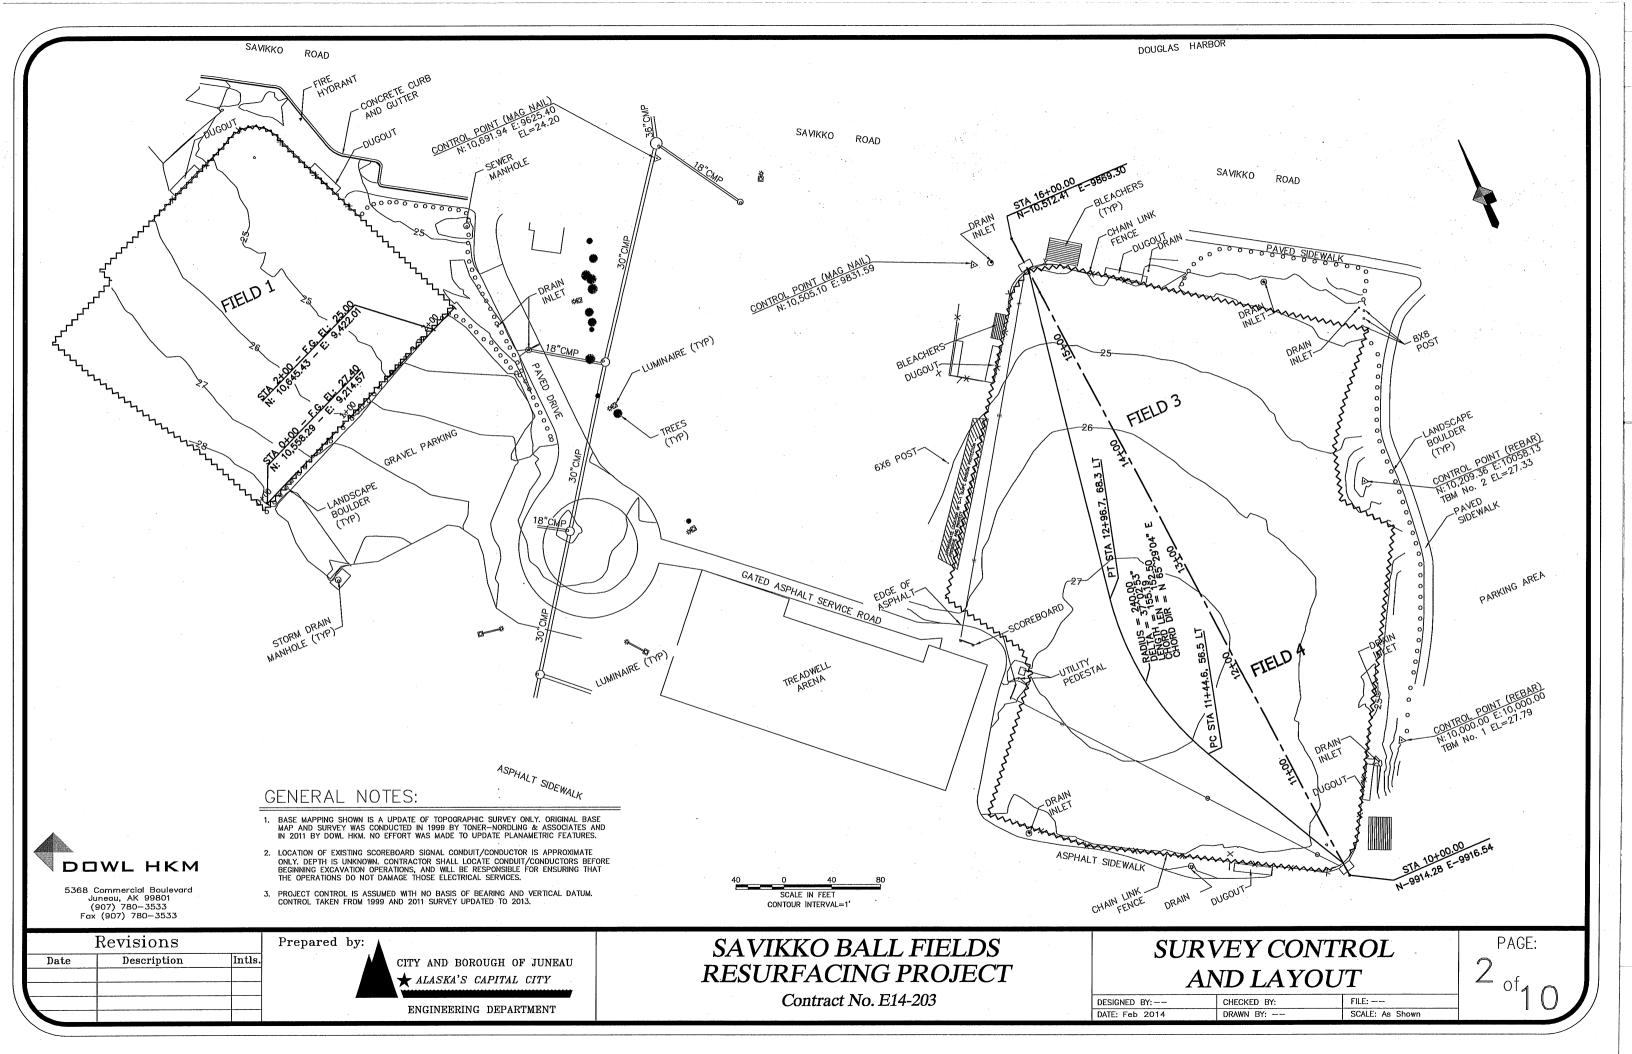



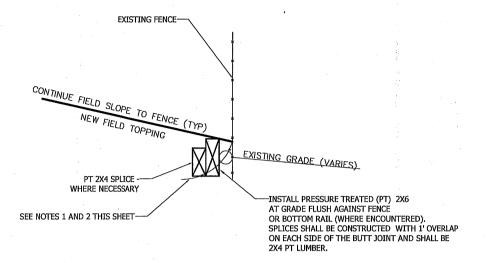

FIELD SURFACING/ FENCE DETAIL

## NOTES:


- 1. CONTRACTOR IS ENCOURAGED TO PERFORM EXCAVATION AND GRADING WORK ADJACENT TO FENCE LINES BY HAND TO PREVENT FENCE DAMAGE. ANY FENCE DAMAGE CAUSED BY CONTRACTOR SHALL BE PROFESSIONALLY REPAIRED TO FULL HEIGHT BY REMOVING DAMAGED FABRIC TO FULL
- HEIGHT AND INSTALLING NEW FULL HEIGHT FENCE FABRIC.

  2. THE BOTTOM OF THE EXISTING FENCE MAY BE CURLED TOWARDS THE EXCAVATION IN SOME AREAS. CONTRACTOR SHALL CAREFULLY LOCATE FENCE TO ENSURE DAMAGE IS NOT DONE TO FENCE. ANY DAMAGE TO
- FENCE TO ENSURE DAMAGE IS NOT DONE TO FENCE. ANY DAMAGE TO FENCE WILL BE REPAIRED PER NOTE 1. CONTRACTOR SHALL USE 2X6 TO PUSH FENCE BACK TOWARD POSTS AND FENCE LINE.

  3. CONTRACTOR SHALL EXCAVATE, GRADE AND COMPACT EXISTING FIELD SURFACE TO FINAL SUB GRADE ELEVATIONS PRIOR TO PLACING FIELD TOPPING MATERIAL
- TOPPING MATERIAL.


  4. HOME PLATE, BATTER'S BOX, PITCHERS RUBBER AND INFIELD BASES AND ANCHORS TO BE REMOVED BY OTHERS.

  5. LOCATIONS OF EXISTING SCOREBOARD CONDUIT/CONDUCTOR ARE APPROXIMATE ONLY AND DEPTH UNKNOWN.

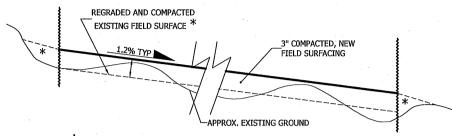

CUTS AND FILLS ARE EXPECTED TO BALANCE WITH LESS THAN 30 CY (COMPACTED, IN PLACE) OF IMPORTED 3" MINUS SELECT BORROW REQUIRED. EXCAVATION FROM SAVIKKO FIELD #3 MAY BE USED IF IMPORTED MATERIAL IS NECESSARY TO ACHIEVE SUBGRADE OR TAPERS TO EXISTING GROUND OUTSIDE OF THE FIELD PERIMETER.

SAVIKKO FIELD #1 TYPICAL SECTION

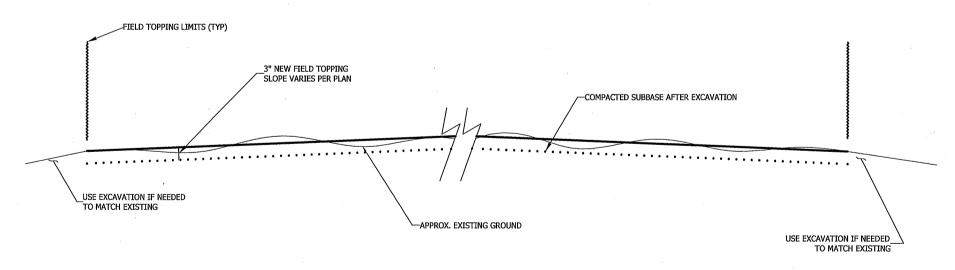

SAVIKKO FIELD NO 3 & 4 TYPICAL SECTION

Revisions Description Date CITY AND BOROUGH OF JUNEAU 🛨 ALASKA'S CAPITAL CITY ENGINEERING DEPARTMENT


SAVIKKO BALL FIELDS RESURFACING PROJECT


Contract No. E14-203


**DETAILS** 


PAGE:


DESIGNED BY: --CHECKED BY: FILE: ---DATE: FEB 2014 SCALE: As Shown

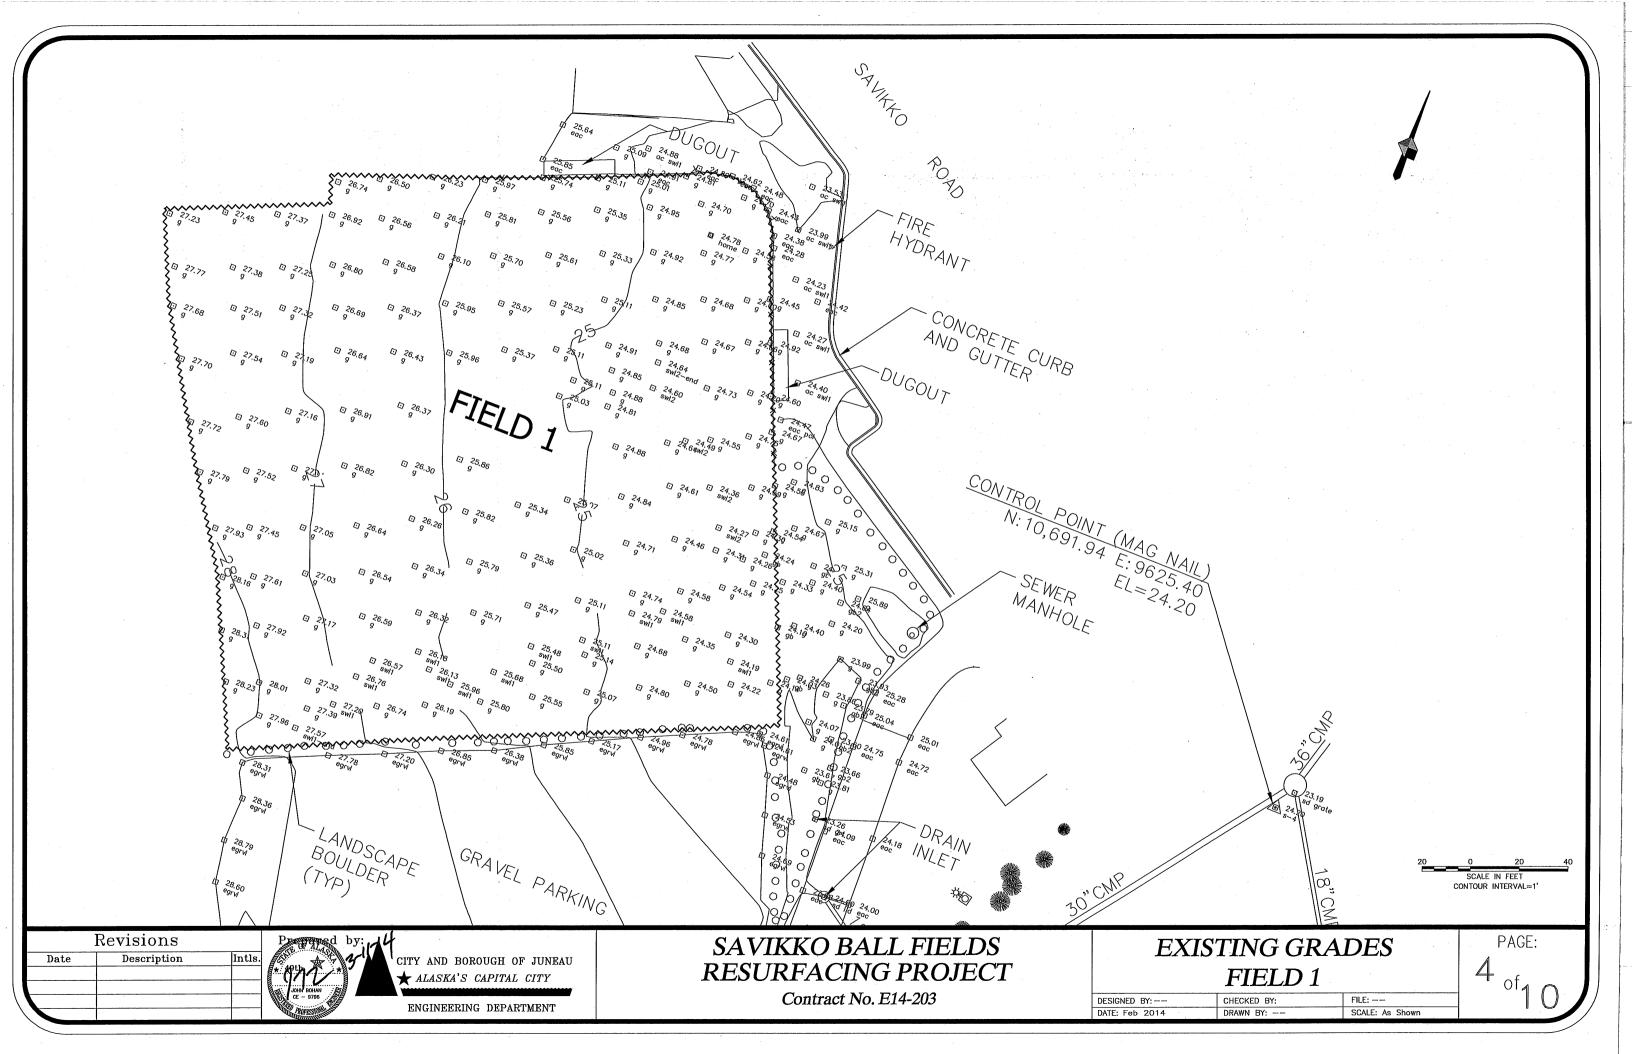


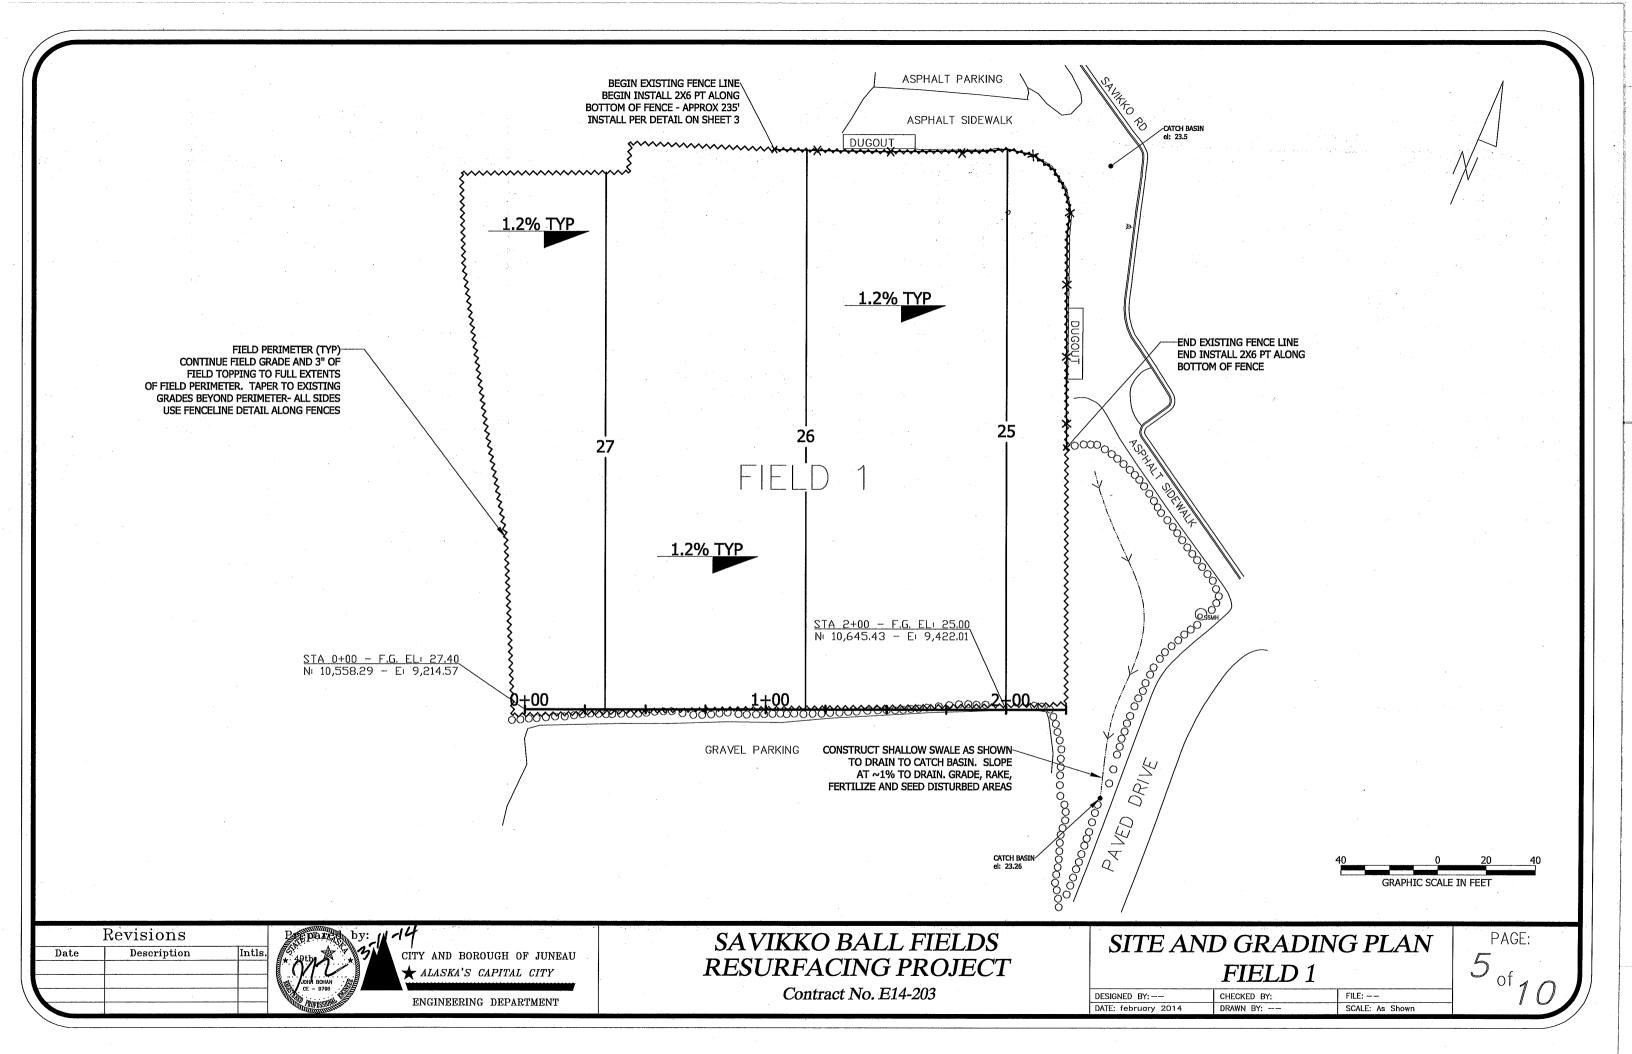


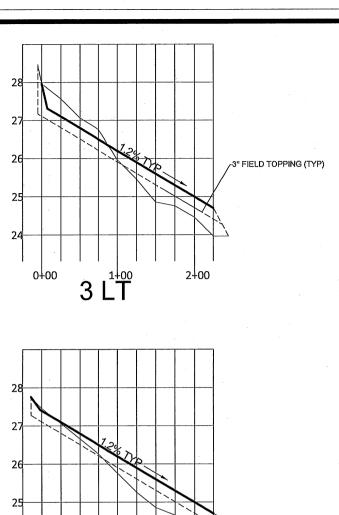


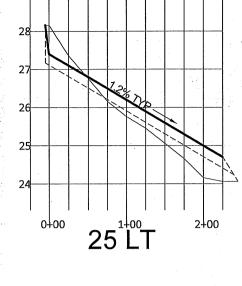

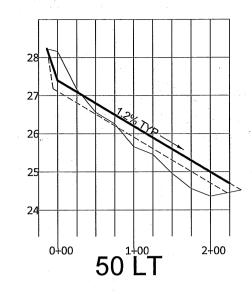


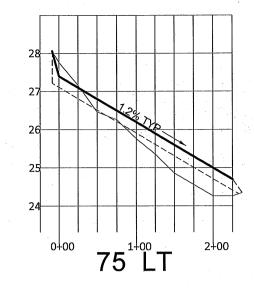


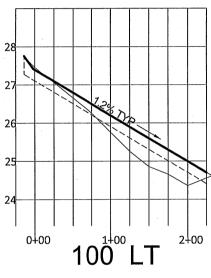


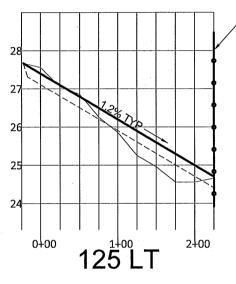




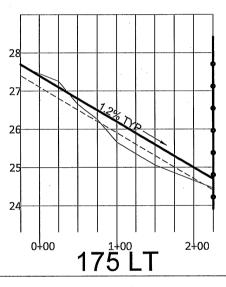

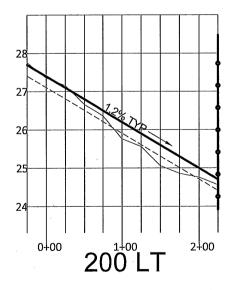

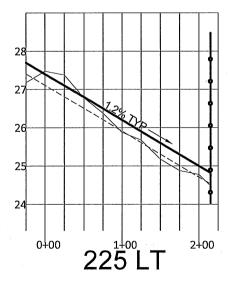

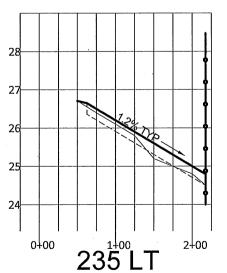

**EXISTING FIELD** SURFACE

REGRADED EXT'G FIELD SURFACE

TOP OF NEW FIELD SURFACING

VERTICAL SCALE ENHANCED 50 X HORIZONTAL SCALE

**LEGEND** 

Revisions Description Intls. Date CITY AND BOROUGH OF JUNEAU \* ALASKA'S CAPITAL CITY ENGINEERING DEPARTMENT


## SAVIKKO BALL FIELDS RESURFACING PROJECT


Contract No. E14-203


(	CROSS SECTIONS
	FIELD 1

SIGNED BY:	CHECKED BY:	FILE:
TE: february 2014	DRAWN BY:	SCALE: As Shown

PAGE: 6 of 1

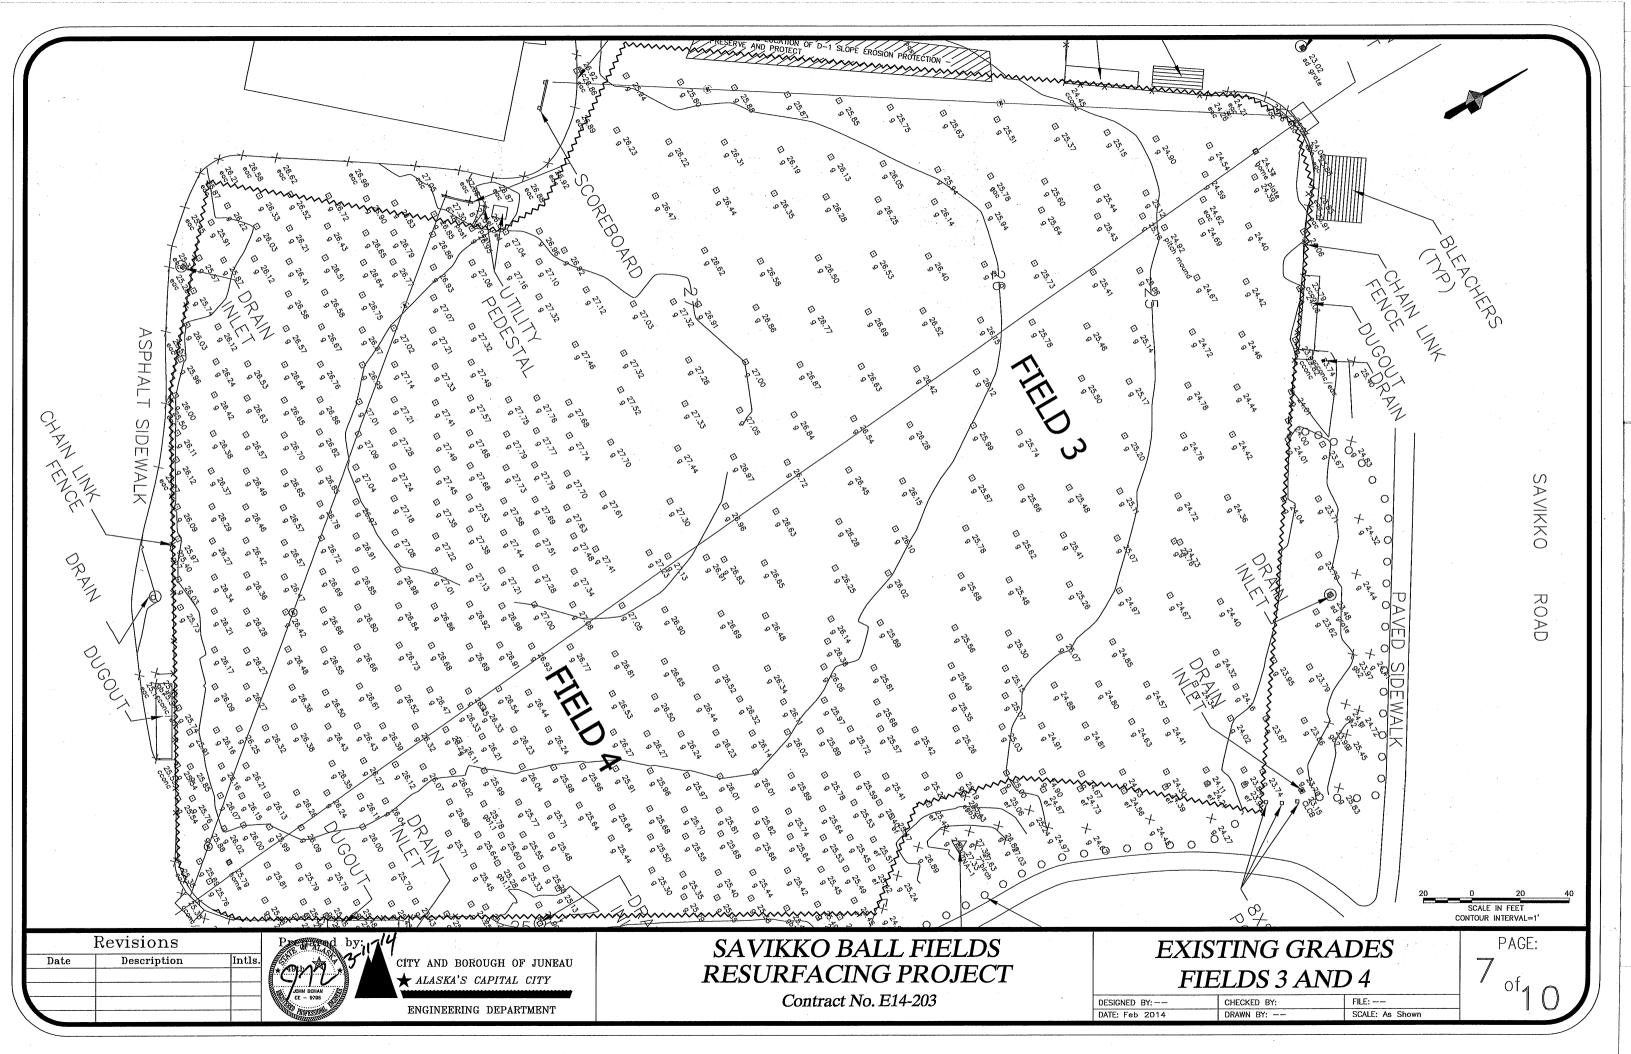

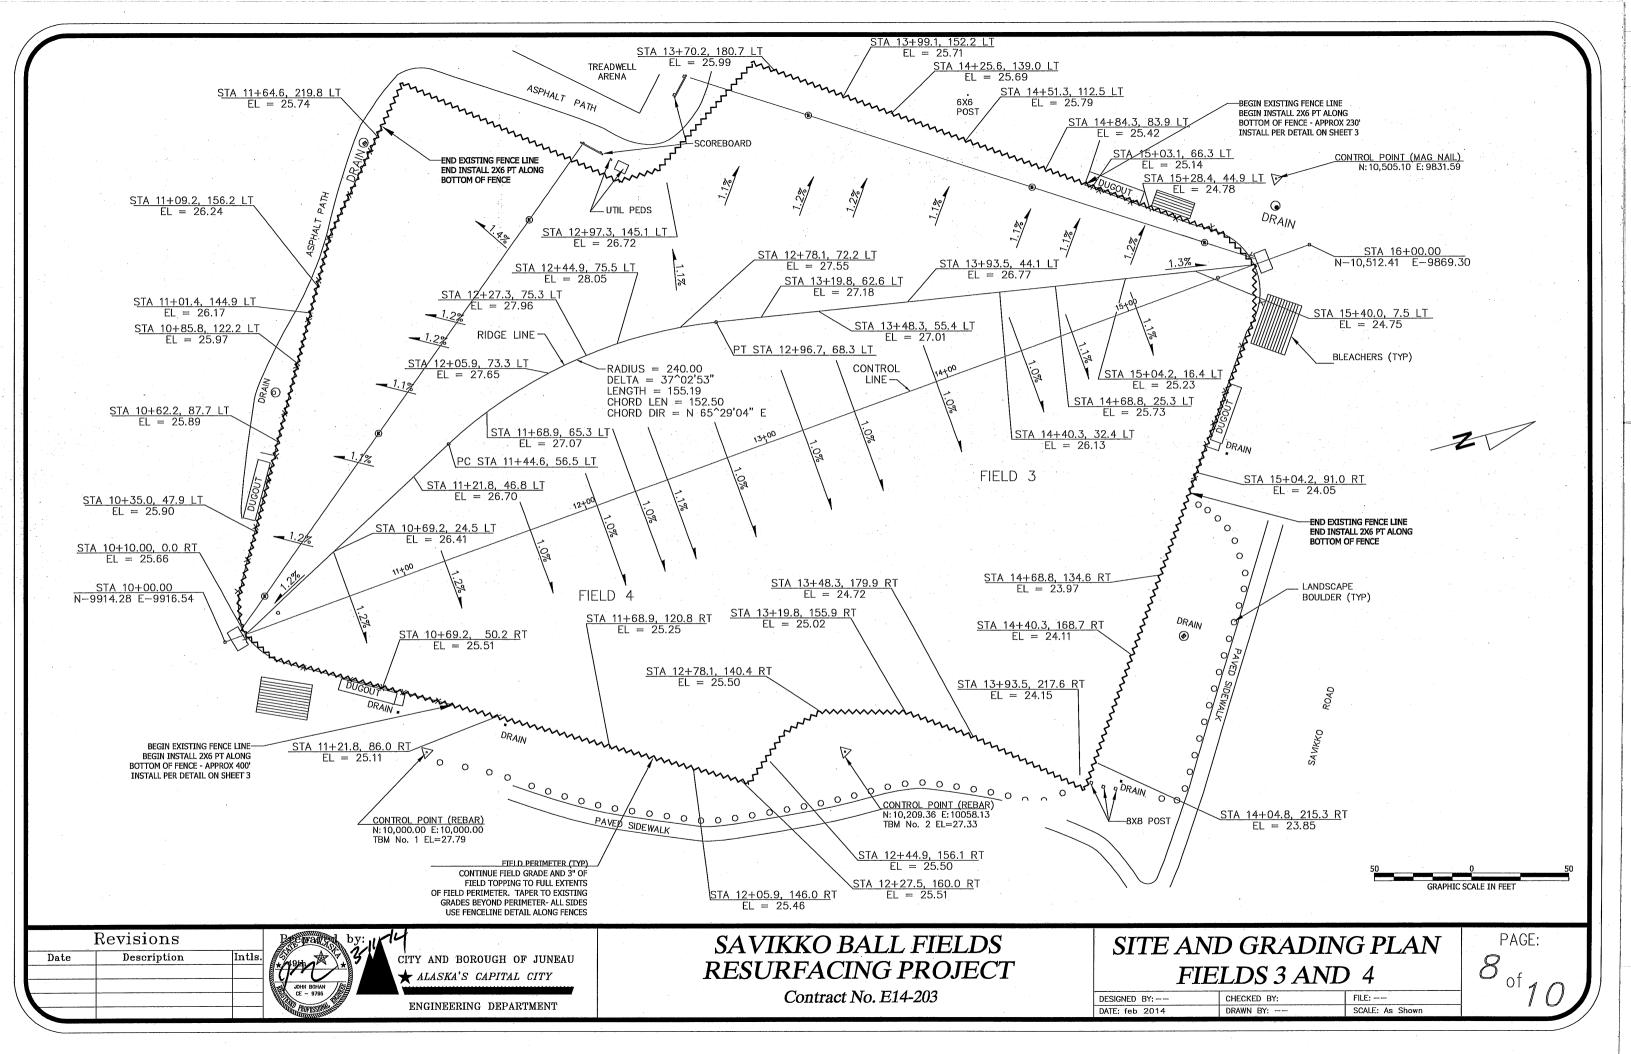

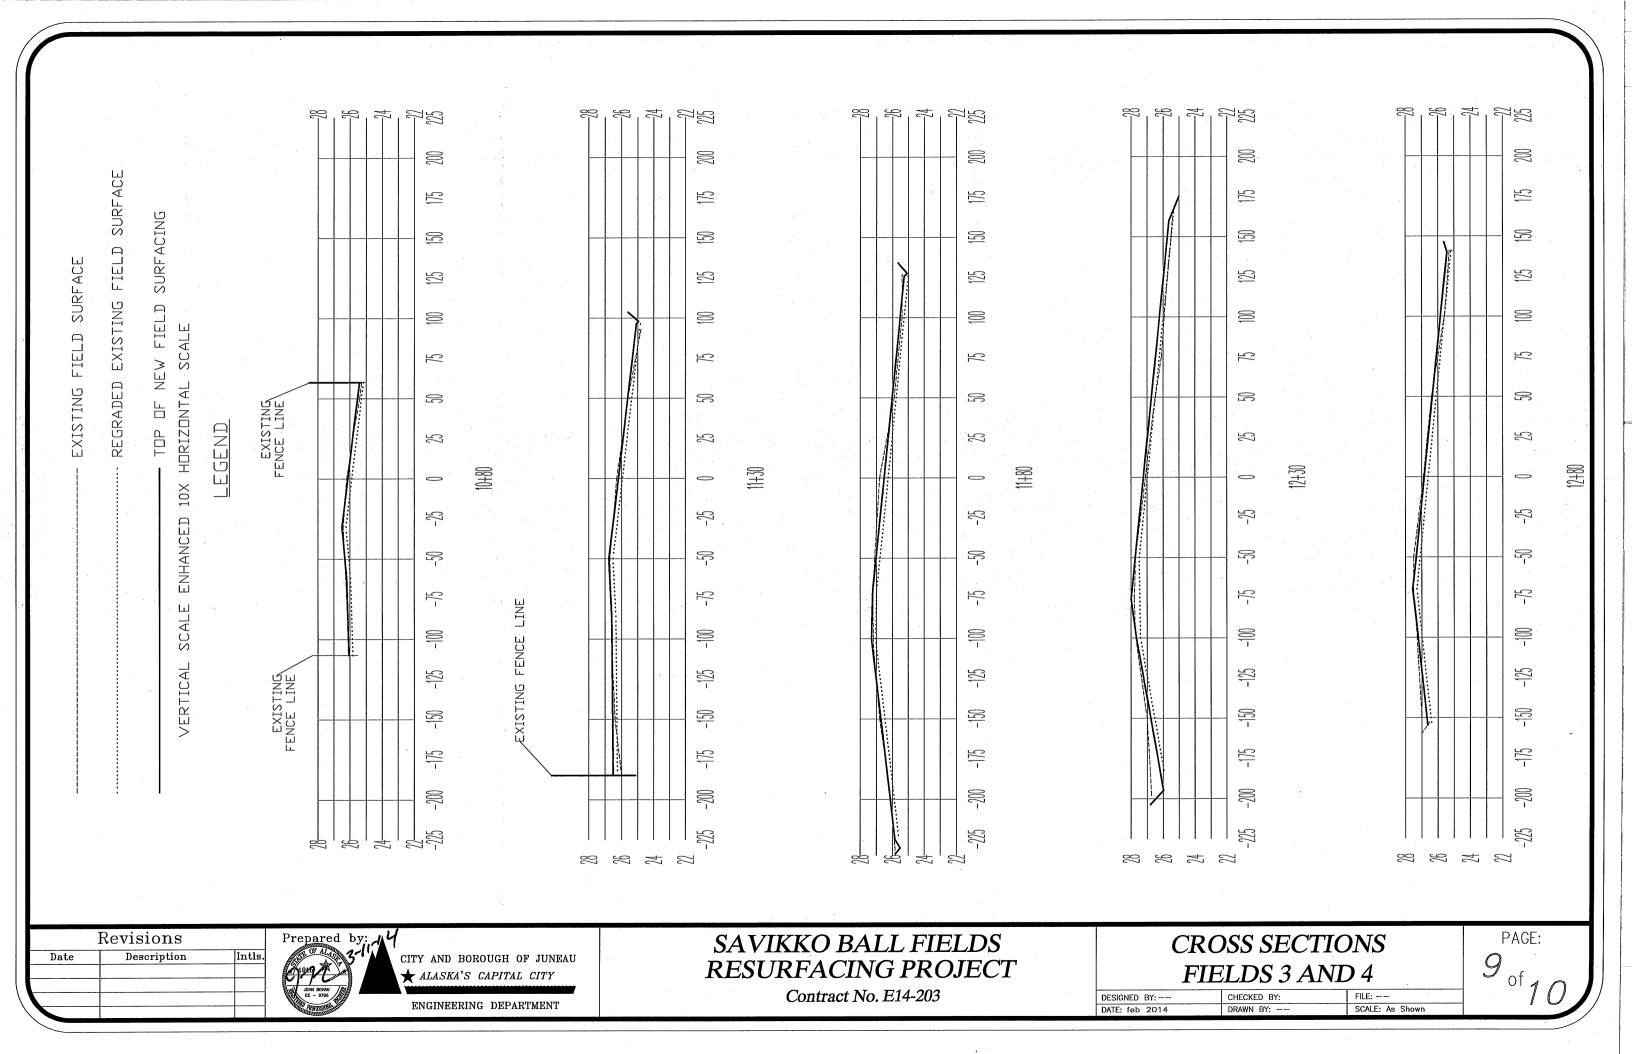

90 SURFACE 13 175 17 53 53 2 FIELD 125 125 []2 (72 172 8 8 8 8 FIEL 75 75 REGRADED 2 22 2 2 \$ \$2 35 35 25 15+30 -72 97-97--72 2 -22 5 Y-17 -72  $\subseteq \subseteq$ -13 -100 -172 -125 -175 -125 -125 -15 -150 -150 -175 -175 -175 -175 -300 -700 28 26 27 27 28 26 27 27 27 28 26 27 27 28 28 24 24 22 22 Revisions SAVIKKO BALL FIELDS **CROSS SECTIONS** PAGE: Description Date CITY AND BOROUGH OF JUNEAU RESURFACING PROJECT FIELDS 3 AND 4 ALASKA'S CAPITAL CITY Contract No. E14-203 CHECKED BY: DESIGNED BY: --ENGINEERING DEPARTMENT

DRAWN BY: --

DATE: feb 2014

SCALE: As Shown