



ADDENDUM TO THE CONTRACT

for the

Gastineau Elementary School Playground Upgrades

Contract No. E13-214

ADDENDUM NO.: ONE

CURRENT DEADLINE FOR BIDS:
April 19, 2013

PREVIOUS ADDENDA: NONE

ISSUED BY: City and Borough of Juneau
ENGINEERING DEPARTMENT
155 South Seward Street
Juneau, Alaska 99801

DATE ADDENDUM ISSUED: April 10, 2013

The following items of the contract are modified as herein indicated. All other items remain the same. This addendum has been issued and is posted online. Please refer to the CBJ Engineering Contracts Division webpage at: http://www.juneau.org/engineering_ftp/contracts/Contracts.php

DRAWINGS:

Item No. 1 Sheet C02 – GENERAL SITE PLAN. **Add** chain link fence on north side of basketball court with 20' returns on east and west sides for a total length of 125 linear feet of fencing.

Item No. 2 Sheet C17 – CHAIN LINK FENCE DETAILS. **Delete** in its entirety and **replace** with the Sheet C17 attached to this addendum.


Changes made to Sheet 17 include:

Add note at Detail 1 "3. FENCING TO BE 6' TALL AT ALL LOCATIONS EXCEPT AT BASKETBALL COURT WHERE FENCING TO BE 10' TALL."

Add note at Detail 1 "4. FENCE FOUNDATIONS TO BE 3'-6" DEEP AT BASKETBALL COURT WHERE FENCING TO BE 10' TALL."

Add references to Notes 3 and 4 on drawing dimensions for fence height and foundation depth respectively.


By: 
Jennifer Mannix,
Contract Administrator

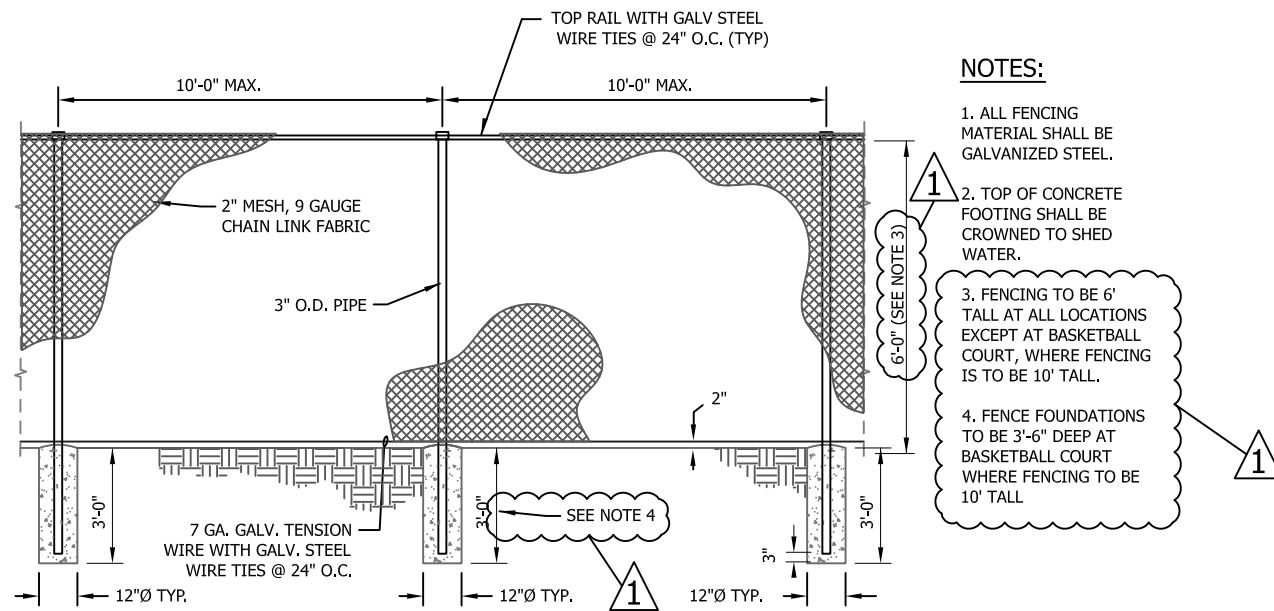

NOTES:

1. ALL FENCING MATERIAL SHALL BE GALVANIZED STEEL.
2. TOP OF CONCRETE FOOTING SHALL BE CROWNED TO SHED WATER.
3. FENCING TO BE 6' TALL AT ALL LOCATIONS EXCEPT AT BASKETBALL COURT, WHERE FENCING IS TO BE 10' TALL.
4. FENCE FOUNDATIONS TO BE 3'-6" DEEP AT BASKETBALL COURT WHERE FENCING TO BE 10' TALL


1 CHAINLINK FENCE: TYPICAL LINE FENCE + POSTS
SCALE: NTS

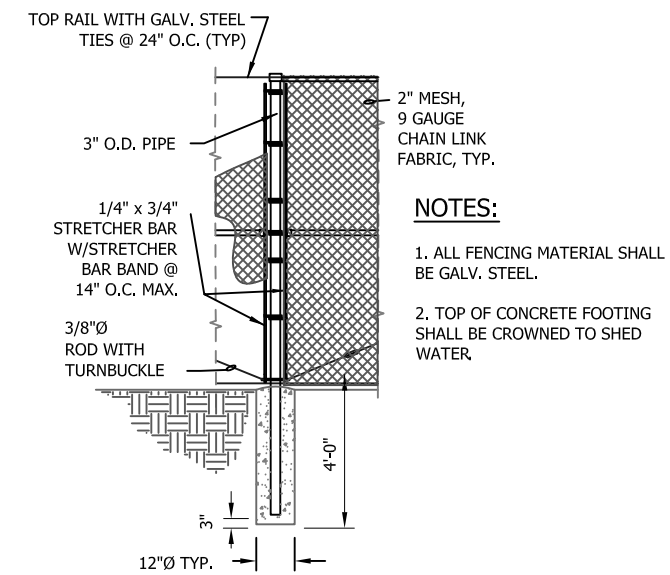

NOTES:

1. ALL FENCING MATERIAL SHALL BE GALV. STEEL.
2. TOP OF CONCRETE FOOTING SHALL BE CROWNED TO SHED WATER.


2 CHAINLINK FENCE: CORNER TO END POST
SCALE: NTS

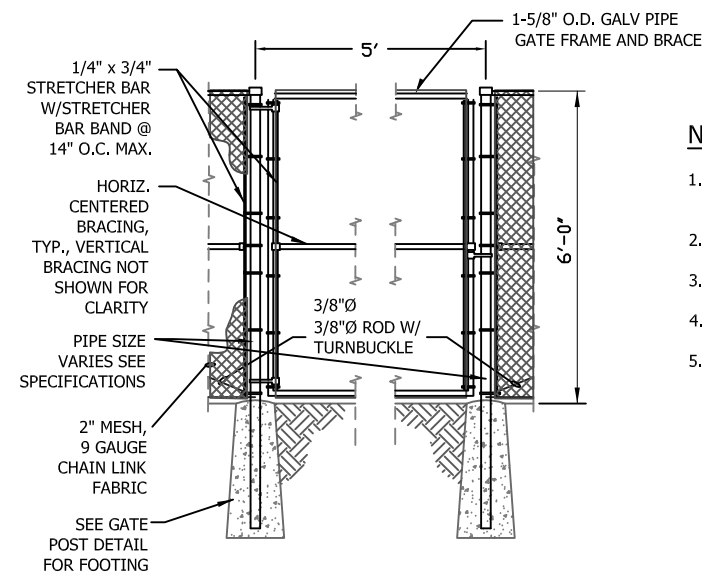

NOTES:

1. ALL FENCING MATERIAL INCLUDING GATE HARDWARE SHALL BE GALV. STEEL.
2. GATE SHALL BE PROVIDED WITH PROVISIONS FOR PADLOCKING.
3. CORNER FITTINGS FOR GATE FRAMES MAY BE USED IN LIEU OF WELDING.
4. GATE SHALL HAVE KNUCKLED SELVAGE TOP AND BOTTOM.
5. TOP OF CONCRETE FOOTING SHALL BE CROWNED TO SHED WATER.

3 CHAIN LINK SWING GATE DETAIL
SCALE: NTS

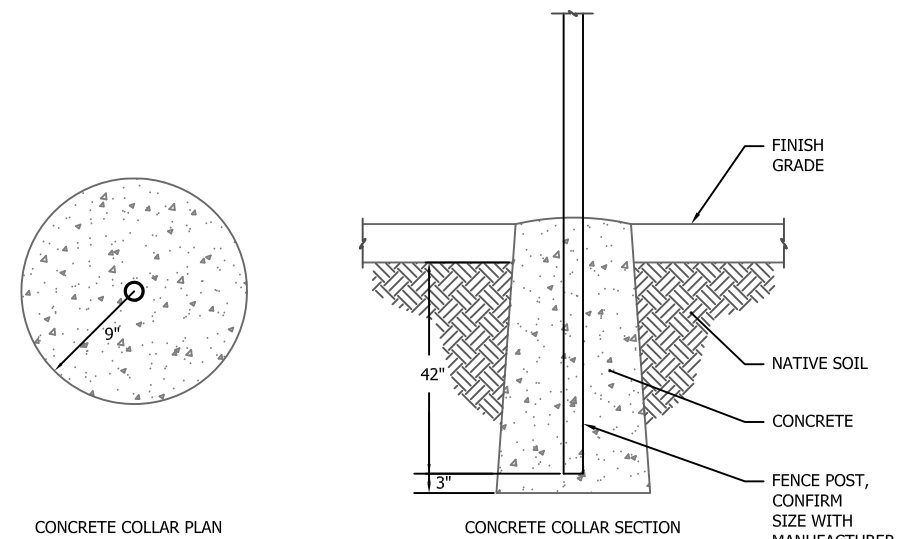

CONCRETE COLLAR PLAN

CONCRETE COLLAR SECTION

NOTES:

1. INSTALL CONCRETE COLLAR AROUND POSTS INSTALLED IN PAVED AREAS.
2. AFTER ADJUSTING POST TO FINISH GRADE, BACKFILL WITH CONCRETE ONLY.
3. ASHFORD FORMULA OR APPROVED EQUAL SHALL BE APPLIED AS A CURING COMPOUND, APPLICATION SHALL CONFORM TO MANUFACTURER RECOMMENDATIONS.
4. UNLESS IMMEDIATELY BACKFILLED WITH CONCRETE, ALL SAWCUTS AND EXCAVATIONS SHALL BE PROTECTED WITH STEEL PLATES OR OTHER SUITABLE MATERIALS.
5. INCREASE BOTTOM SECTIONS 6" CREATING BELL SHAPE.

4 CHAIN LINK GATE POST DETAIL
SCALE: NTS

GASTINEAU ELEMENTARY SCHOOL
PLAYGROUND UPGRADES

CBJ CONTRACT NO. E13-214
-Architecture Division
CITYBOROUGH OF JUNEAU Alaska's Capital City

Sheet Title:
CHAIN LINK FENCE
DETAILS



Scale: As Shown

Date:
MARCH 20, 2013

C17

Sheet number:
19 of 23