HAZARDOUS MATERIALS - GENERAL NOTES

- HAZARDOUS MATERIALS ARE SHOWN ON PLANS AS ADVISORY TO THE CONDITIONS PRESENT. REFER TO REQUIRED PROJECT WORK AND DEMOLITION PLANS TO DETERMINE IF HAZARDS NEED DISTURBED OR REMOVED.
- . LOCATIONS AND QUANTITIES OF HAZARDOUS MATERIALS (HM) WILL IMPACT THE WORK TO BE COMPLETED, AS SHOWN IN THE DRAWINGS. CONTRACTOR IS TO COORDINATE ALL HAZARDOUS MATERIALS PLAN INFORMATION WITH ALL SUBCONTRACTORS..
- 3. HIDDEN HAZARDS MAY BE FOUND DURING THIS PROJECT. HIDDEN HAZARDS SHALL BE ADDRESSED IN ACCORDANCE WITH THE PROJECT SPECIFICATIONS..
- THESE HM DRAWINGS ARE DIAGRAMMATIC AND DO NOT SHOW ALL EXISTING CONDITIONS THAT HAVE AN EFFECT ON WORK TO BE COMPLETED UNDER THIS PROJECT. CONTRACTOR IS TO INSPECT AND VERIFY EXISTING CONDITIONS AND ALL WORK TO BE COMPLETED PRIOR TO BIDDING.
- . CONTRACTOR IS RESPONSIBLE FOR INDEPENDENT THIRD PARTY MONITORING, AGGRESSIVE TEM CLEARANCE SAMPLING AND UPDATE OF AHERA MANAGEMENT PLAN (AMP) AND RESPONSE ACTION REPORT (RAR) AS REQUIRED FOR ALL ARATEMENT ACTIVITY
- . DRAWING DEPICTS BULK SAMPLING SURVEY LOCATIONS OF SUSPECT HAZARDOUS MATERIALS OBSERVED DURING ASSESSMENT. A COMPLETE TABLE OF LABORATORY RESULTS FOR EACH SAMPLE NOTED ON DRAWINGS CAN BE FOUND AT THE END OF THE SPECIFICATIONS OF ATTACHED PROJECT DOCUMENTS.

HAZARDOUS MATERIALS - SHEET NOTES

- TO REMOVE AND DISPOSE OF ASBESTOS CONTAINING FLOOR TILE AND MASTIC. SEE ARCHITECTURAL AND MECHANICAL DEMO PLANS.
- (2) REMOVE AND DISPOSE OF ALL GYPSUM WALLBOARD CONTAMINATED WITH ACM JOINT COMPOUND OFF WALLS AND CEILING FRAMING. SEE ARCHITECTURAL DEMO PLANS.
- 3 DEMO GYPSUM WALLBOARD WALLS WITH ASBESTOS CONTAINING JOINT COMPOUND SEE ARCHITECTURAL DEMO PLANS.
- ⊕ DEMO ACOUSTICAL CEILING TILE AND MASTIC. DISTURB GYPSUM WALLBOARD WITH ASBESTOS CONTAINING JOINT COMPOUND ONLY AS NECESSARY TO ACCOMPLISH WORK. SEE ARCHITECTURAL & ELECTRICAL DEMO PLANS.
- © CUT AND PATCH GYPSUM WALLBOARD CEILINGS WITH ASBESTOS CONTAINING JOINT COMPOUND ONLY AS NECESSARY TO COMPLETE THE WORK SEE MECHANICAL & ELECTRICAL DEMO PLANS.
- (6) CUT AND PATCH GYPSUM WALLBOARD WALLS AND CEILINGS WITH ASBESTOS CONTAINING JOINT COMPOUND ONLY AS NECESSARY TO COMPLETE THE WORK SEE ARCHITECTURAL, MECHANICAL & ELECTRICAL PLANS.
- REMOVE AND DISPOSE OF LEAD-BASED PAINTED CONVECTORS ATTACHED TO GYPSUM WALLBOARD WALLS WITH ASBESTOS CONTAINING JOINT COMPOUND. SEE ARCHITECTURAL & MECHANICAL DEMO PLANS.
- ® REMOVE AND DISPOSE OF STAINLESS STEEL SINK WITH ASBESTOS CONTAINING SOUND DEADENING UNDERCOATING. SEE ARCHITECTURAL DEMO PLANS.
- PREMOVE AND DISPOSE OF LEAD-BASED ENAMELED SINK. REMOVE AND DISPOSE OF LEAD CONTAINING VICTAULIC PIPE CONNECTORS AND PIPING AS NECESSARY TO COMPLETE THE WORK. SEE ARCHITECTURAL DEMO PLANS.
- REMOVE AND DISPOSE OF CERAMIC TILE CONTAINING LEAD-BASED GLAZING. SEE ARCHITECTURAL DEMO PLANS.
- (1) CUT AND PATCH GYPSUM WALLBOARD WALL AS NECESSARY TO ACCOMMODATE NEW WORK. SEE ARCHITECTURAL DEMO PLANS.
- 2 REMOVE AND DISPOSE OF EMERGENCY LIGHTS WITH LEAD-ACID BATTERIES.
- $\ensuremath{\textcircled{13}}$ REMOVE AND DISPOSE OF ELEVATOR DOOR WITH LEAD-BASED PAINT. SEE ARCHITECTURAL DEMO PLANS.
- 😥 REMOVE AND DISPOSE OF LEAD-CONTAINING BLACK BOARDS, WHITE BOARDS, AND/OR SYNTHETIC CORK BOARDS AS NECESSARY TO ACCOMMODATE WORK. SEE ARCHITECTURAL DEMO PLANS.
- (13) ALL ORIGINAL AHU DUCTWORK IN MECHANICAL ROOMS AND THROUGHOUT SCHOOL HAS ASBESTOS—CONTAINING DUCT TAPE APPLIED AT SEAMS. SEE MECHANICAL PLANS FOR DETERMINATION OF EXTENT OF DUCTWORK TO BE DISTURBED, REMOVED, AND/OR REPLACED TO ACCOMMODATE PROJECT WORK.
- REMOVE AND DISPOSE OF PIPE WITH ASBESTOS CONTAINING PIPE INSULATION CONCEALED WITHIN WALL TO BE DEMOLISHED, OR REMOVE AND DISPOSE OF PIPE WITH ASBESTOS CONTAINING PIPE INSULATION AS NECESSARY TO COMPLETE PLUMBING WORK. QUANTITY OF POTENTIAL ACM PIPE INSULATION IS UNKNOWN.
- ① CUT AND PATCH FLOOR CONTAINING ACM FLOOR TILE AND ACM MASTIC AS NECESSARY TO ACCOMMODATE MECHANICAL SOG REMOVAL FOR WASTE CONNECTION.

ASBESTOS CONTAINING MATERIALS (ACM)

THE FOLLOWING ASBESTOS CONTAINING MATERIALS (ACM) HAVE BEEN IDENTIFIED IN THE PROJECT AREAS THAT MAY BE DISTURBED BY DEMOLITION AND RENOVATION ACTIVITIES.

- 1. ACM PIPE INSULATION ON PIPE RUNS AND PIPE JOINTS CONCEALED ABOVE CEILING SPACES AND INSIDE WALLS THROUGHOUT SCHOOL.
- FLOOR TILE WITH BLACK MASTIC AND RESIDUAL BLACK FLOOR MASTICS FROM PREVIOUS ACM FLOORING REMOVED. RESIDUAL BLACK FLOORING MASTIC MAY EXIST BENEATH NEWER FLOORING IN VARIOUS QUANTITIES BUT OBSERVED MOSTLY AS HEAVY STAINING. ALL FLOOR TILE AND FLOOR TILE MASTIC THROUGHOUT SCHOOL CONTAINS ASBESTOS.
- 3. ACM DUCT TAPE EXISTS ON ALL ORIGINAL AHU DUCTWORK COMPONENTS IN MECHANICAL ROOMS AND ASSUMED ON ORIGINAL DUCTWORK THROUGHOUT SCHOOL.
- 4. GYPSUM WALLBOARD WITH ASSESTOS CONTAINING JOINT COMPOUND. ASSUME ALL GYPSUM WALLBOARD (CEILINGS & WALLS) THROUGHOUT ENTIRE SCHOOL

LEAD CONTAINING MATERIALS (LCM)

THE FOLLOWING LEAD CONTAINING MATERIALS (LCM) HAVE BEEN IDENTIFIED IN THE PROJECT AREAS THAT MAY BE DISTURBED BY DEMOLITION AND RENOVATION ACTIVITIES.

- 1. VICTAULIC PIPE CONNECTORS CONCEALED WITHIN WALLS AND ABOVE CEILINGS THROUGHOUT SCHOOL.
- 2. ELEVATOR DOORS WITH LEAD BASED PAINT. EACH FLOOR LEVEL.
- 3. SOUTH WALL AND CONVECTOR WITH LEAD BASED PAINT. ROOM 229.
- 4. CERAMIC TILE WITH LEAD-BASED GLAZING. BOYS AND GIRLS RESTROOMS, FIRST FLOOR AND SECOND FLOOR.
- 5. LEAD-BASED ENAMELED SINKS IN JANITOR ROOMS AND WHEREVER ELSE ENCOUNTERED THROUGHOUT PROJECT AREA.
- 6. LEAD CONTAINING BLACK BOARDS, WHITE BOARDS AND SYNTHETIC CORK BOARDS IN SOUTH CLASSROOMS WITHIN PROJECT AREA.

LEGEND

HAZARDOUS MATERIAL SHEET NOTE INDICATOR. SEE SHEET H100, HAZARDOUS MATERIAL SHEET NOTES, FOR INTERPRETATION.

CERAMIC TILE WITH LEAD-BASED GLAZING TO BE REMOVED - WALLS & FLOORS

EMERGENCY LIGHT WITH LEAD-ACID BATTERIES TO BE REMOVED

STAINLESS STEEL SINK WITH ACM UNDERCOATING TO BE REMOVED

XXX ASBESTOS SAMPLE LOCATIONS — NEGATIVE (<1% ASBESTOS)

ASBESTOS SAMPLE LOCATIONS — POSITIVE (2 1% ASBESTOS)



522 West 10th Street uneau, Alaska 99801 phone 907-586-1070 fax 907-586-3959 jensenyorbalott.com





ITY & BOROUGH OF JUNEAU [ARIE DRAKE SCHOOL RENOVATION Inneau, Alaska

REVISIONS .

 \triangle

SHEET TITLE

GENERAL NOTES


SHEET NOTES - LEGEND


HAZARDOUS

MATERIALS

DATE: MARCH 2012

H100

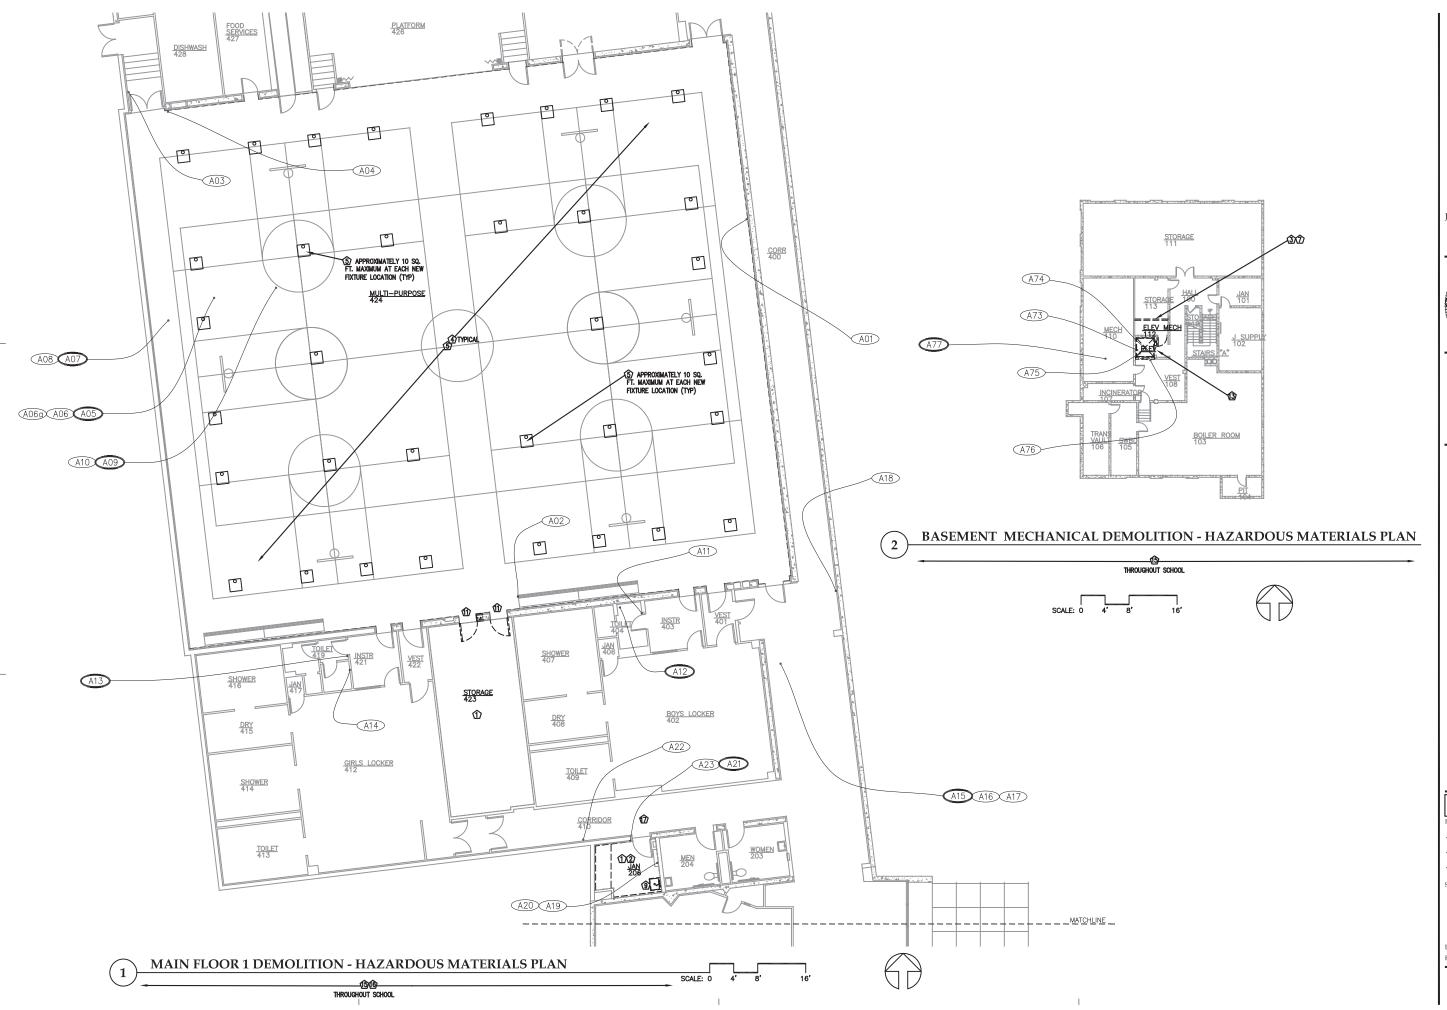

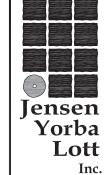

522 West 10th Street Juneau, Alaska 99801 phone 907-586-1070 fax 907-586-3959 jensenyorbalott.com






CITY & BOROUGH OF JUNEAU MARIE DRAKE SCHOOL RENOVATION Juneau, Alaska

REVISIONS .

SHEET TITLE MAIN FLOOR 1

ELEVATOR MECH. RM HAZARDOUS MATERIALS PLAN DATE: MARCH 2012

FILE: 11078

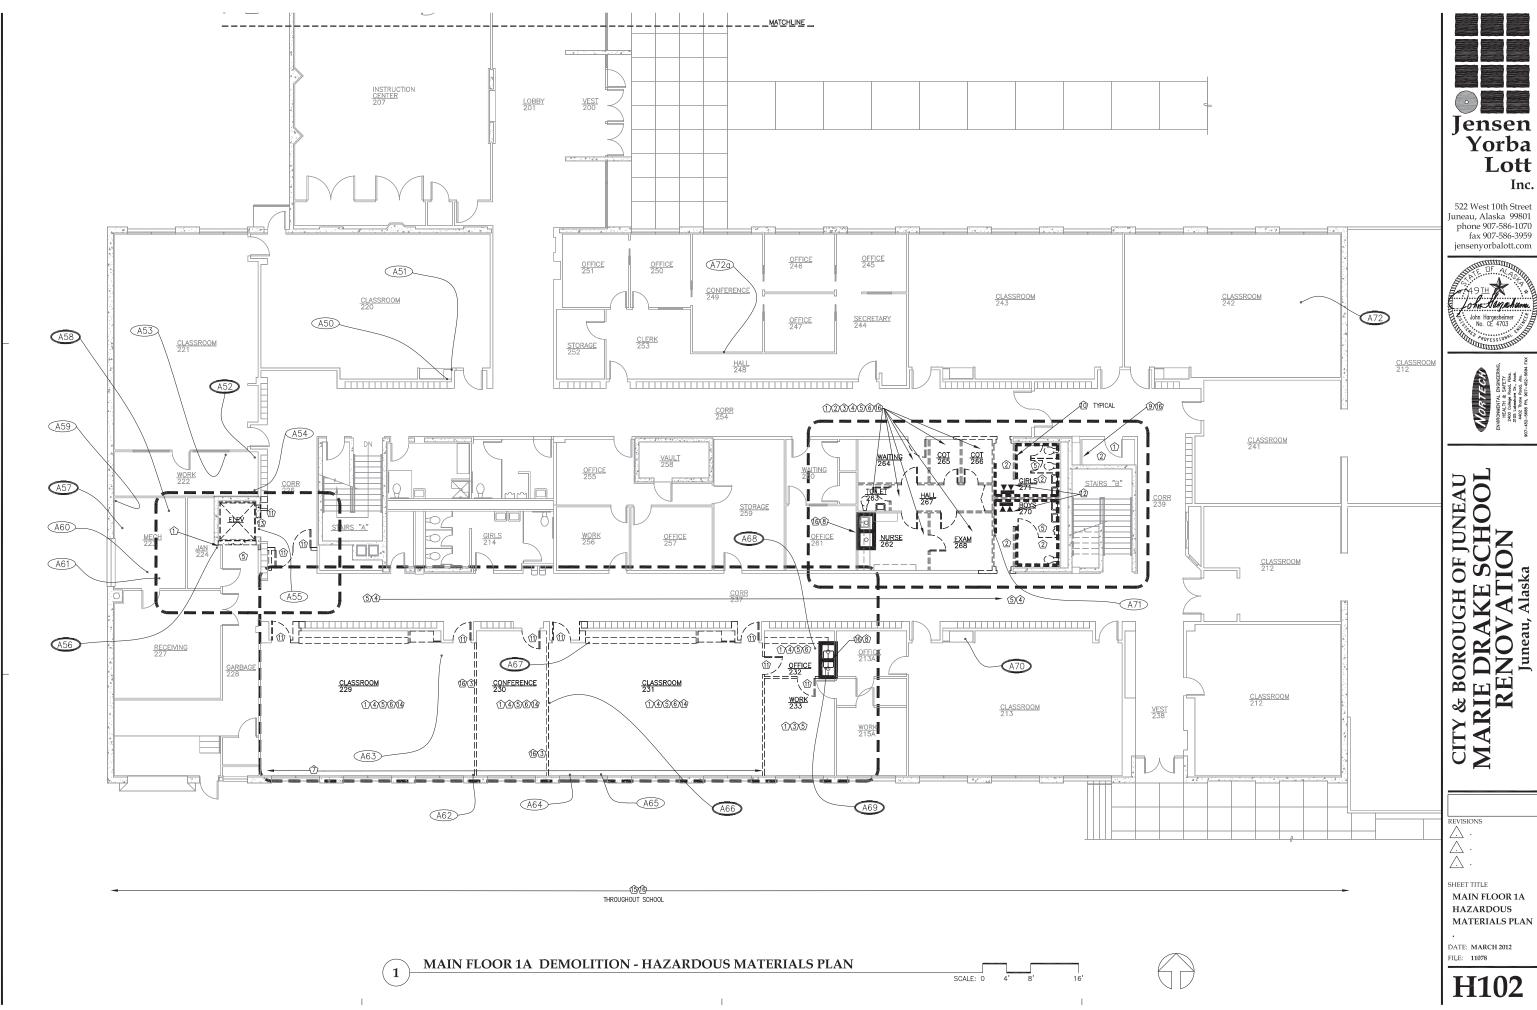


Yorba Lott


uneau, Alaska 99801 phone 907-586-1070 fax 907-586-3959





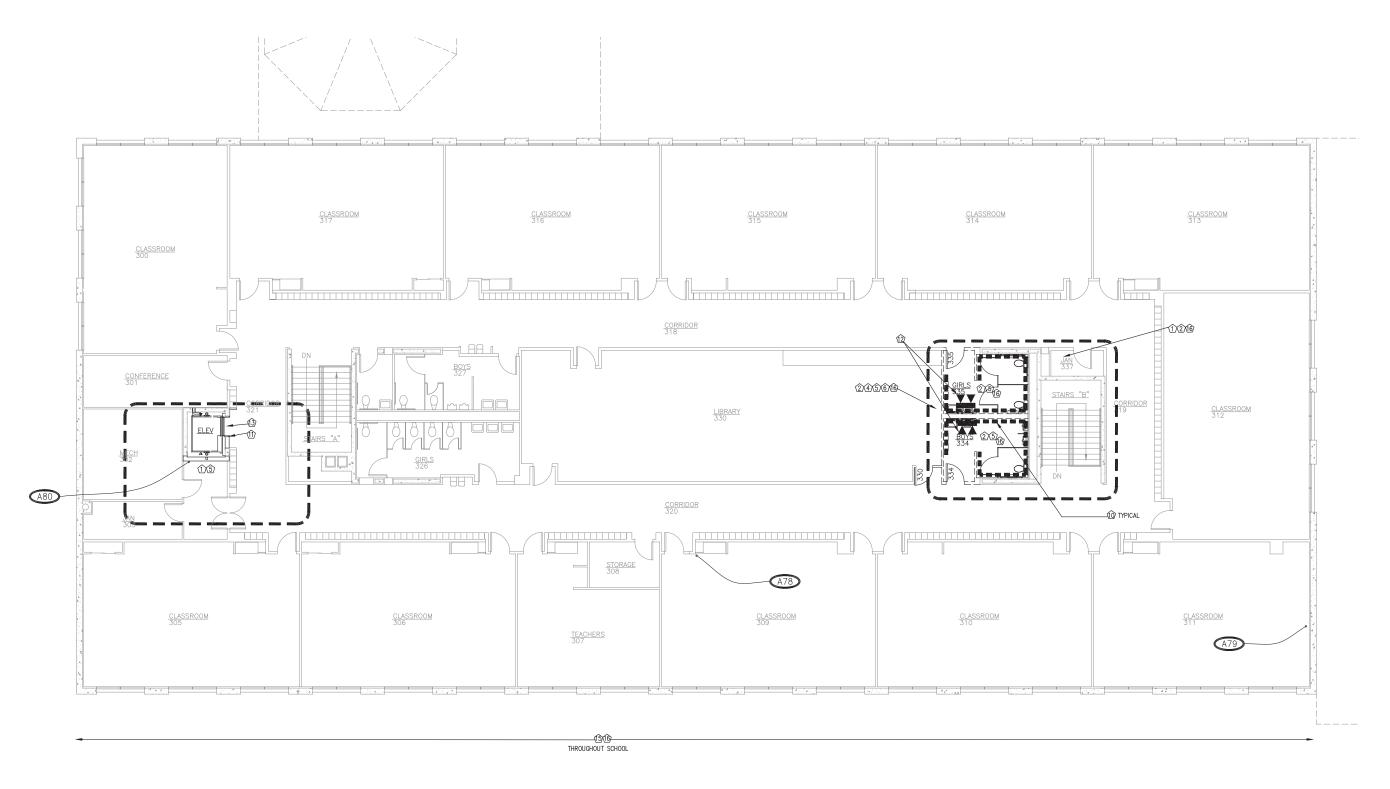

SECOND FLOOR DEMOLITION - HAZARDOUS MATERIALS PLAN

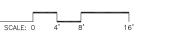





Lott Inc.

522 West 10th Street Juneau, Alaska 99801 phone 907-586-1070 fax 907-586-3959 jensenyorbalott.com





CITY & BOROUGH OF JUNEAU MARIE DRAKE SCHOOL RENOVATION Juneau, Alaska

REVISIONS
...
...
...

SHEET TITLE SECOND FLOOR HAZARDOUS

DATE: MARCH 2012

FILE: 11078

MATERIALS PLAN

ABBREVATIONS

A) AB	ABOVE ANCHOR BOLT	FD	FLOOR DRAIN	P/C	PRECAST
VC	ASPHALITC CONCRETE	FDN	FOUNDATION		PERPINDICULAR
ACI	AMERICAN CONCRETE INSTITUTE	FIN	FINISH, FINISHED		PLATE (STEEL), PROPERTY LINE
NDDL	ADDITIONAL	FF	FINISHED FLOOR, FAR FACE	PJ	PANEL JOINT "
GGR	AGGREGATE	FLG	FLANGE	PL	PLATE (WOOD)
JSC	AMERICAN INSTITUTE OF STEEL	FLR	FLOOR	PLCS	PLACES
	CONSTRUCTION	FLASH	FLASHING	PLWD	PLYWOOD
ISI	AMERICAN IRON AND STEEL INSTITUTE	FOS	FACE OF STUDS	PP	PARTIAL PENETRATION
ITC .	AMERICAN INSTITUTE OF TIMBER	FP	FIREPROOF, FULL PENETRATION	P/S	PRESTRESSED
	CONSTRUCTION	FS	FAR SIDE	PSF	POUNDS PER SQUARE FOOT
LT	ALTERNATE	FT OR'	FOOT, FEET	PSI	POUNDS PER SQUARE INCH
LUM RCH	ALUMINUM ADOLUTECT ADOLUTECTURAL	FTG FUT	FOOTING FUTURE	PT P/T	PRESSURE TREATED
iron B	ARCHITECT, ARCHITECTURAL AT	FV	FIELD VERIFY	PVC	POST TENSION POLYVINYL CHLORIDE
PPROX		r v	FIELD VERIFT	PVMT	PAVEMENT
SCE	AMERICAN SOCIETY OF CIVIL ENGINEERS	GA	GAUGE, GAGE	LAMI	FAVEMENT
SPH	ASPHALT	GALV	GALVANIZED	R	RADIUS
STM	AMERICAN SOCIETY FOR TESTING	GEN	GENERAL	RD.	ROOF DRAIN, ROUND
	MATERIAL	GIRD	GIRDER	0	ROUND
WS	AMERICAN WELDING SOCIETY	GL	GLUE LAMINATED	REF	REFERENCE
	AND	GND	GROUND	REINF	REINFORCING, REINFORCEMENT,
		GR	GRADE		REINFORCED
3)	BELOW	GWB	GYPSUM WALL BOARD	REQD	REQUIRED
	BOTTOM (BEAM AND JOIST SCHEDULES	GYP	GYPSUM	RO	ROUGH OPENING
	ONLY)				
D	BOARD	HEF	HORIZONTAL EACH FACE	s	AMERIAN STANDARD STEEL SHAPE
ITUM	BITUMINOUS	HORIZ	HORIZONTAL	00:	SOUTH
	BUILDING LINE	HP	HIGH POINT, HP STEEL SHAPE	SCHED	SCHEDULE
LDG	BUILDING BLOCK	HSB	HIGH STRENGTH BOLT	SEC-	SECTION SHEAD DI ATE
LKG		HSS	HOLLOW STRUCTURAL SECTION	SH	SHEAR PLATE
lkg od	BLOCKING BOTTOM OF DECK	HT	HEIGHT	SHT SHTG	SHEET
M	BOTTOM OF DECK BEAM	IBC	INTERNATIONAL BUILDING CODE	SHIG	SHEETING SIMILAR
M OT	BOTTOM	ID.	INSIDE DIAMETER	SIM	STRUCTURAL INSULATED PANEL
RG	BEARING	ΪΕ	INVERT ELEVATION	SLBB	SHORT LEGS BACK TO BACK
SMT	BASEMENT	IF	INSIDE FACE	SP	SPIRAL
TWN	BETWEEN	IN OR "	INCH	SPA	SPACE, SPACING
		INCL	INCLUDE	U. / .	SPACES
	AMERICAN CHANNELS	INSUL	INSULATION, INSULATED, INSULATE	SPEC	SPECIFICATION
В	CATCH BASIN	INT	INTERIOR	SQ	SQUARE
G	CENTER OF GRAVITY			SS	STAINLESS STEEL
J	CONSTRUCTION JOINT	JT	JOINT	SSL	SHORT SLOTTED HOLE
IP .	CAST-IN-PLACE	JST	JOIST	ST	STRUCTURAL T FROM S SERIES SE
	CENTER LINE			STA	STATION
JP .	COMPLETE JOINT PENETRATION	K	KIP, KIPS	STD	STANDARD
LKG	CAULKING	KSI	KIPS PER SQUARE INCH	STIFF	STIFFENED
LR	CLEAR			STIRR	STIRRUP
MP	CORRUGATED METAL PIPE	LB OR #	POUND	STL	STEEL
MU	CONCRETE MASONRY UNIT	LLBB	LONG LEG BACK TO BACK	STRUCT	STRUCTURAL
0	CLEANOUT, CONCRETE OPENING	LLH	LONG LEGS HORIZONTAL	SUP	STRUCTURAL USE PANEL
OL	COLUMN	LLV LONGIT	LONG LEGS VERTICAL	SUPT	SUPPORT
ONC	CONCRETE CONNECTION	LP	LONGITUDINAL LOW POINT	SUSP SYMM	SUSPENDED
ONSTR		LSL	LONG SLOTTED HOLES	STIMIN	SYMMETRICAL
ONT	CONTINUOUS	LT	LIGHT	Т	TOP
ONTR	CONTRACTOR	LT WT	LIGHT WEIGHT	Τ̈́C	TOP OF CURB
TJ, CJ	CONTROL JOINT, CONTRACTION JOINT	Ī	ANGLE	T&G	TOUNGE AND GROOVE
TR	CENTER	-		TEMP	TEMPERATURE, TEMPORARY
TSK	COUNTERSUNK	М	MISCELLANEOUS SHAPE	THK	THICK
U	CUBIC	MAS	MASONRY	THRU	THROUGH
		MATL	MATERIAL	TOC	TOP OF CONCRETE
BL	DOUBLE	MAX	MAXIMUM	TOS	TOP OF STEEL
EPT	DEPARTMENT	MC	MISCELLANEOUS CHANNEL SECTION	TOW	TOP OF WALL
ET	DETAIL	MECH	MECHANICAL	TP	TOP OF PAVEMENT
	DIAMETER	MEMB	MEMBRANE	TRANS	TRANSVERSE
IAB	DRILLED-IN ADHESIVE BOLT	MFR	MANUFACTURER	TS	STRUCTURAL TUBE
IAG	DIAGONAL	MFRG	MANUFACTURING	TYP	TYPICAL
IAPH	DIAPHRAGM	MIN	MINIMUM		I I I I I I I I I I I I I I I I I I I
IEB	DRILLED-IN EXPANSION BOLT	MISC	MISCELLANEOUS	UBC	UNIFORM BUILDING CODE
IM M	DIMENSION	MT	STRUCTURAL TEE FROM M SERIES SECTION	UL	UNDERWRITERS LABORATORY
N	DOWN	MTD	MOUNTED	UON UT	UNLESS OTHERWISE NOTED ULTRASONIC TEST
o IP	DEEP	MTL	METAL	UI	OLIMASUNIC TEST
WG	DRAWING	WIL	ma rek	VEF	VERTICAL EACH FACE
WL	DOWEL	N	NORTH	VERT	VERTICAL EACH FACE VERTICAL
		NF	NEAR FACE	VERI	VERTICAL EACH FACE
	EAST	NIC	NOT IN CONTRACT	VOF	VERTICAL OUTSIDE FACE
A	EACH	No OR#	NUMBER		
В	EXPANSION BOLT	NOM	NOMINAL	w	WEST, W SERIES SECTION
F	EACH FACE	NS	NEAR SIDE	w/	WITH
XJ	EXPANSION JOINT	NTS	NOT TO SCALE	W/O	WITHOUT
Ĺ	ELEVATION (HEIGHT)			WD	WOOD
LEC	ELECTRICAL	OA	OVERALL	WH	WEEP HOLE
LEV	ELEVATOR	OC	ON CENTER	WP	WATERPROOF, WORK POINT
NCL	ENCLOSURE	OD	OUTSIDE DIAMETER	WPJ	WEAKENED PLANE JOINT
NGR	ENGINEER	OF	OUTSIDE FACE	WT	WEIGHT, STRUCTURAL TEE FROM V
Q	EQUAL	OPNG	OPENING		SERIES SECTION
QJ	EARTHQUAKE JOINT	OPP	OPPOSITE	WWF	WELDED WIRE FABRIC
QUIP	EQUIPMENT	ovs	OVERSIZED		
S	EACH SIDE			YD	YARD
	EACH WAY				
W XIST, (E) XIP	EXISTING EXPANSION				

GENERAL NOTES

THE FOLLOWING NOTES APPLY UNLESS INDICATED OTHERWISE:

CODE:

INTERNATIONAL BUILDING CODE, 2009 EDITION.

DESIGN LIVE LOADS:

ROOF PG = 60 PSF, PF = 50 PSF I = 1.1, CE = 1.0, CT = 1.0

ASCE 7-05, CHAPTER 7 SNOW DRIFT

FLOORS UNIFORM

40 PSF, WITH LIVE LOAD REDUCTION

EQUIVALENT LATERAL

FLUID PRESSURE BASEMENT WALLS

60 PCF

REINFORCED CONCRETE

ALL CONCRETE - F'C = 3000 PSI, MAXIMUM W/C = 0.50. SUBMIT MIX DESIGN. SEE SPECIFICATIONS FOR

UNLESS OTHERWISE NOTED, REINFORCING STEEL SHALL CONFORM TO ASTM A615, GRADE 60. PROVIDE CLASS B SPLICE. SUBMIT REINFORCING STEEL SHOP DRAWINGS WITH DETAILS PER ACI 315 MANUAL OF STANDARD PRACTICE.

CONCRETE COVER:

FOOTINGS 3". WALLS 1", EXCEPT 2" AGAINST EARTH. SLABS ON GRADE 1 1/2".

RIGIDLY SUPPORT BARS WITH CONCRETE BLOCKS OR APPROVED ACCESSORIES.

PROVIDE SLAB REINFORCING AS FOLLOWS: 4" SLAB ON GRADE, #3 @ 15" EACH WAY, 1 1/2" FROM TOP,

REINFORCE AS FOLLOWS:

8" WALLS, #5 @ 15" HORIZONTAL AND VERTICAL @ CENTER OF WALL,

AT CORNERS, PROVIDE CORNER BARS IN OUTSIDE FACE OF SAME SIZE AND SPACING AS HORIZONTAL BARS, 50 DIA. EACH LEG, WHERE POSSIBLE.

PROVIDE 2-#5 LONGITUDINAL BARS AT TOP OF WALLS. PROVIDE ROUGHENED SURFACE AT CONSTRUCTION

PROVIDE VERTICAL DOWELS OF SAME SIZE, NUMBER AND SPACING AS VERTICAL BARS.

DRILL-IN ADHESIVE ANCHORS (DIAA):

"HIT-RE 500-SD" ADHESIVE ANCHOR SYSTEM BY HILTI FASTENING SYSTEMS FOR CONCRETE OR APPROVED

ALL STEEL ASTM A36, EXCEPT WIDE FLANGE SECTIONS TO BE ASTM A992, OR A572-60. FABRICATION AND ERECTION PER AISC SPECIFICATIONS. FABRICATOR SHALL PARTICIPATE IN AISC QUALITY CERTIFICATION PROGRAM AND BE DESIGNATED AN AISC CERTIFIED PLANT, CATEGORY STD. SUBMIT SHOP DRA

WELDING PER AWS D1.1. MINIMUM SIZE WELDS 3/16" CONTINUOUS FILLET. WELDERS CERTIFIED PER AMERICAN WELDING SOCIETY FOR ROD AND POSITION. ELECTRODES SHALL BE E70XX MINIMUM, WITH MINIMUM CHARPY V-NOTCH TOUGHNESS OF 20 FT-LB AT -20 DEG F

HIGH-STRENGTH BOLTS PER ASTM A325. TYPICAL BOLTED CONNECTIONS - SNUG TIGHTENED TYPE. TENSION HIGH-STRENGTH BOLTS BY DIRECT TENSION INDICATOR METHOD USING LOAD INDICATOR DEVICES INSTALLED PER MANUFACTURER'S INSTRUCTIONS

APPLY ONE COAT OF SHOP PAINT TO ALL STEEL.

COLD-FORMED STEEL FRAMING:

GALVANIZED STEEL SHALL BE ASTM A653, FY = 50 KSI, EXCEPT 43 MIL AND LIGHTER SHALL BE FY = 33 KSI. ALL STRUCTURAL MEMBERS SHALL BE DESIGNED IN ACCORDANCE WITH AISI SPECIFICATION FOR THE DESIGN OF COLD-FORMED STEEL STRUCTURAL MEMBERS*.

WALL STUDS - 600S162-33

JOISTS - 600S162-33

SHEATHING:

SHEATHING GRADE - CD EXPOSURE 1 WITH EXTERIOR GLUE LAID FACE GRAIN PERPENDICULAR TO SUPPORT.

ROOF SHEATHING - 3/4" THICK, 48/24 SPAN RATING. WALL SHEATHING - 1/2" THICK, 32/16 SPAN RATING

SCREWS AT ALL PANEL EDGES IS AS FOLLOWS:

ROOF SHEATHING - #10 @ 6" OC. WALL SHEATHING - #10 @ 6" OC.

SCREWS AT ALL PANEL INTERMEDIATE SUPPORTS OTHER THAN STUDS WITH HOLDOWNS IS AS FOLLOWS

ROOF SHEATHING -#10 @ 12" OC, WALL SHEATHING -#10 @ 12" OC.

MISCELLANEOUS:

CONTRACTOR SHALL VERIFY ALL EXISTING DIMENSIONS, MEMBER SIZES AND CONDITIONS PRIOR TO COMMENCING ANY WORK. ALL DIMENSIONS OF EXISTING CONSTRUCTION SHOWN ON THE DRAWINGS ARE INTENDED AS GUIDELINES ONLY AND MUST BE VERIFIED. THE EXISTING CONDITIONS SHOWN ON THE DRAWINGS ARE BASED ON EITHER SITE OBSERVATION, ORIGINAL DRAWINGS OR WERE ASSUMED BASED ON EXPECTED CONDITIONS. IF THE EXISTING CONDITIONS DO NOT CLOSELY MATCH THE CONDITIONS SHOWN ON THE DRAWINGS, OR IF THE EXISTING MATERIALS ARE OF QUESTIONABLE OR SUBSTANDARD QUALITY, NOTIFY THE ARCHITECT PRIOR TO COMMENCING ANY WORK.

DRAWINGS INDICATE GENERAL AND TYPICAL DETAILS OF CONSTRUCTION. WHERE CONDITIONS ARE NOT SPECIFICALLY INDICATED BUT ARE OF SIMILAR CHARACTER TO DETAILS SHOWN, SIMILAR DETAILS OF CONSTRUCTION SHALL BE USED SUBJECT TO REVIEW AND APPROVAL BY THE ARCHITECT AND STRUCTURAL

REFER TO ARCHITECTURAL DRAWINGS FOR WALL OPENINGS, ARCHITECTURAL TREATMENT AND DIMENSIONS

REFER TO MECHANICAL AND ELECTRICAL DRAWINGS FOR SIZE AND LOCATION OF DUCT OPENINGS, PIPING, CONDUITS, ETC, NOT SHOWN.

SHOP DRAWINGS SHALL BE SUBMITTED AND REVIEWED PRIOR TO FABRICATION.

PROVIDE TEMPORARY ERECTION BRACING AND SHORING AS REQUIRED FOR STABILITY OF THE STRUCTURE DURING ALL PHASES OF CONSTRUCTION.

REFER TO SPECIFICATIONS FOR INFORMATION NOT CONTAINED IN THESE GENERAL NOTES.

522 West 10th Street

Lott

uneau, Alaska 99801 phone 907-586-1070 fax 907-586-3959 jensenvorbalott.com






OF IUNEAU & BOROUGH

REVISIONS

 \triangle . \triangle .

SHEET TITLE GENERAL NOTES AND ABBREVIATIONS


DATE: MARCH 2012 FILE: 11078

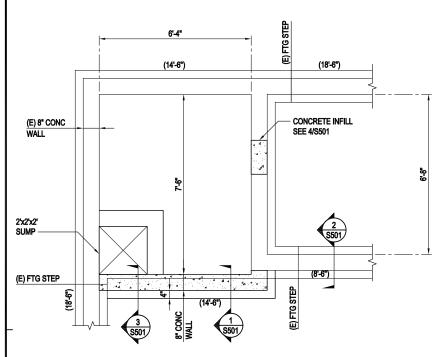

NOTE:


1. TOP OF FOOTING ELEVATION IS NOTED THUS: (X'-Y")

1 PARTIAL FOUNDATION PLAN SCALE: 1/2" = 1'-0"

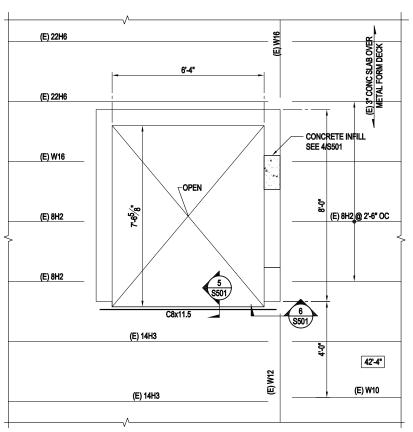

NOTE:
1. TOP OF CONCRETE ELEVATION IS NOTED THUS: X'-Y"


PARTIAL 2nd FLOOR FRAMING PLAN
SCALE: 1/2" = 1'-0"

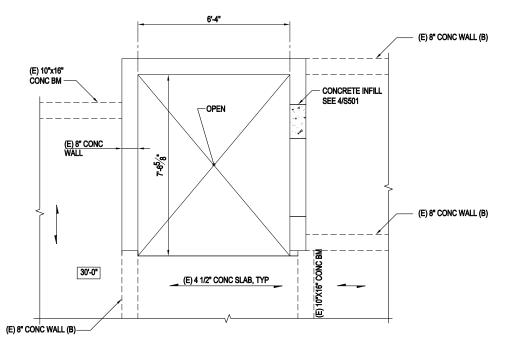

NOTE:

1. TOP OF SLAB ELEVATION IS NOTED THUS: X'-Y"

PARTIAL MAIN FLOOR FRAMING PLAN
SCALE: 1/2" = 1'-0"

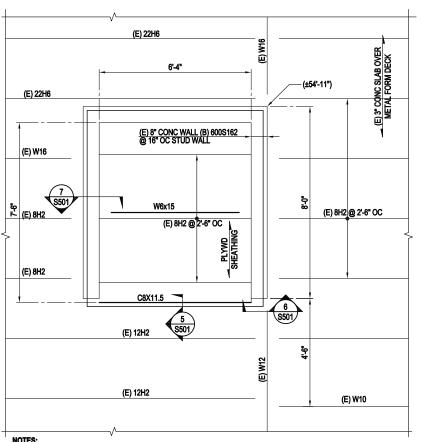

NOTES:

1. TOP OF CONCRETE ELEVATION VARIES. ELEVATION OF TOP OF CONCRETE IS NOTED THUS: (X'-Y")

2. SEE ARCHITECT FOR DEMOLITION OF EXISTING ELEVATOR ROOF SLAB.

PARTIAL MAIN ROOF FRAMING PLAN
SCALE: 1/2" = 1'-0"

Jensen Yorba Lott

> 522 West 10th Street Juneau, Alaska 99801 phone 907-586-1070 fax 907-586-3959 jensenyorbalott.com



BBFM
Engineers Inc.
510 L Street, Suite 200
Phoches en 119 98509-1139
Phone: (807) 274-2236 Fax: 274-2520

TY & BOROUGH OF JUNEAU MARIE DRAKE RENOVATION Juneau, Alaska

REVISIONS

REVISIONS .

SHEET TITLE


PARTIAL


FOUNDATION


PLANS


DATE: **MARCH 2012** FILE: **11078**


S201

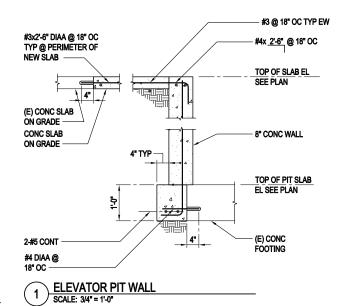

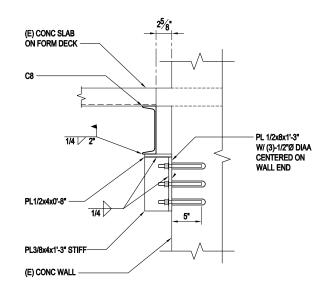


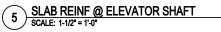


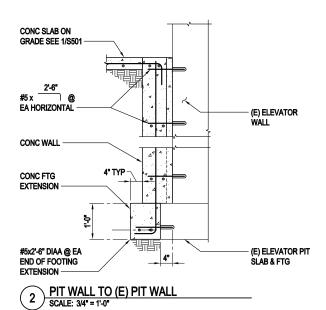

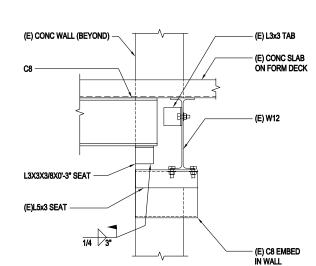




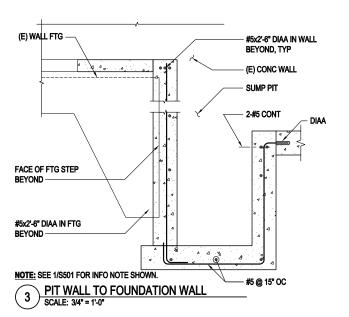

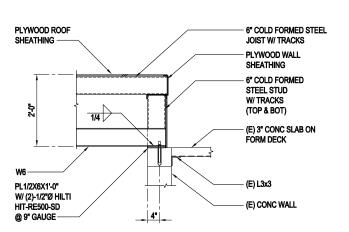



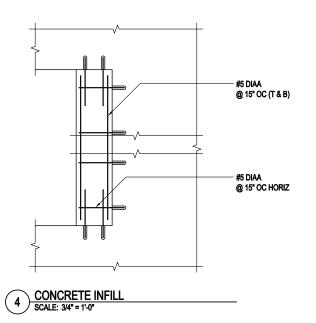



522 West 10th Street Juneau, Alaska 99801 phone 907-586-1070 fax 907-586-3959 jensenyorbalott.com

Inc.



Engineers Inc.
510 L Street, Suite 200
P.O. Box 91199
According 1999
According 19

Y & BOROUGH OF JUNEAU MARIE DRAKE RENOVATION Juneau, Alaska

REVISIONS

CITY

<u></u> . ∴

SHEET TITLE **DETAILS**

DATE: **MARCH 2012** FILE: **11078**

S501

FLOWSETTER AND AUTOMATIC VALVE SCHEDULE CONTINUED

NUMBER	UNIT SERVED	LOCATION	DESIGN GPM	SETTER SIZE (INCHES)	VALVE TYPE	VALVE OPERATION	NORMAL POSITION	NOTES
1	FP	CLASSROOM 229	1.1	3/4	2-WAY	ON-OFF	N.O.	-
2	FP	CLASSROOM 230	1.1	3/4	2-WAY	ON-OFF	N.O.	-
3	FP	CLASSROOM 231	1.1	3/4	2-WAY	ON-OFF	N.O.	-
4	FP	CLASSROOM 232	1.1	3/4	2-WAY	ON-OFF	N.O.	-

HEATING UNIT SCHEDULE


EQUIPMENT	DESIGN MANUFACTURER	MODEL	CONTROLS/OPTIONS
FINNED PIPE, FP-1	RITTLING	FS_5	SINGLE-TIER, 1090 BTU/HR/FT WATER RATING AT AVERAGE 180'F WATER TEMP., 65' EAT, 3 FPS WATER VELOCITY. 1" STEEL TUBE WITH 4-1/4 X 4-1/4 ALUMINUM FINS. MAXIMUM 40 FPF. IBR RATED. 14" HIGH SLOPING TOP, WALL-MOUNTED CABINET. ACCESS DOORS AT ALL VALVES. FINISH COLOR SELECTED BY ARCHITECT.

PUMP SCHEDULE

PUMP NUMBER	FUNCTION	GALLONS PER MINUTE (GPM)	HEAD DEVELOPED (FT. OF WATER)	DESIGN MANUFACTURER AND MODEL	MINIMUM HORSEPOWER ELECTRICAL CHARACTERISTICS	FEATURES
SP-1	ELEVATOR SUMP PUMP	50	25	B&G	1/2 HP, 120V SINGLE PHASE	SUBMERSIBLE SUMP PUMP.

PLUMBING FOLIPMENT SCHEDULE


		PLUMBING EQUIPMENT SCHEDULE
EQUIPMENT	DESIGN MANUFACTURER	OPTIONS/TRIM
WATER CLOSET, WC-1	KOHLER, KINGSTON	WALL HUNG, SIPHON JET VITREOUS CHINA CLOSET BOWL, WITH ELONGATED RIM, 1-1/2 INCH TOP SPUD, CHINA BOLT CAPS. EXPOSED MANUAL DUAL FLUSH VALVE: ASME A112.18.1; EXPOSED POLISHED CHROME, DIAPHRAGM TYPE, WITH SCREWDRIVER STOP AND VACUUM BREAKER; MAXIMUM 1.6 GALLON FLUSH VOLUME. ADA COMPLIANT, SIMILAR TO ZURN Z-6000 SERIES. SEAT: SOLID PLASTIC, ELONGATED, OPEN FRONT, EXTENDED BACK, SELF-SUSTAINING HINGE, BRASS BOLTS, WITHOUT COVER. WALL MOUNTED CARRIER: ASME A112.6.1; ADJUSTABLE CAST IRON FRAME, INTEGRAL DRAIN HUB AND VENT, ADJUSTABLE SPUD, LUGS FOR FLOOR AND WALL ATTACHMENT, THREADED FIXTURE STUDS WITH NUTS AND WASHERS, SUITABLE FOR SPACE PROVIDED. BELL AND SPIGOT TYPE USED ON VERTICAL UNITS AT SLAB-ON-GRADE LOCATIONS. VERTICAL UNITS MAY BE NON-ADJUSTABLE. MOUNT AT ADA HEIGHT.
WATER CLOSET, WC-2	KOHLER, KINGSTON	WALL HUNG, SIPHON JET VITREOUS CHINA CLOSET BOWL, WITH ELONGATED RIM, 1-1/2 INCH TOP SPUD, CHINA BOLT CAPS. EXPOSED PAINAINAL DUAL FLUSH VALVE: ASME A112.18.1; EXPOSED POLISHED CHRONE, DIAPHRAGM TYPE, WITH SCREWBRIVER STOP AND VACUUM BEBAKER; MAXIMUM 1.6 CALLON FLUSH VOLUME. ADA COMPLIANT, SIMILAR TO ZURN Z-6000 SERIES. SEAT: SOLID PLASTIC, ELONGATED, OPEN FRONT, EXTENDED BACK, SELF-SUSTAINING HINGE, BRASS BOLTS, WITHOUT COVER. WALL MOUNTED CARRIER: ASME A112.6.1; ADJUSTABLE CAST IRON FRAME, INTEGRAL DRAIN HUB AND VENT, ADJUSTABLE SPUD, LUGS FOR FLOOR AND WALL ATTACHMENT, THREADED FIXTURE STUDS WITH NUTS AND WASHERS, SUITABLE FOR SPACE PROVIDED. BELL AND SPIGOT TYPE USED ON VERTICAL UNITS AT SLAB-ON-GRADE LOCATIONS. VERTICAL UNITS AN ADJUSTABLE.
URINAL, U-1	KOHLER, BARDON	VITROUS CHINA, WALL HUNG WASHOUT URINAL WITH SHIELDS, INTEGRAL TRAP, 3/4 INCH TOP SPUD, ELONGATED RIM, REMOVABLE STAINLESS STEEL STRAINER, STEEL SUPPORTING HANGER. ADA APPROVED, MANUAL OPERATED FLUSH VALVE: ASME A112.8.1; EXPOSED CHROME PLATED, DIAPHRAGM TYPE; MAXIMUM I GALLON FLUSH VOLUME. SLOAN OPTIMA 186-1. WALL MOUNTED CARRIER: ASME A112.6.1; CAST IRON AND STEEL FRAME WITH TUBULAR LEGS, LUGS FOR FLOOR AND WALL ATTACHMENT, THREADED FIXTURE STUDS FOR FIXTURE HANGER, BEARING STUDS.
LAVATORY, L-1	KOHLER, GREENWICH	VITREOUS CHINA WALL HUNG BASIN: ASME A112.19.2; VITREOUS CHINA WALL HUNG LAVATORY 20 x 18 INCH MINIMUM, WITH 4 INCH HIGH BACK, DRILLINGS ON 4 INCH CENTERS, RECTANGULAR BASIN WITH SPLASH LIP, AND FRONT OVERFLOW. INSULATION SHIELDS ON PLUMBING PIPING FOR ADA COMPLIANCE. SUPPLY FITTING AND FAUCET: ASME A112.18.1; CHROME PLATED SUPPLY FITTING, CHROME PLATED SHORT GOOSENECK FAUCET AND WATER ECONOMY AFRATOR WITH MAXIMUM 2.0 GPM FLOW, 4 INCH INDEXED WRIST BLADE HANDLES. ADA COMPLIANT. ACCESSORIES: CHROME PLATED 17—GAGE BRASS P—TRAP WITH CLEAN—OUT PLUG AND ARM WITH ESCUTCHEON. OFFSET WASTE WITH PERFORATED OPEN GRID STRAINER. WHEEL HANDLE STOPS. RIGID SUPPLIES. WALL MOUNTED CARRIER: ASME A112.6.1; CAST IRON AND STEEL FRAME WITH TUBULAR LEGS, LUGS FOR FLOOR AND WALL ATTACHMENT, CONCEALED ARM SUPPORTS, BEARING PLATE AND STUDS.
SERVICE SINK, SS-1	FIAT	POLY STONE MATERIAL, 24"x24"x10" HIGH. STAINLESS STEEL DRAIN BODY, DOME STRAINER, AND LINT BASKET. WALL MOUNTED SERVICE FAUCET WITH VACUUM BREAKER, PAIL HOOK, ADJUSTABLE WALL BRACE, INTEGRAL STOPS, AND 3/4" HOSE THREAD ON OUTLET. PROVIDE OPTIONAL MOP BRACKET AND VINYL BUMPER GUARDS.
SINK, S-1	JUST, ELKAY	SINGLE COMPARTMENT, SELF-RIMMING, FULLY UNDERCOATED, REAR FAUCET LEDGE AND RIGHT BUBBLER LEDGE, PRE-PUNCHED 18 GAGE SS 25"x22"x6" DEEP. GOOSENECK FAUCET. FULLY ADA COMPATIBLE.
SINK, S-2	JUST, ELKAY	SINGLE COMPARTMENT, SELF-RIMMING, LEDGEBACK FULLY UNDERCOATED, PRE-PUNCHED 18 GAGE SS 16"x17"x6" DEEP. FULLY ADA COMPATIBLE. GOOSENECK FAUCET. ADA COMPATIBLE.
FLOOR DRAIN, FD	ZURN, Z-415	GALVANIZED CAST IRON TWO PIECE BODY WITH DOUBLE DRAINAGE FLANGE, WEEP HOLES, REVERSIBLE CLAMPING COLLAR, AND ROUND, ADJUSTABLE NICKEL-BRONZE 6 INCH DIAMETER STRAINER WITH SQUARE HOLES. WITH PRIMING LINE CONNECTION. FD 2" WASTE CONNECTION.

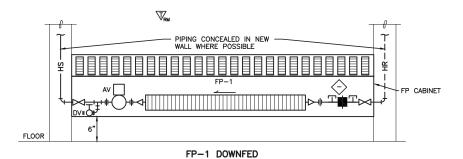

FINNED PIPE PIPING DIAGRAMS

NO SCALE

SYMBOLS

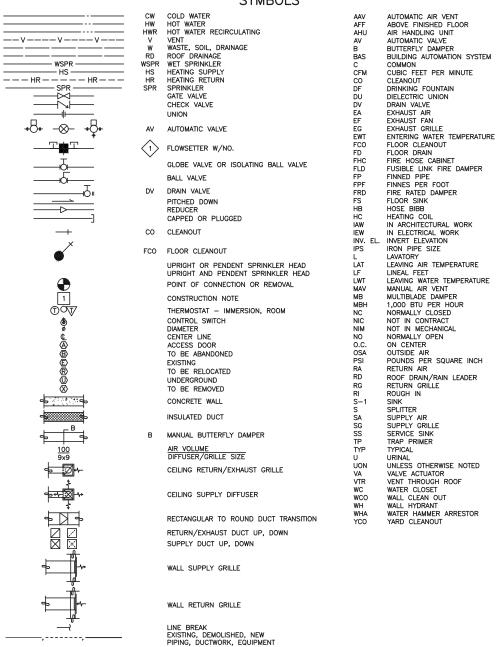

SHEET NOTES:

- 1. SEE SPECIFICATIONS FOR COMPLETE INFORMATION.
- 2. CODES & REGULATIONS: ALL WORK HEREUNDER SHALL BE STRICTLY IN CONFORMANCE WITH APPLICABLE CODES AND REGULATIONS. ALL WORK SHALL BE IN ACCORDANCE WITH THE 2006 INTERNATIONAL FIRE CODE, 2006 INTERNATIONAL MECHANICAL CODE, 2006 UNIFORM PLUMBING CODE, NFPA, AND CBJ. MODIFICATIONS INSOFAR AS MINIMUM REQUIREMENTS ARE CONCERNED, BUT THE DRAWINGS AND SPECIFICATIONS SHALL GOVERN IN CASE THE MINIMUM REQUIREMENTS ARE EXCEEDED. ALL ELECTRICAL EQUIPMENT SHALL BEAR THE UL LABEL.

MECHANICAL DRAWING INDEX

SHEET	TITLE
M001	SYMBOLS & SCHEDULES
M002	OVERALL FLOOR PLANS
M101	MAIN FLOOR PLAN - DEMO PIPING
M102	MAIN FLOOR PLAN - DEMO DUCTWORK
М103	TOILET ROOMS & GYM JAN. 106 PLAN - DEMO PIPING
M104	JAN 224, SECOND & MAIN FLOOR PLAN - DEMO DUCTWORK
M200	BASEMENT FLOOR PLAN
M201	MAIN FLOOR PLAN - PIPING
M202	MAIN FLOOR PLAN - DUCTWORK
M203	JAN 106, MAIN & SECOND FLOOR PLAN - PIPING
M204	JAN 224, SECOND & MAIN FLOOR PLAN - DUCTWORK
M205	MAIN FLOOR PLAN - GYM
M301	PLUMBING DIAGRAMS
M302	PLUMBING DIAGRAMS

Yorba Lott

522 West 10th Street uneau, Alaska 99801 phone 907-586-1070 fax 907-586-3959 iensenvorbalott.com

MURRAY & ASSOCIATES, P.C. ONSULTING ENGINEERS

Inc.

P O BOX 21081 JUNEAU, ALASKA 99802 TEL: 907 780-6151 FAX: 907 780-6182




VKE SCHOOL /ATION & BOROUGH ORIE DRAKE RENOVAT DRAE SNOV. Juneau, A MARII

REVISIONS Δ

Δ $\overline{\Delta}$


SHEET TITLE SCHEDULES, SYMBOLS, & DIAGRAMS

DATE: MARCH 2012 FILE: 11078

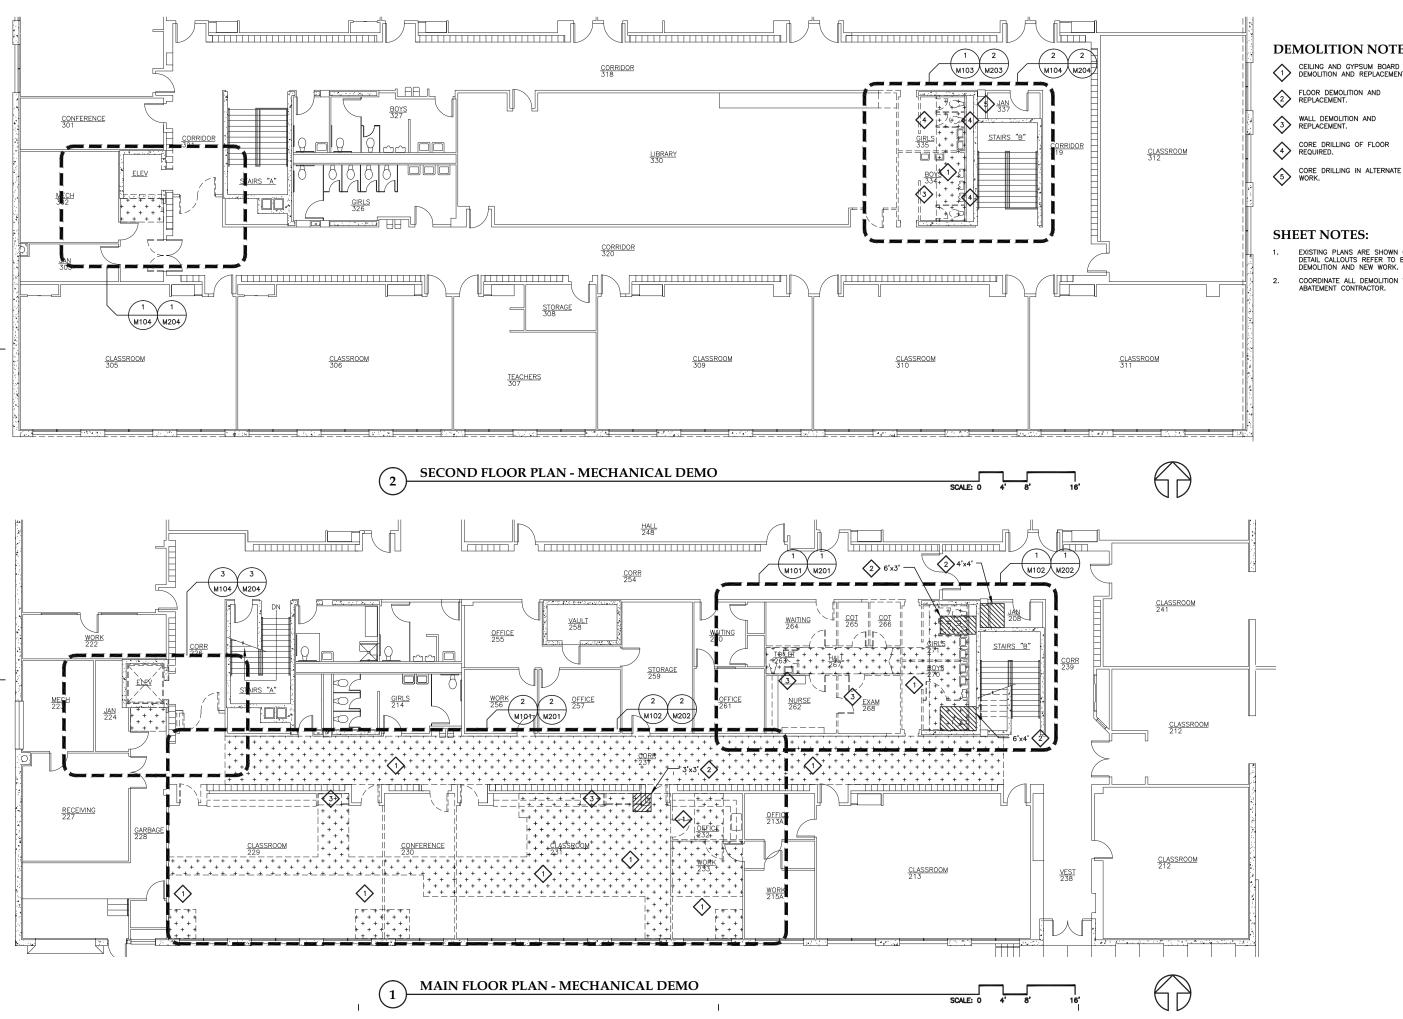



CEILING AND GYPSUM BOARD DEMOLITION AND REPLACEMENT.

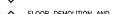

- EXISTING PLANS ARE SHOWN ONLY. DETAIL CALLOUTS REFER TO BOTH DEMOLITION AND NEW WORK.
- COORDINATE ALL DEMOLITION WITH ABATEMENT CONTRACTOR.



522 West 10th Street uneau, Alaska 99801 phone 907-586-1070 fax 907-586-3959 ensenyorbalott.com

MURRAY & ASSOCIATES, P.C.

P O BOX 21081 JUNEAU, ALASKA 99802 TEL: 907 780-6151 FAX: 907 780-6182



CITY & BOROUGH OF JUNEAU MARIE DRAKE SCHOOL RENOVATION Juneau, Alaska

 \triangle \triangle

SHEET TITLE OVERALL FLOOR

DATE: MARCH 2012 FILE: 11078

- 1. REMOVE ALL DOMESTIC WATER, WASTE AND VENT PIPING, DUCTWORK AND VENTILATION, AND PLUMBING FIXTURES IN PROJECT AREA. REMOVE BRANCH HEATING PIPING IN PROJECT AREA AS SHOWN.
- 2. REMOVE ALL SPRINKLER HEADS IN PROJECT AREA, ROOMS 229, 230, 231, 232, AND 233, ABOVE AND BELOW CEILING. NOTE CEILINGS ARE BEING REMOVED IN MUCH OF PROJECT AREA SO SPRINKLER PIPING WILL NEED TO BE TEMPORARILY SUPPORTED OR REMOVED AND REINSTALLED.
- DOMESTIC HOT WATER MAINS, HW & HWR, ARE EXPOSED BELOW CEILING. SPRINKLER PIPING MAINS ARE EXPOSED BELOW CEILING (NOT SHOWN). DOMESTIC COLD WATER MAINS, VENT PIPING AND HEATING PIPING ARE CONCEALED ABOVE CEILING.
- COORDINATE ALL DEMOLITION WITH ABATEMENT CONTRACTOR.

DEMOLITION NOTES:

REMOVE SINK, CW, HW, W, & V PIPING. CAP IN WALL AIRTIGHT, FLUSH.

REMOVE PIPING IN WALL ENTIRELY, CAP WASTE BELOW FLOOR, & VENT ABOVE CEILING.

REMOVE HEATING UNIT PNEUMATIC THERMOSTAT, AUTOMATIC VALVE & ACTUATOR, ALL TUBING, SUPPORTS. REMOVE TUBING BACK TO CONCEALED LOCATION, CAP AIRTIGHT, LABEL.

REMOVE CAS VALVES & PIPING IN WALL. CAP ABOVE CEILING, REMOVE ACCESS DOOR.

RETAIN BRANCH PIPING IN WALL, REMOVE HEATING UNIT AND PIPING UP TO WALL PENETRATION NEAR FLOOR LEVEL.

REMOVE BRANCH PIPING IN WALL TO ABOVE THE CEILING.

REMOVE 4"RD FROM 2ND FLOOR TO BELOW GRADE. PREPARE ENDS FOR RECONNECTION.

REMOVE AND PROTECT DDC THERMOSTAT FOR **⋄**

PROVIDE TEMPORARY SUPPORTS FOR SPRINKLER PIPING WHERE CEILINGS ARE REMOVED.



iensenvorbalott.com

MURRAY & ASSOCIATES, P.C. CONSULTING ENGINEERS

> P O BOX 21081 JUNEAU, ALASKA 99802 TEL: 907 780-6151 FAX: 907 780-6182




CITY & BOROUGH OF JUNEAU MARIE DRAKE SCHOOL RENOVATION Juneau, Alaska


 $\overline{\triangle}$

SHEET TITLE MAIN FLOOR PLAN -DEMO PIPING

DATE: MARCH 2012 FILE: 11078

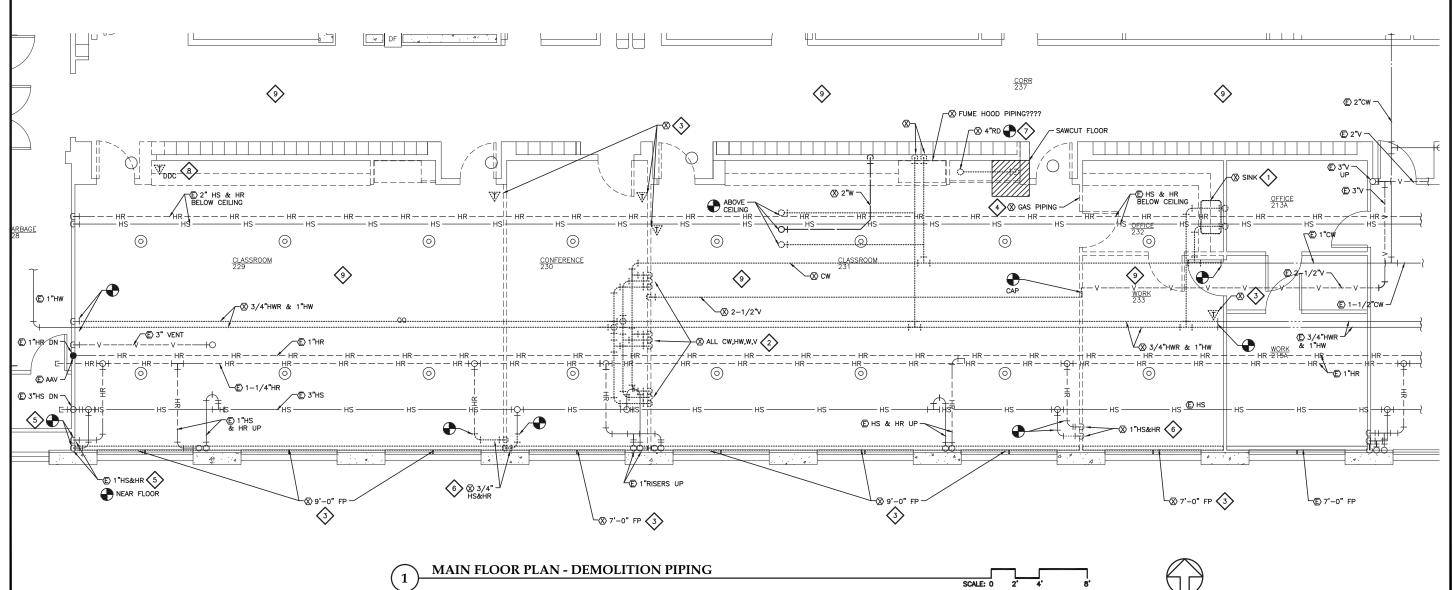

COORDINATE WITH ABATEMENT CONTRACTOR FOR DEMOLITION OF DUCTWORK AND DUCT TAPE.

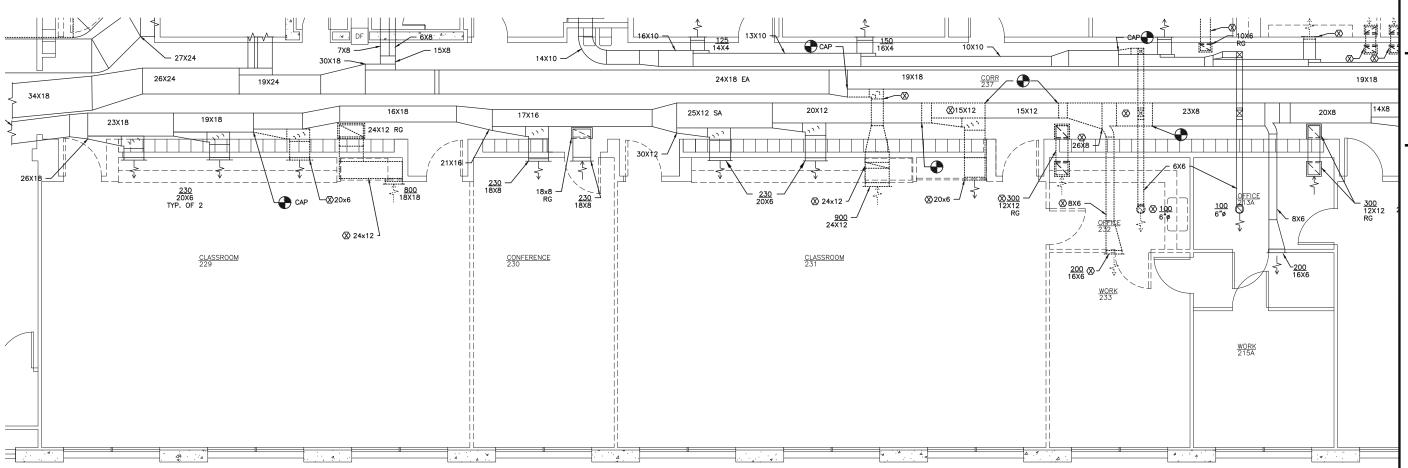

SCALE: 0 2' 4'

MAIN FLOOR PLAN - DEMOLITION DUCTWORK

Jensen Yorba Lott

> 522 West 10th Street Juneau, Alaska 99801 phone 907-586-1070 fax 907-586-3959 jensenyorbalott.com

Inc.

MURRAY & ASSOCIATES, P.C.

P O BOX 21081 JUNEAU, ALASKA 99802 TEL: 907 780-6151 FAX: 907 780-6182



CITY & BOROUGH OF JUNEAU
MARIE DRAKE SCHOOL
RENOVATION
Juneau, Alaska

REVISIONS


REVISIONS

...
...

SHEET TITLE

MAIN FLOOR PLAN
- DEMO
DUCTWORK


DATE: **MARCH 2012** FILE: **11078**

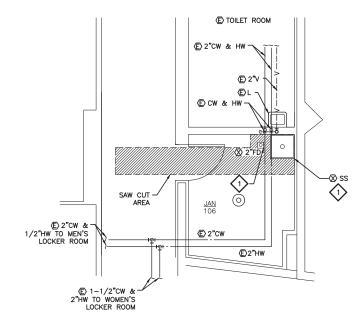

- REMOVE ALL DOMESTIC WATER, WASTE AND VENT PIPING, DUCTWORK AND VENTILATION, AND PLUMBING FIXTURES IN PROJECT AREA. REMOVE BRANCH HEATING PIPING IN PROJECT AREA AS SHOWN.
- REMOVE ALL SPRINKLER HEADS IN PROJECT AREA, ROOMS 106, 262, 263, 264, 265, 266, 267, 268, 270, 271, 335, 336, AND IN ALTERNATE WORK ROOMS 208 AND 337. ABOVE AND BELOW CEILING. APPROXIMATE LOCATION OF HEADS ARE SHOWN, SPR PIPING IS NOT SHOWN. NOTE CEILINGS ARE BEING REMOVED IN MUCH OF PROJECT AREA SO SPRINKLER PIPING WILL NEED TO BE TEMPORARILY SUPPORTED OR REMOVED AND REINSTALLED.
- 3. SPRINKLER PIPING MAINS ARE EXPOSED BELOW CEILING. DOMESTIC COLD AND HOT WATER MAINS, VENT PIPING AND HEATING PIPING ARE CONCEALED ABOVE CEILING.
- 4. COORDINATE ALL DEMOLITION WITH ABATEMENT CONTRACTOR.

DEMOLITION NOTES:

- REMOVE FIXTURES, REMOVE ALL CW, HW, VENT, AND WASTE PIPING TO ALL FIXTURES.
- REMOVE PIPING IN WALL ENTIRELY, CAP WASTE BELOW FLOOR, & VENT ABOVE CEILING. REMOVE ALL SUPPORTS, TRIM, AND DEBRIS FROM CHASE. TRIM ABANDONED ANCHORS AND LUGS FLUSH WITH SURFACE.
- REPLACE SS, FD, AND DF FIXTURES & PIPING IN ALTERNATE WORK. IN BASE BID WORK FIXTURES AND RELATED PIPING ARE TO REMAIN EXISTING
- REMOVE GAS VALVES & PIPING IN WALL. CAP ABOVE CEILING, REMOVE ACCESS DOOR.
- REMOVE 2"W DOWN TO 12" ABOVE FLOOR.
- REMOVE CW, HW, & V PIPING TO SERVICE SINK AND FD. CAP PIPING IN WALL SO EXISTING FIXTURES REMAIN FUNCTIONAL.
- REMOVE UP AND DOWN SPRINKLER BRANCH PIPING AND HEADS. REMOVE PIPING BACK TO EXPOSED BRANCH MAINS IN HALLWAYS. REMOVE SPRINKLER HEAD IN JANITOR ROOMS UNDER ALTERNATE WORK.

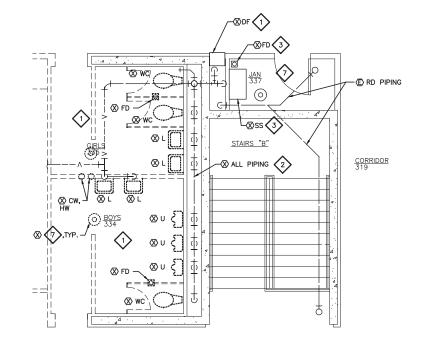











lensen

522 West 10th Street uneau, Alaska 99801

phone 907-586-1070

iensenvorbalott.com

ASSOCIATES, P.C.

CONSULTING ENGINEERS

fax 907-586-3959

MURRAY &


P O BOX 21081 JUNEAU, ALASKA 99802 TEL: 907 780-6151 FAX: 907 780-6182

Yorba

Lott


Inc.

CITY & BOROUGH OF JUNEAU
MARIE DRAKE SCHOOL
RENOVATION
Juneau, Alaska

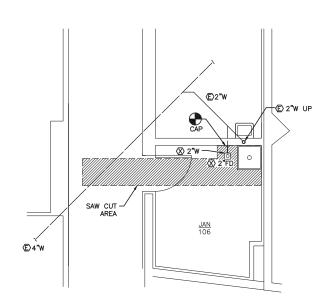





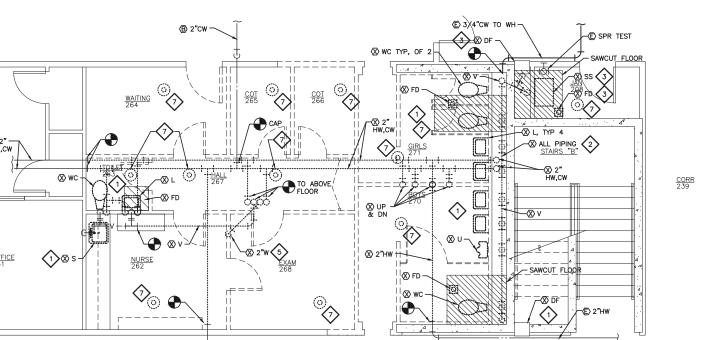


MAIN FLOOR TOILET ROOM PLAN - DEMO PIPING



SHEET TITLE TOILET ROOMS & GYM JAN. 106 PLAN - DEMO PIPING

DATE: MARCH 2012 FILE: 11078

 \triangle

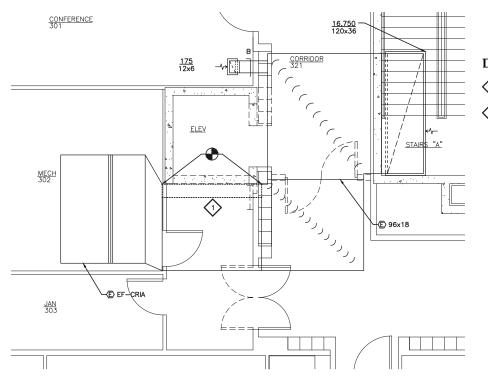



DEMOLITION NOTES:

- REMOVE 12" WIDE PORTION OF 96"x18"
- REMOVE DUCTWORK IN ALTERNATE.

SHEET NOTES:


- 1. REMOVE ALL DUCTWORK SHOWN UON.
- COORDINATE ALL DEMOLITION WITH ABATEMENT CONTRACTOR.

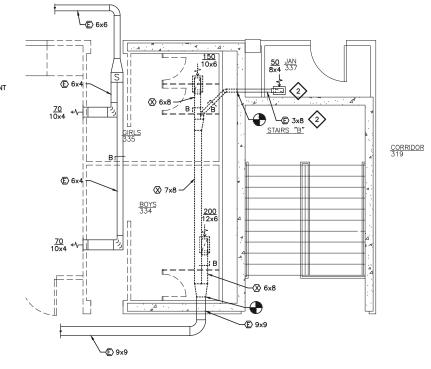


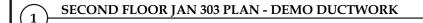




SECOND FLOOR TOILET PLAN - DEMO DUCTWORK

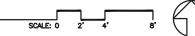

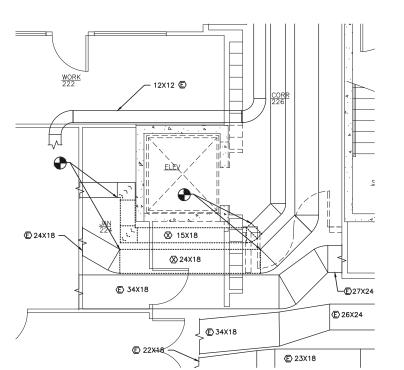


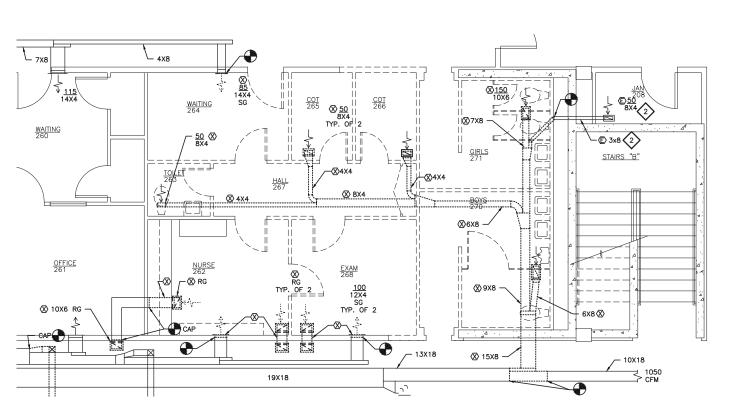

JAN 224 PLAN - DEMO DUCTWORK (3)



MAIN FLOOR TOILET PLAN - DEMO DUCTWORK

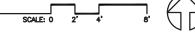



M104

Jensen Yorba Lott

> 522 West 10th Street luneau, Alaska 99801 phone 907-586-1070 fax 907-586-3959 jensenyorbalott.com

Inc.

MURRAY & ASSOCIATES, P.C. CONSULTING ENGINEERS

P O BOX 21081 JUNEAU, ALASKA 99802 TEL: 907 780-6151 FAX: 907 780-6182



CITY & BOROUGH OF JUNEAU MARIE DRAKE SCHOOL RENOVATION Juneau, Alaska

REVISIONS

...


SHEET TITLE

JAN 224 , SECOND & MAIN FLOOR PLAN - DEMO DUCTWORK

FILE: 11078

CONSTRUCTION NOTES:

- REMOVE SPRINKLER 1" BRANCH PIPE AND HEADS FROM ELEVATOR MACHINE ROOM AND LOBBY. SEAL PENETRATIONS WITH FIRE RATED MATERIAL. CONNECT TO EXISTING BRANCH PIPING AND ROUTE 1"WSPR TO HEAD ELEVATOR LOBBY. PENETRATE CONCRETE WALL IN TWO LOCATIONS.
- 2 IN ALTERNATE WORK.
- 3 CORE DRILL PENETRATIONS.
- 4 PLUG FD PIPING PERMANENTLY.
- CLEAN AND SNAKE PIPING. VERIFY WASTE PIPING IS OPERATIONAL. REPORT TO PROJECT MANAGER.

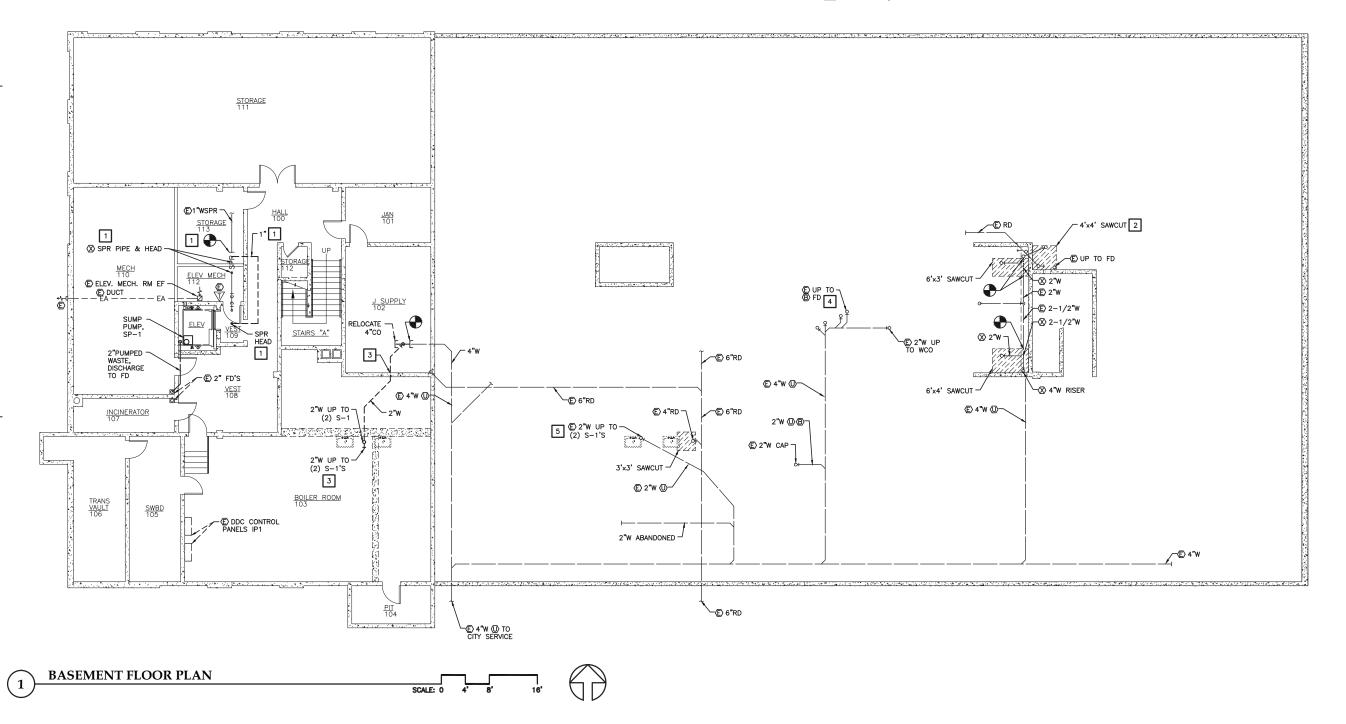



522 West 10th Street Juneau, Alaska 99801 phone 907-586-1070 fax 907-586-3959 jensenyorbalott.com

MURRAY & ASSOCIATES, P.C. CONSULTING ENGINEERS

P O BOX 21081 JUNEAU, ALASKA 99802 TEL: 907 780-6151 FAX: 907 780-6182



CITY & BOROUGH OF JUNEAU MARIE DRAKE SCHOOL RENOVATION Juneau, Alaska

REVISIONS

...
...

SHEET TITLE

BASEMENT FLOOR


DATE: **MARCH 2012** FILE: **11078**

- 1. REPLACE ALL UPRIGHT AND PENDENT SPRINKLER HEADS IN PROJECT AREA, ROOMS 229, 230, 231, 232, AND 233, ABOVE AND BELOW CEILING. NOTE CEILINGS ARE BEING REMOVED IN MUCH OF PROJECT AREA SO SPRINKLER PIPING WILL NEED TO BE TEMPORARILY SUPPORTED OR REMOVED AND REINSTALLED.
- 2. SPRINKLER PIPING MAINS ARE EXPOSED BELOW CEILING (NOT SHOWN), DOMESTIC COLD AND HOT WATER MAINS, VENT PIPING AND HEATING PIPING ARE CONCEALED ABOVE CEILING UON.

CONSTRUCTION NOTES:

- 1 CONNECT TO PIPING ABOVE FLOOR. VERIFY LOCATION.
- 2 CONNECT 2"W FROM SINK ON SECOND FLOOR TO S-1 SINK WASTE. ROUTE ALL THREE SINKS 2"W TO COMMON 2"W AND CONNECT TO EXISTING 2" THROUGH FLOOR. VERIFY LOCATION. VERIFY OPERATION OF EXISTING UNDERGROUND 2"W.
- 3 REPLACE PENDENT SPRINKLER HEADS IN ROOM.
- REPLACE PENDENT AND UPRIGHT SPRINKLER HEAD.
- 5 INSTALL INSULATED 4" ROOF DRAIN, CONNECT AT FLOOR AND CEILING LEVEL.
- ROUTE HEATING RETURN FP PIPE ABOVE FP CORE INSIDE ENCLOSURE.

- 7 ROUTE 2"W FROM BOTH SINKS TO COMMON 2"W DOWN INTO BOILER ROOM. CORE DRILL HOLE AS REQUIRED.
- 8 PROVIDE WCO BELOW SINK.
- 9 INSTALL 3/4" ISOLATING VALVES ON CW & HW PIPING BEHIND 16"x16" ACCESS DOOR, BOTTOM OF DOOR AT 8'-6"
- 10 COMMOM 3/4"CW AND HW FROM ISOLATION VALVES.
- LOCATE ISOLATION VALVES, AV, AND FLOWSETTER ACCESSIBLY BEHIND ACCESS DOOR.

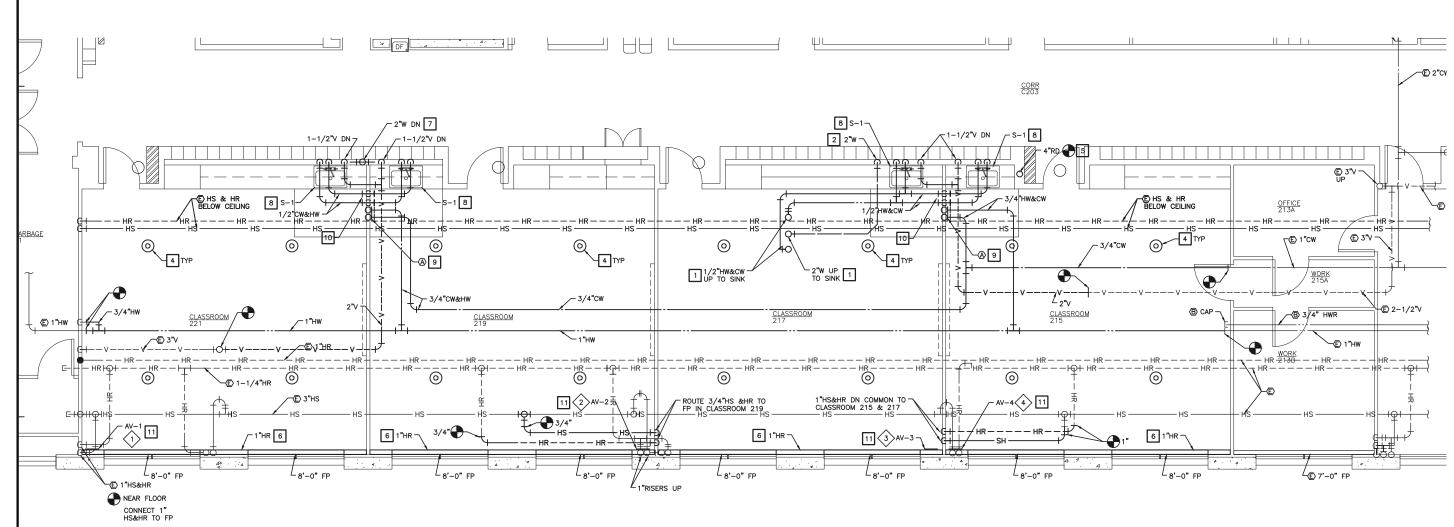

MAIN FLOOR PLAN - PIPING



Jensen Yorba Lott

> 522 West 10th Street Juneau, Alaska 99801 phone 907-586-1070 fax 907-586-3959 jensenyorbalott.com

Inc.

MURRAY & ASSOCIATES, P.C. CONSULTING ENGINEERS

P O BOX 21081 JUNEAU, ALASKA 99802 TEL: 907 780-6151 FAX: 907 780-6182



CITY & BOROUGH OF JUNEAU MARIE DRAKE SCHOOL RENOVATION Juneau, Alaska

REVISIONS

.
.

SHEET TITLE


MAIN FLOOR
PLAN - PIPING

DATE: **MARCH 2012** FILE: **11078**

TEST, ADJUST, AND MEASURES ALL GRILLES AND DIFFUSERS SHOWN.

CONSTRUCTION NOTES:

MANUAL DAMPER WITH RECESSED REMOTE OPERATOR IN CEILING.

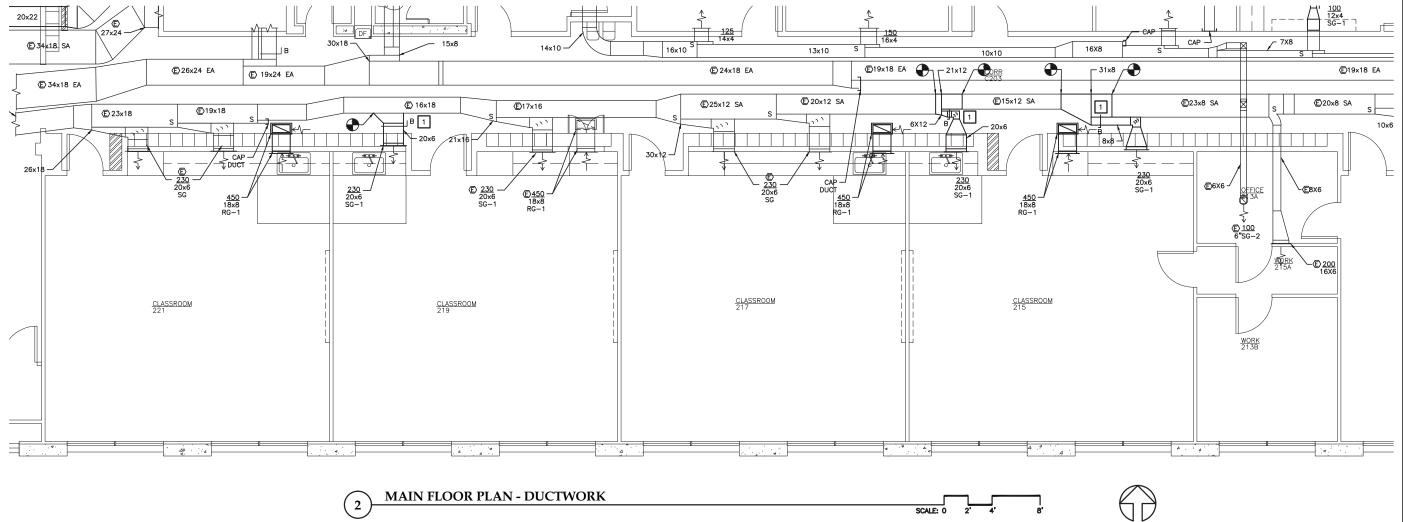

Jensen Yorba Lott Inc.

> 522 West 10th Street Juneau, Alaska 99801 phone 907-586-1070 fax 907-586-3959 jensenyorbalott.com

MURRAY & ASSOCIATES, P.C. ONSULTING ENGINEERS

P O BOX 21081 JUNEAU, ALASKA 99802 TEL: 907 780-6151 FAX: 907 780-6182




CITY & BOROUGH OF JUNEAU
MARIE DRAKE SCHOOL
RENOVATION
Juneau, Alaska

REVISIONS

...

SHEET TITLE MAIN FLOOR PLAN - DUCTWORK

DATE: MARCH 2012 FILE: 11078

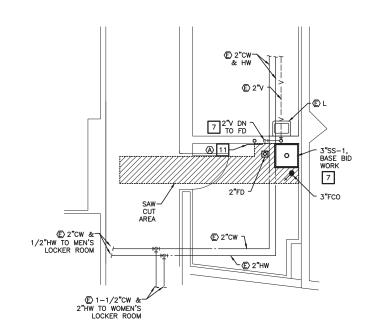

JAN 233 PLAN

(1A)

CONSTRUCTION NOTES:

- INSTALL WATER HAMMER ARRESTORS ACCESSIBILY BEHIND 16"x16" ACCESS DOOR, LOCATE AT APPROX. 4'-4" AFF.
- INSTALL TRAP PRIMERS ACCESSIBILTY BEHIND 16"x16" ACCESS DOOR, LOCATE AT APPROX. 4'-4" AFF.
- INSTALL CW & HW MAIN SHUTOFF VALVES BEHIND 16"x16" ACCESS DOOR, LOCATE 4'-4" AFF TO BOTTOM OF DOOR.
- INSTALL ISOLATION VALVE AND DV BEHIND ACCESS DOOR.
- 6 REINSTALL 4" WALL CLEANOUT IN NEW WALL IN ALTERNATE.
- CONNECT TO EXISTING CW, HW, & V PIPING IN WALL.
- B INSTALL BRANCH PIPING ABOVE CEILING, CONNECT TO MAINS IN HALLWAYS. INSTALL UPRIGHT AND RECESSED PENDENT HEADS. LOCATION OF HEADS IS SCHEMATIC, COORDINATE LOCATIONS WITH OTHER DISCIPLINES. REPLACE SPRINKLER HEADS IN JANITOR ROOMS IN ALTERNATE.
- 9 CONNECT TO EXISTING 2"W AND INSTALL 2"WCO.
- INSULATE PIPING IN ALTERNATE.
- INSTALL TRAP PRIMER ASSEMBLY BEHIND 16"x16" ACCESS DOOR, LOCATE AT APPROX. 18" AFF.

SHEET NOTE:


COORDINATE ACCESS DOOR LOCATIONS WITH ARCHITECTURAL LOCATION AND ELEVATIONS ON SHEET A503.










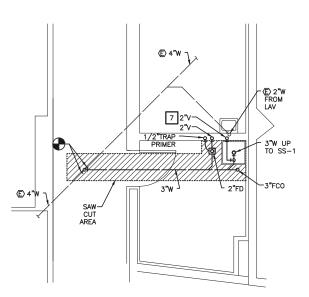




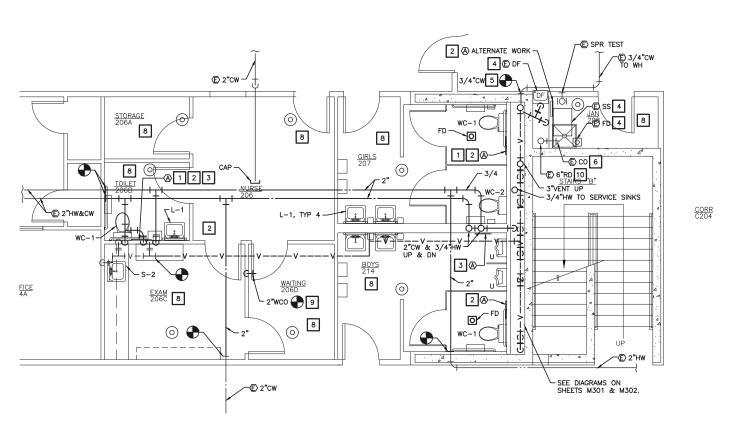


MAIN FLOOR PLAN - PIPING



DATE: MARCH 2012 FILE: 11078

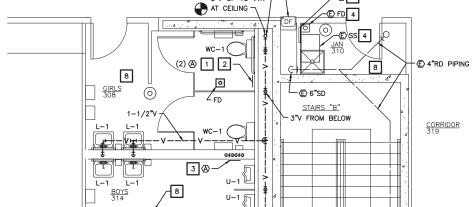

3"V UP TO VTR ¬

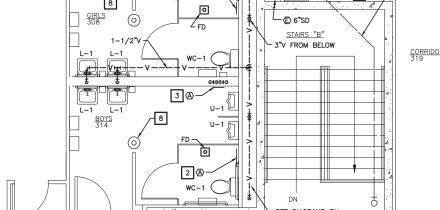



MURRAY & ASSOCIATES, P.C. CONSULTING ENGINEERS


P O BOX 21081 JUNEAU, ALASKA 99802 TEL: 907 780-6151 FAX: 907 780-6182



CITY & BOROUGH OF JUNEAU MARIE DRAKE SCHOOL RENOVATION Juneau, Alaska

 \triangle \triangle

JAN. 106, MAIN & SECOND FLOOR PLAN - PIPING

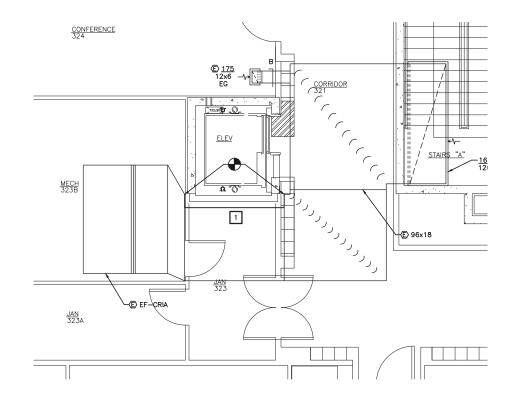



CONSTRUCTION NOTES:

- SEAL RETURN DUCT WITH 22 GAGE SHEET
 METAL AND BRACING. SEAL ALL JOINTS
 AIRTIGHT.
- REPLACE DUCT & GRILLE IN ALTERNATE WORK
- TEST AND MEASURE AIR VOLUME
- MANUAL DAMPER WITH RECESSED REMOTE

SHEET NOTES:


- TEST, ADJUST, AND MEASURES ALL GRILLES AND DIFFUSERS SHOWN.
- 2. PROVIDE ROUND TO RECTANGULAR TRANSITIONS AT GRILLES.

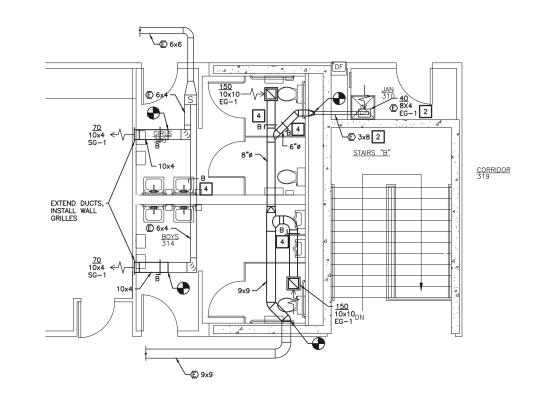

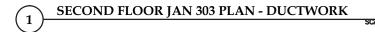





SECOND FLOOR TOILET PLAN - DUCTWORK

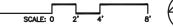



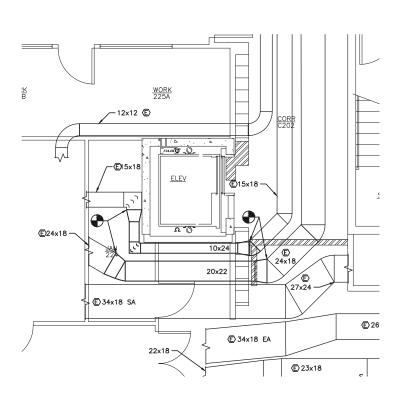

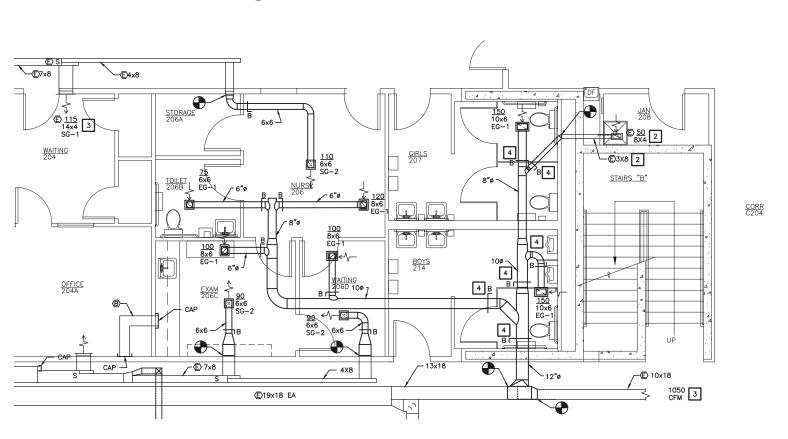

JAN 224 PLAN - DUCTWORK



MAIN FLOOR TOILET PLAN - DUCTWORK





REVISIONS

...

SHEET TITLE

M204

JAN 224, SECOND & MAIN FLOOR PLAN - DUCTWORK

Jensen Yorba Lott


> 522 West 10th Street Juneau, Alaska 99801 phone 907-586-1070 fax 907-586-3959 jensenyorbalott.com

> MURRAY & ASSOCIATES, P.C. CONSULTING ENGINEERS

P O BOX 21081 JUNEAU, ALASKA 99802 TEL: 907 780-6151 FAX: 907 780-6182



CITY & BOROUGH OF JUNEAU MARIE DRAKE SCHOOL RENOVATION Juneau, Alaska

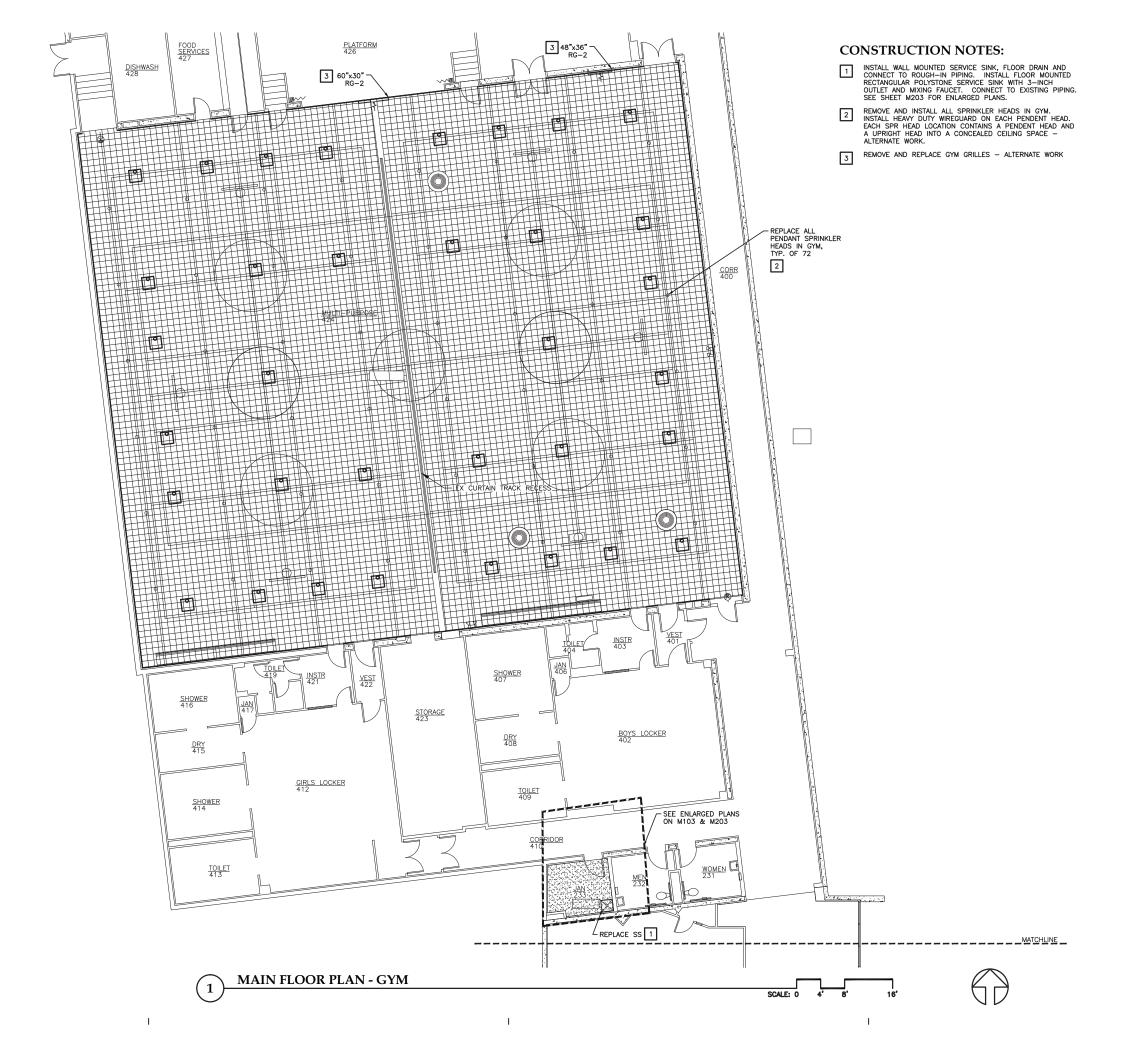



522 West 10th Street luneau, Alaska 99801 phone 907-586-1070 fax 907-586-3959 jensenyorbalott.com

MURRAY & ASSOCIATES, P.C. CONSULTING ENGINEERS

P O BOX 21081 JUNEAU, ALASKA 99802 TEL: 907 780-6151 FAX: 907 780-6182




CITY & BOROUGH OF JUNEAU MARIE DRAKE SCHOOL RENOVATION Juneau, Alaska

REVISIONS

...

SHEET TITLE MAIN FLOOR PLAN

DATE: MARCH 2012 FILE: 11078

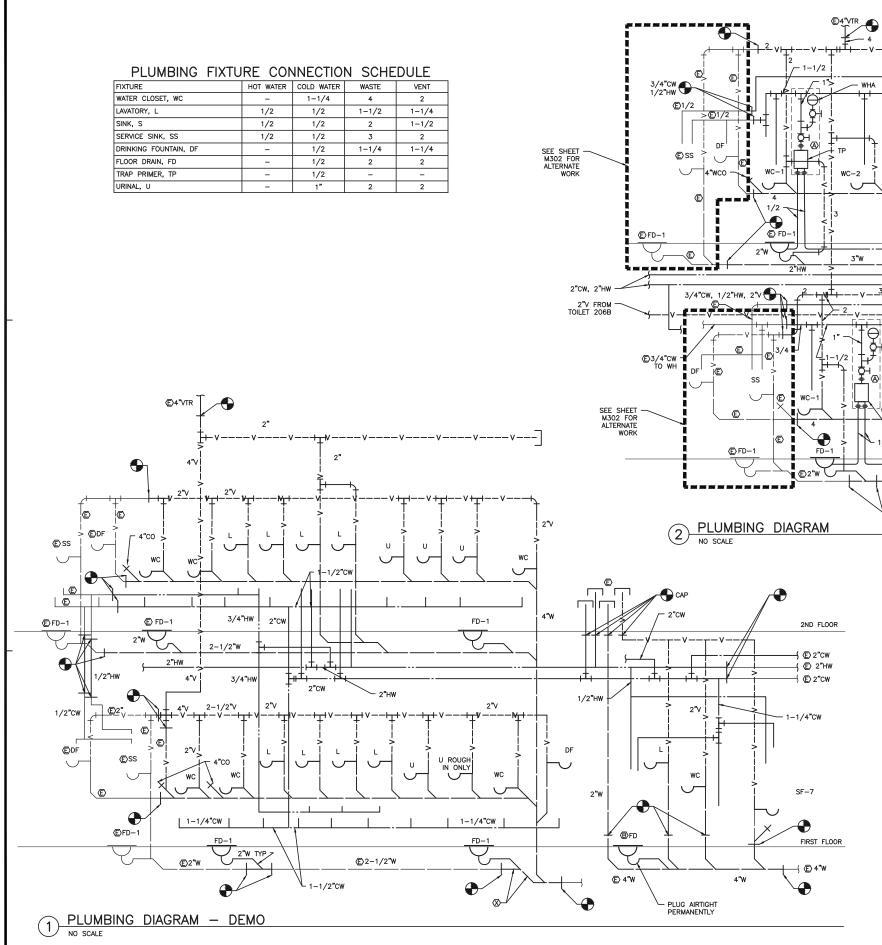



 $\frac{1-1/2}{-3/4}$

3/4

€2-1/2*W

FD-1

WC-1

WC-1

€2"HW

(E) 4"W

2ND FLOOR

FIRST FLOOR

1/2

522 West 10th Street uneau, Alaska 99801 phone 907-586-1070 fax 907-586-3959 jensenyorbalott.com

MURRAY & ASSOCIATES, P.C.

P O BOX 21081 JUNEAU, ALASKA 99802 TEL: 907 780-6151 FAX: 907 780-6182



CITY & BOROUGH OF JUNEAU MARIE DRAKE SCHOOL RENOVATION Juneau, Alaska

REVISIONS


.
.
.
.
.

SHEET TITLE
PLUMBING


DATE: MARCH 2012 FILE: 11078

M301

NOTE: REMOVE ALL PIPING UON.

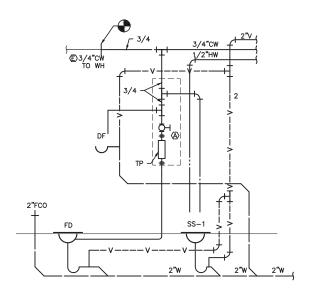


2 MAIN FLOOR - JAN 208 - ALTERNATE

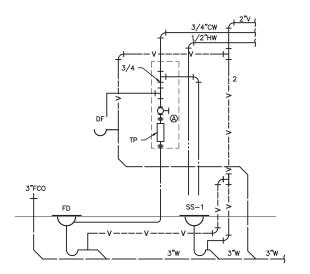

SECOND FLOOR - JAN 334

NO SCALE

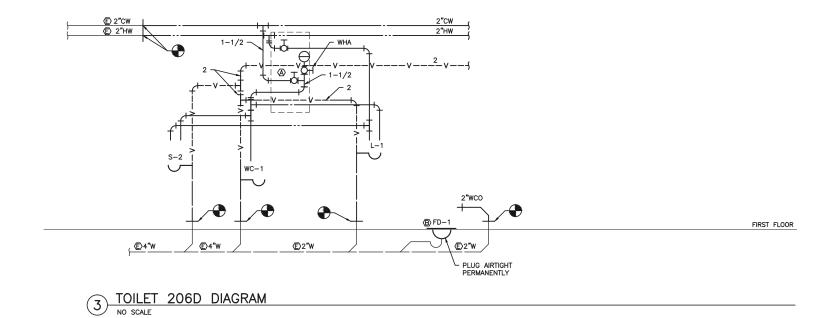

PLUMBING FIXTURE CONNECTION SCHEDULE

HOT WATER	COLD WATER	WASTE	VENT
	1-1/4	4	2
1/2	1/2	1-1/2	1-1/4
1/2	1/2	2	1-1/2
1/2	1/2	3	2
_	1/2	1-1/4	1-1/4
T -	1/2	2	2
_	1/2	-	-
_	1"	2	2
	- 1/2 1/2	- 1-1/4 1/2 1/2 1/2 1/2 1/2 1/2 1/2 1/2 - 1/2 - 1/2 - 1/2 - 1/2	- 1-1/4 4 1/2 1/2 1-1/2 1/2 1/2 2 1/2 1/2 3 - 1/2 1-1/4 - 1/2 2 - 1/2 - 1/2 -



522 West 10th Street Juneau, Alaska 99801 phone 907-586-1070 fax 907-586-3959 jensenyorbalott.com

MURRAY & ASSOCIATES, P.C. CONSULTING ENGINEERS

P O BOX 21081 JUNEAU, ALASKA 99802 TEL: 907 780-6151 FAX: 907 780-6182



CITY & BOROUGH OF JUNEAU MARIE DRAKE SCHOOL RENOVATION Juneau, Alaska

REVISIONS

.
.
.
.

SHEET TITLE PLUMBING DIAGRAMS

DATE: MARCH 2012 FILE: 11078