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Sheet Title:

Project Manager: N. Coffee Designed by: N. Coffee Drafted By: S. Stekoll





G00

Sheet number: 1 of 13

GLACIER VALLEY ELEMENTARY SCHOOL PLAYGROUND UPGRADES


HAIGHT & ASSOCIATES


ELECTRICAL ENGINEERS 526 MAIN STREET JUNEAU, ALASKA 99801 TELE: (907) 586-9788 FOR THE CITY & BOROUGH OF JUNEAU AND THE
JUNEAU SCHOOL DISTRICT
JUNEAU, AK


CITY & BOROUGH OF JUNEAU


ENGINEERING DEPT. 155 S SEWARD STREET JUNEAU, ALASKA 99801 TELE: (907) 586-0800


FAX: (907) 463-2606

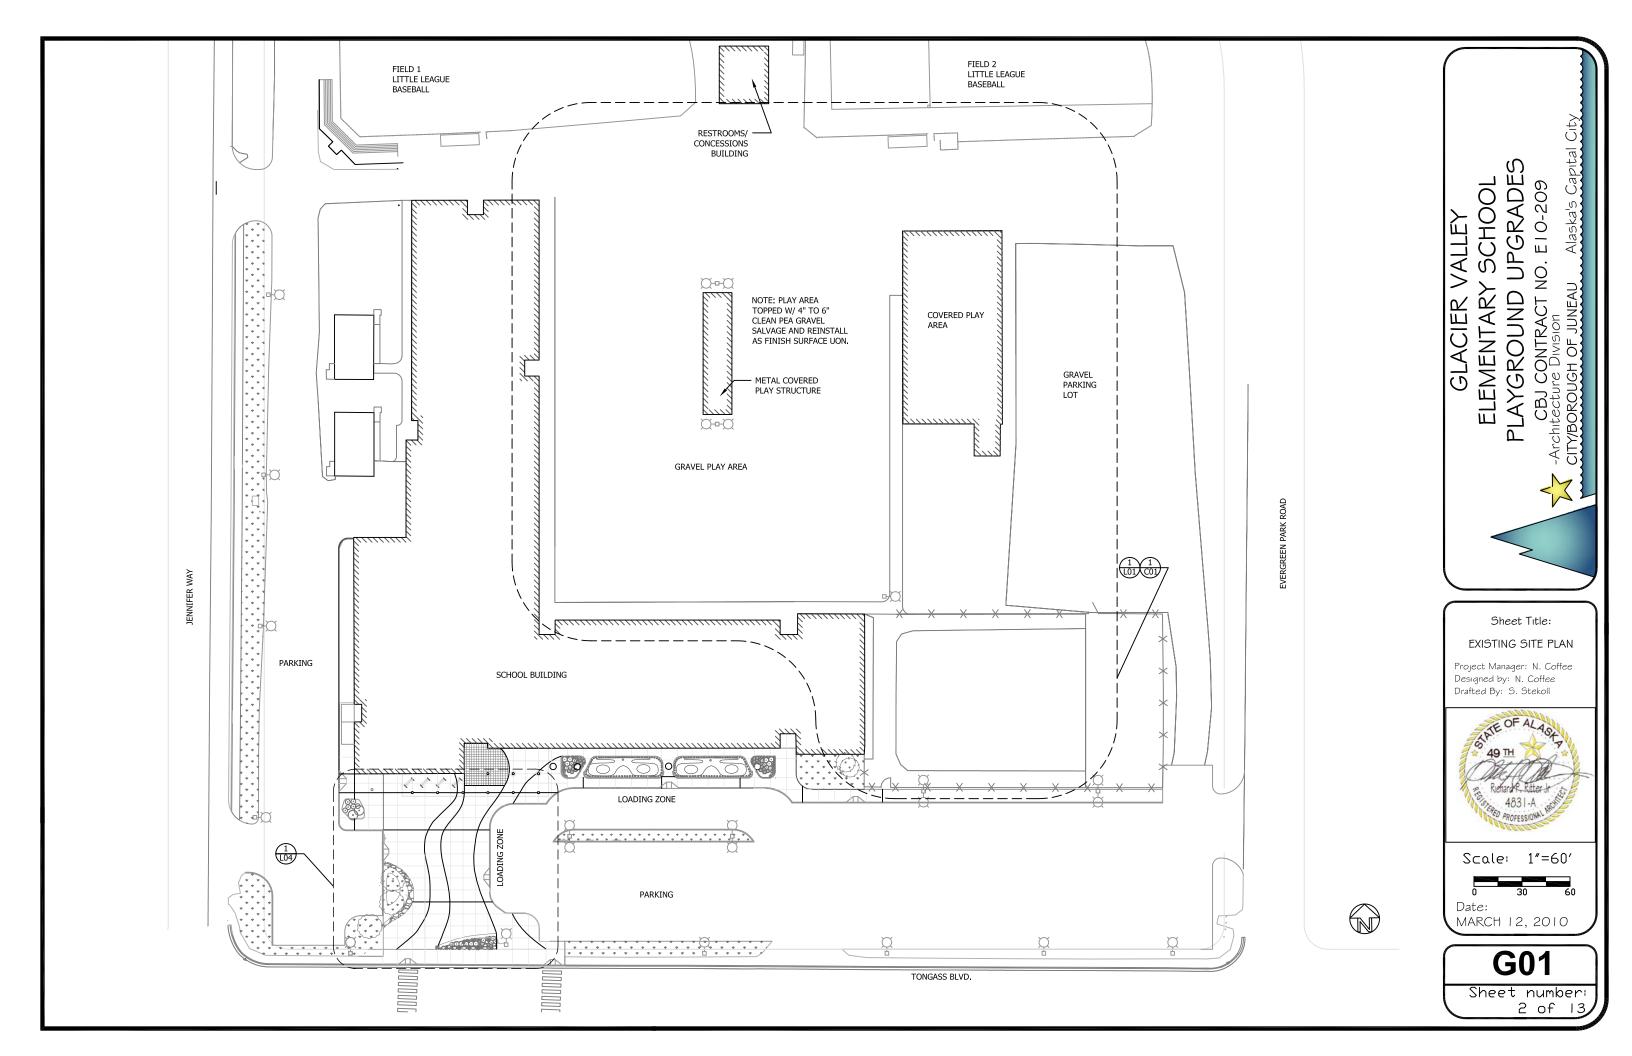


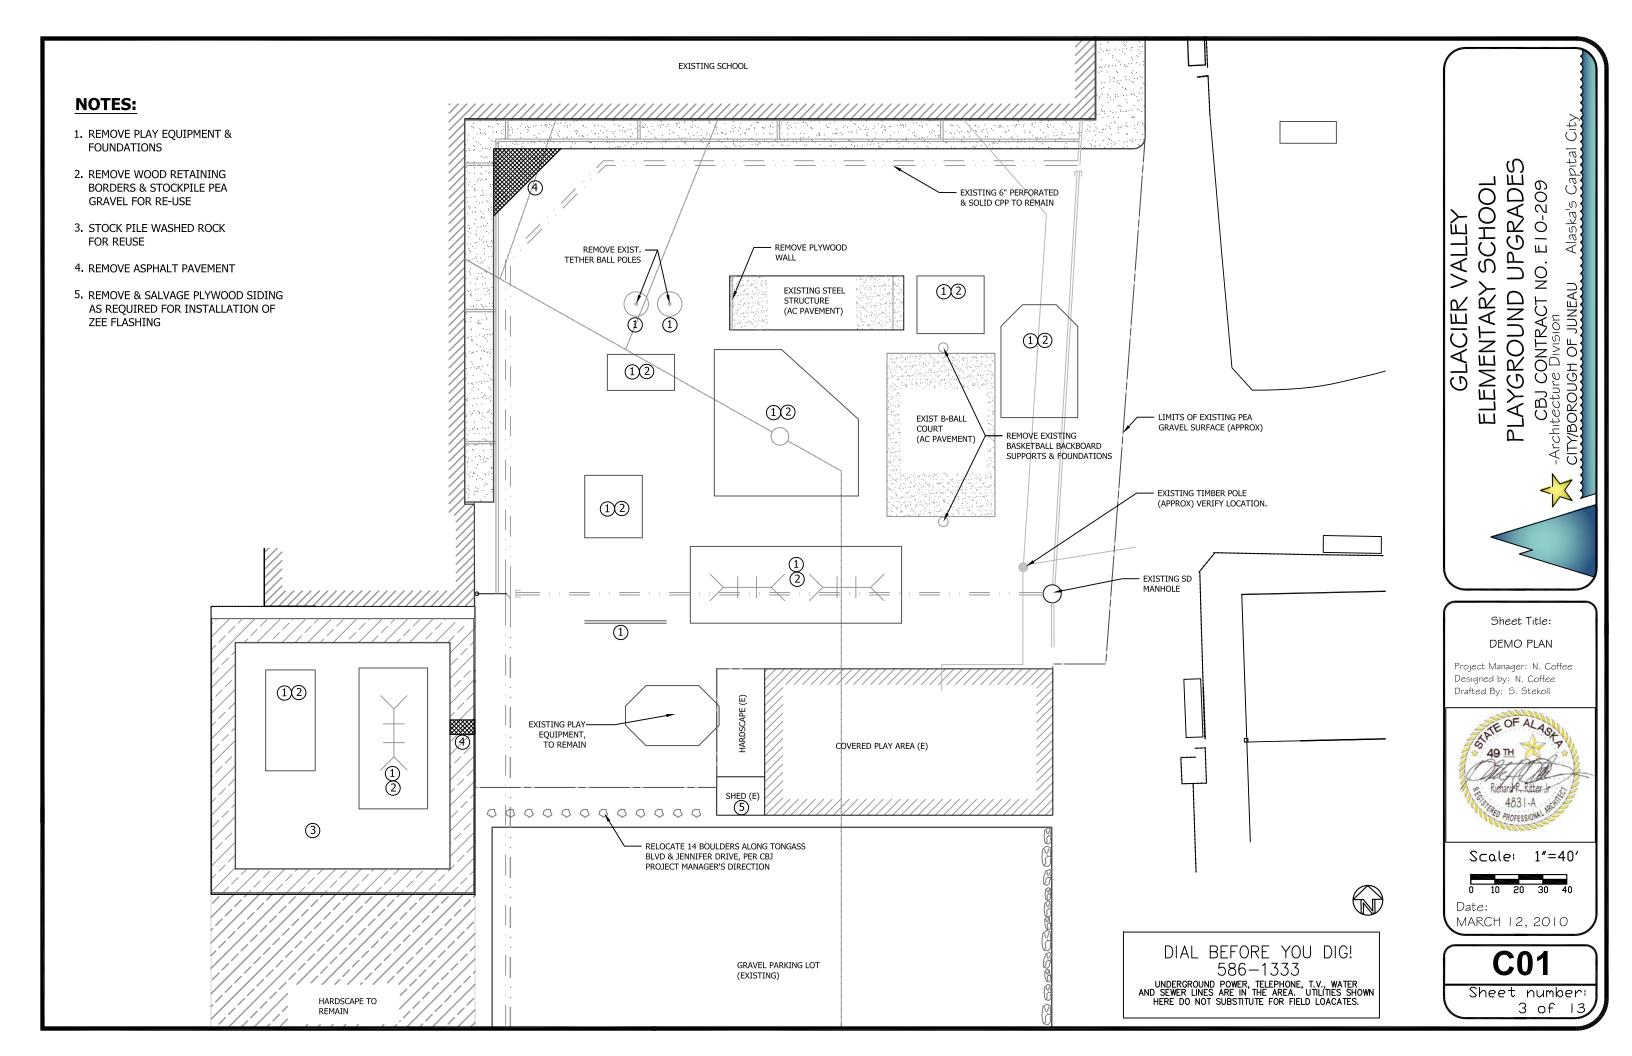

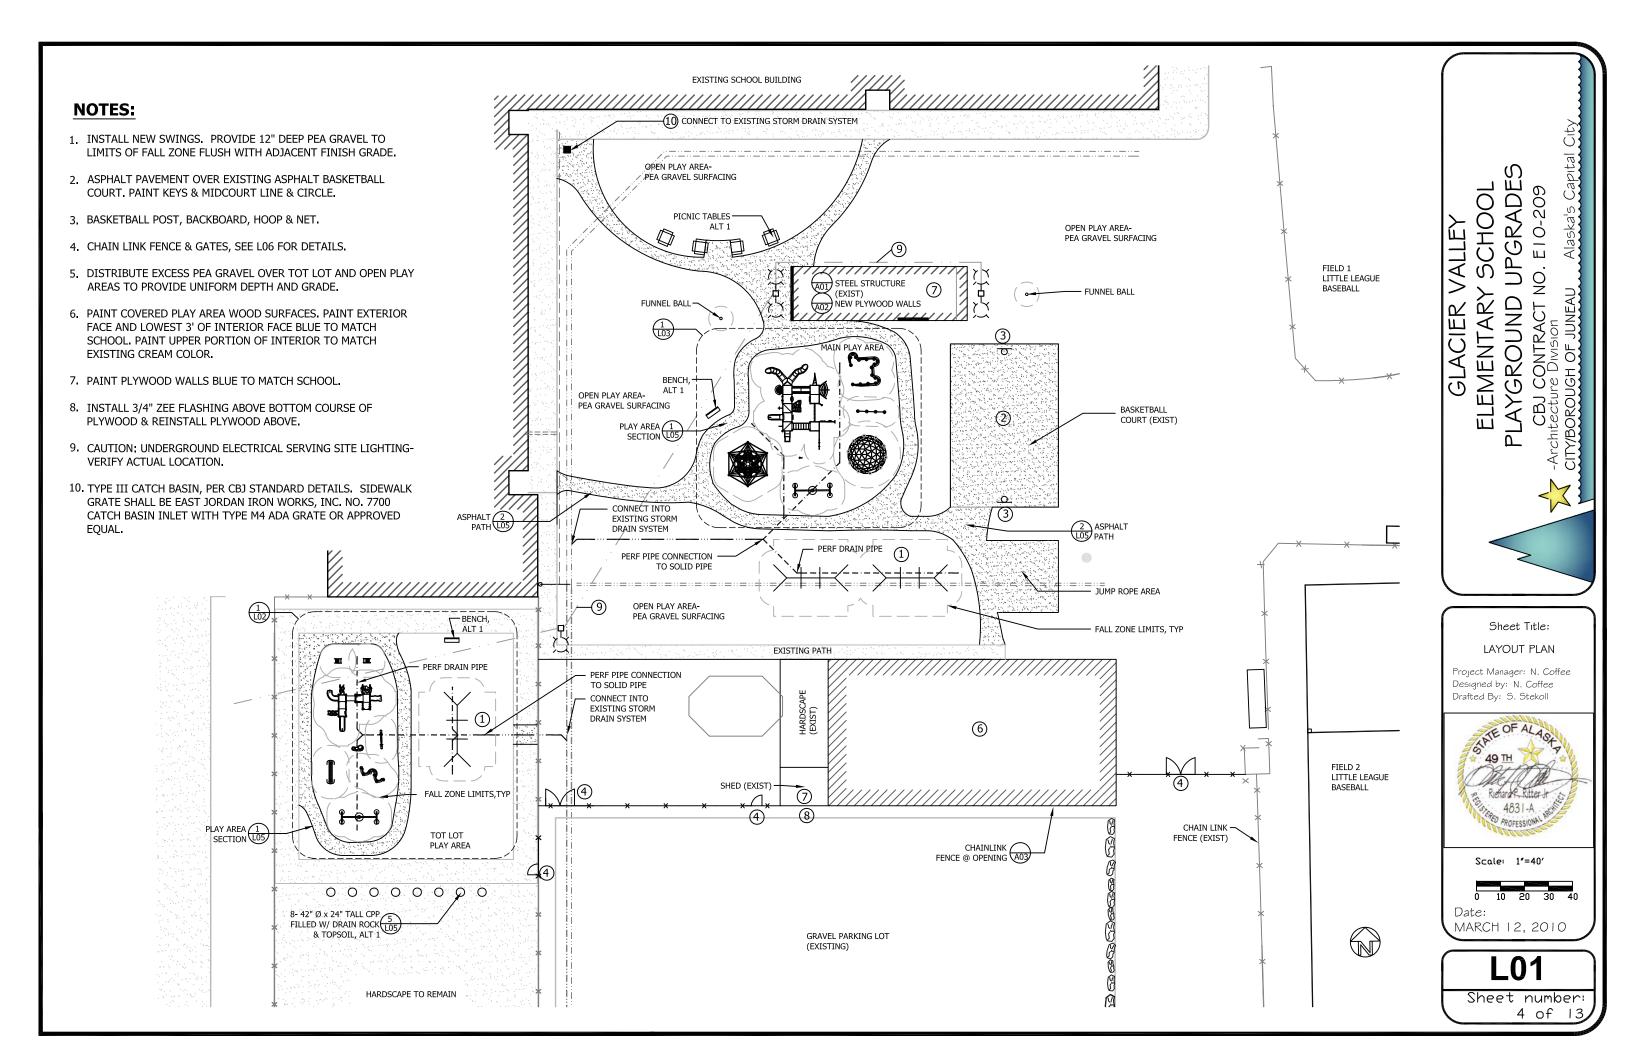

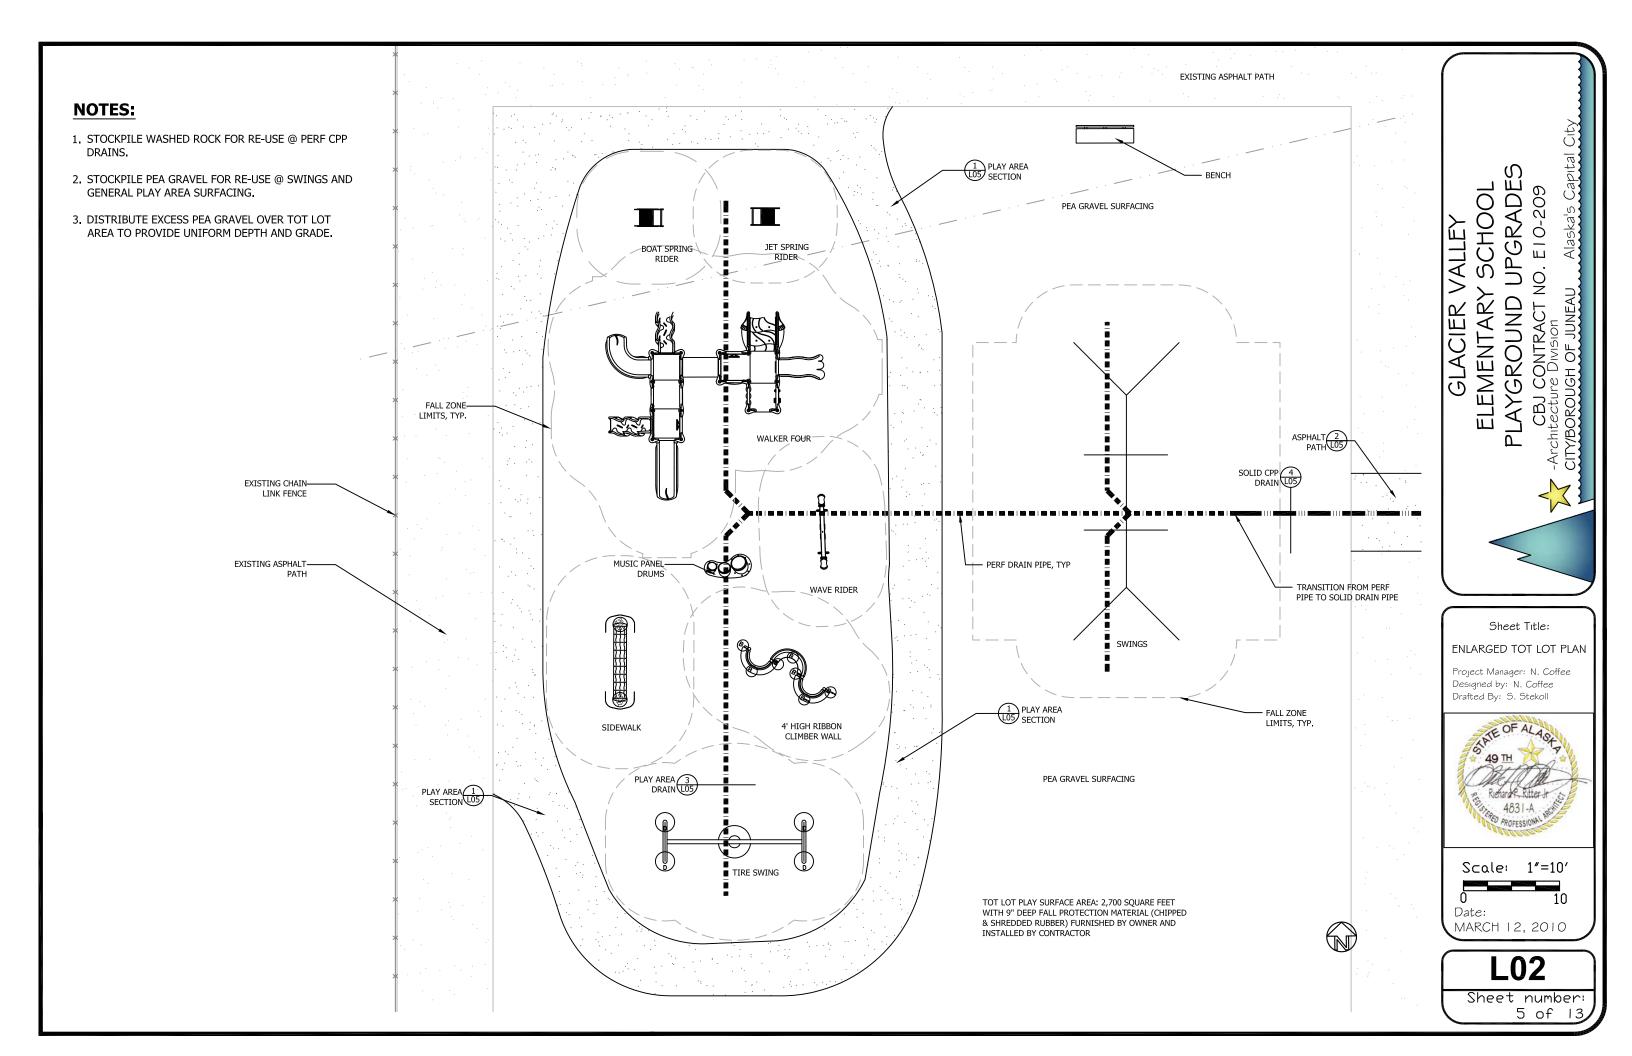

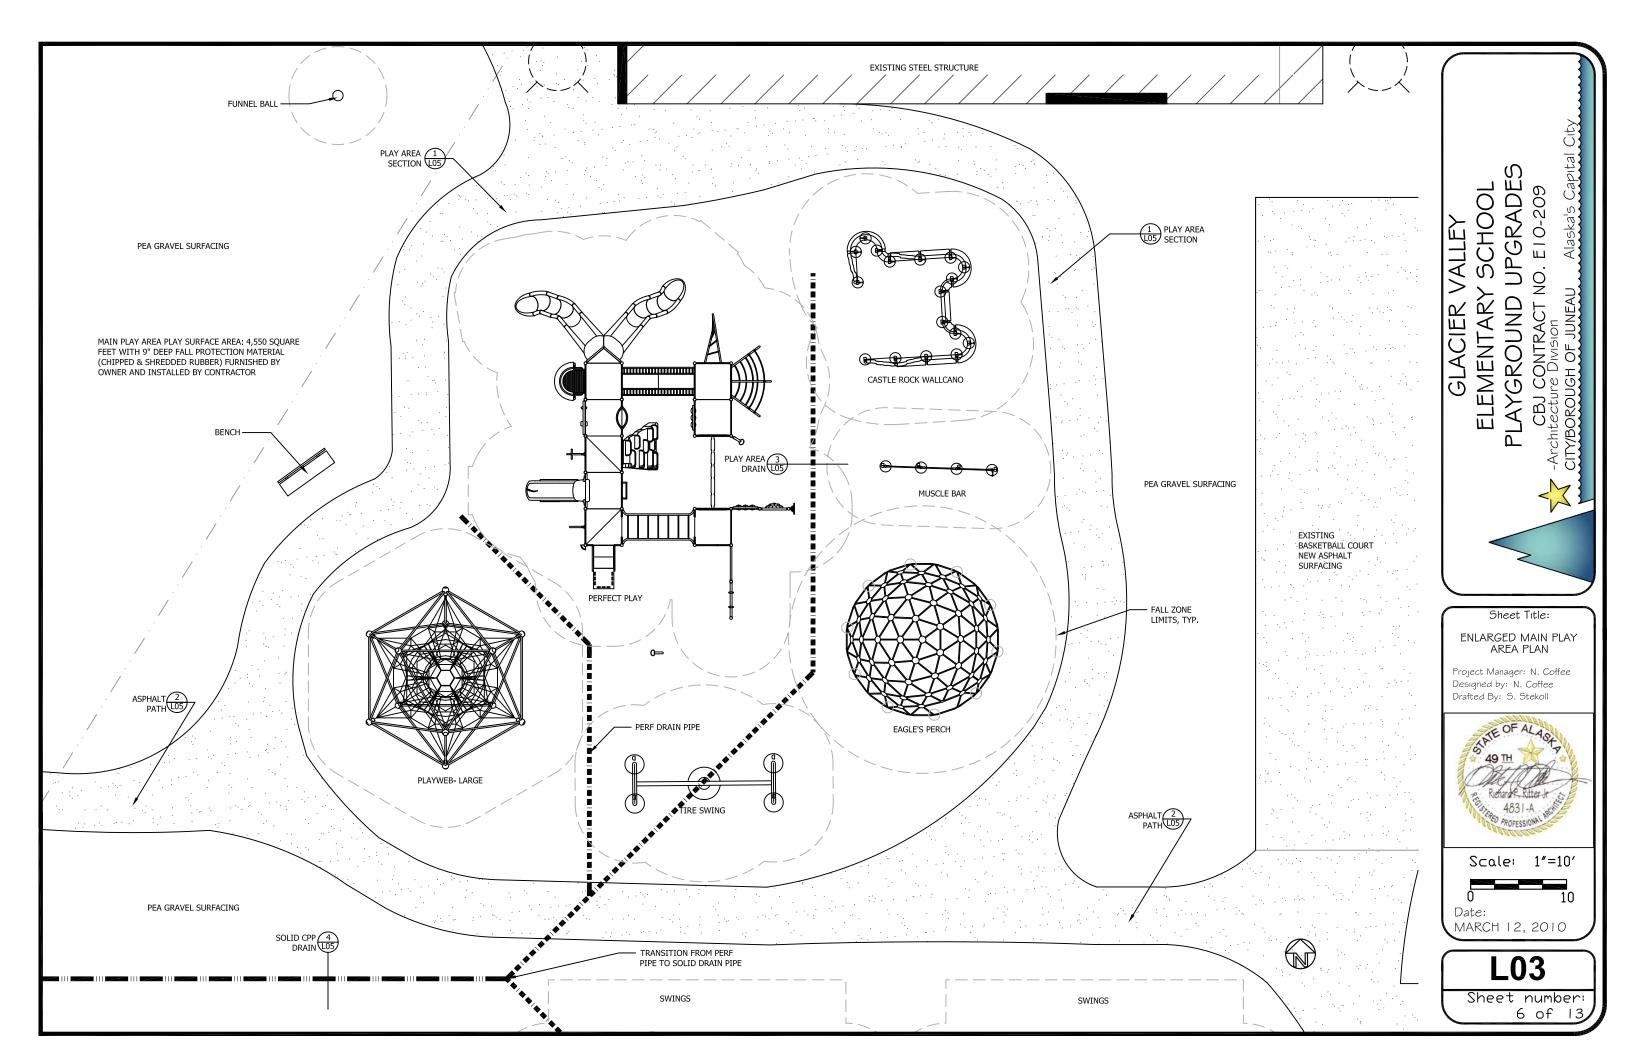

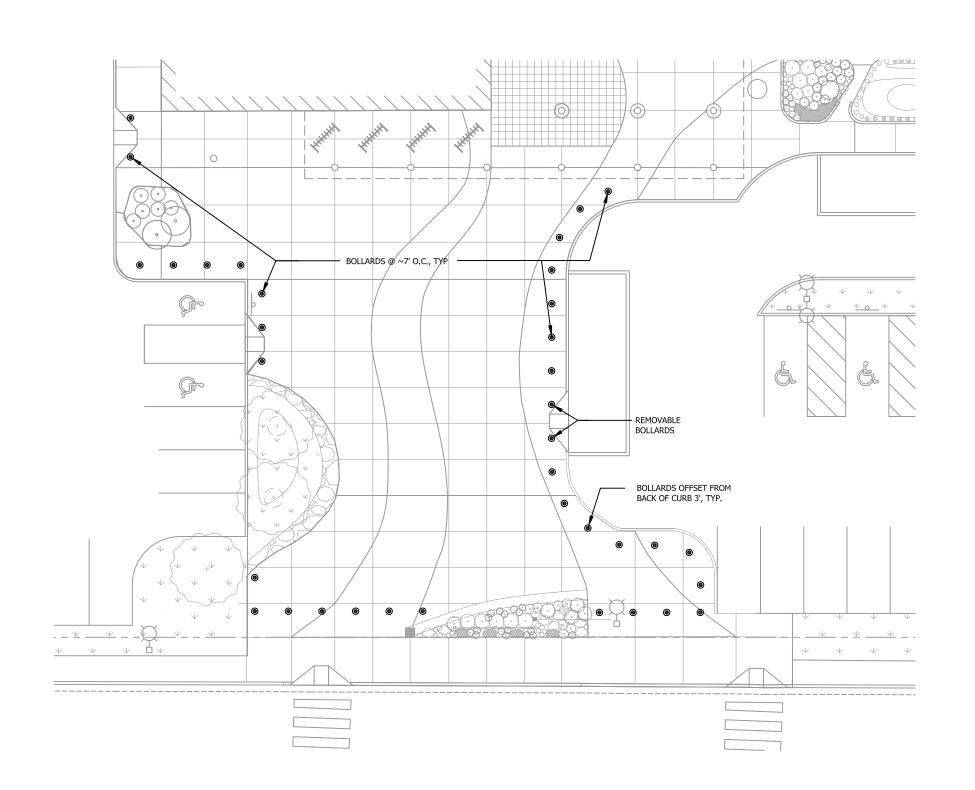

NOTE:

THE ALTERNATE INCLUDES BOLLARDS/ BOLLARD INSTALLATION ONLY. ALL ELSE SHOWN IS EXISTING.

> Scale: 1"=20' 10

Sheet Title:

ENLARGED ENTRY PLAZA PLAN

Project Manager: N. Coffee Designed by: N. Coffee Drafted By: S. Stekoll

PLAYGROUND UPGRADES

CONTRACT NO. E10-209

SCHOOL


ELEMENTARY

GLACIER VALLEY

Date: MARCH 12, 2010

L04 Sheet number: 7 of 13

BOLLARD LOCATIONS @ FRONT ENTRY AREA- ALTERNATE #2 SCALE: 1"=20'

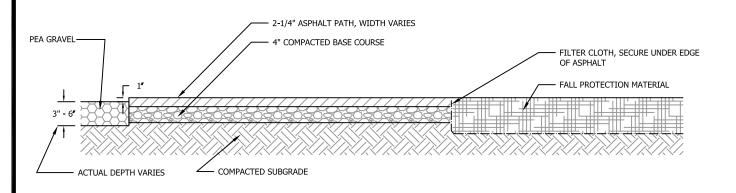

PEA GRAVEL

4" COMPACTED BASE COURSE

PEA GRAVEL


ACTUAL DEPTH VARIES

COMPACTED SUBGRADE

1 PLAY AREA SECTION SCALE: 1/2" =1' - 0"


2 ASPHALT PATH SECTION
SCALE: 1/2" =1' - 0"

NOTE:

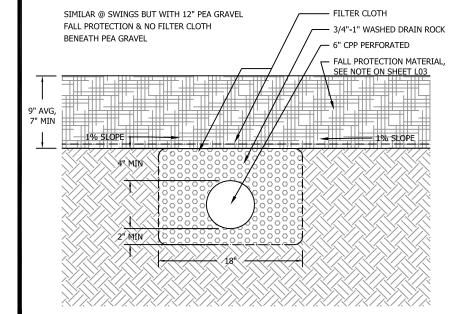


TRENCH DRAIN @ PLAY STRUCTURES

SCALE: 1" =1' - 0"

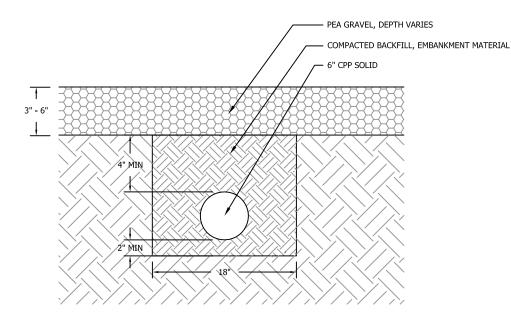

4 SOLID CPP DETAIL
SCALE: 1/2" =1' - 0"

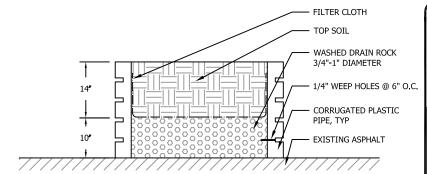

5 PLANTER SECTION
SCALE: 1/2" =1' - 0"

GLACIER VALLEY ELEMENTARY SCHOOL PLAYGROUND UPGRADES CBJ CONTRACT NO. E10-209 A -Architecture Division

Sheet Title:

PLAYGROUND DETAILS

Project Manager: N. Coffee Designed by: N. Coffee Drafted By: S. Stekoll




Scale: AS NOTED

Date:

MARCH 12, 2010

L05

Sheet number: 8 of 13

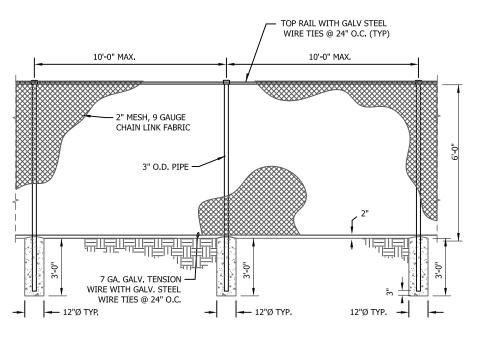

NOTES:


1. ALL FENCING MATERIAL SHALL BE GALVANIZED STEEL.

2. TOP OF CONCRETE FOOTING SHALL BE CROWNED TO SHED WATER.

TYPICAL LINE FENCE + POSTS SCALE: 1/8" = 1' - 0"


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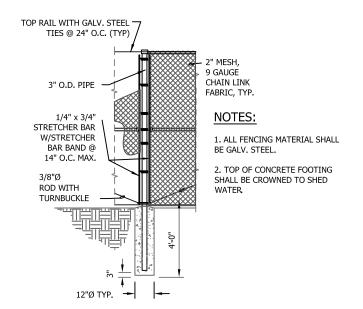
- 1. ALL FENCING MATERIAL INCLUDING GATE HARDWARE SHALL BE GALV.
- 2. LOCKABLE 1-3/8" CENTER DROP ROD, GUIDE, AND CENTERSTOP SHALL BE PROVIDED @ DOUBLE GATES. CENTERSTOP SHALL BE SET FLUSH WITH GRADE IN 8" Ø CONCRETE x 12" DEEP.
- 3. GATE SHALL BE PROVIDED WITH PROVISIONS FOR PADLOCKING.
- 4. CORNER FITTINGS FOR GATE FRAMES MAY BE USED IN LIEU OF WELDING.
- 5. GATE SHALL HAVE KNUCKLED SELVAGE TOP AND BOTTOM,
- 6, TOP OF CONCRETE FOOTING SHALL BE CROWNED TO SHED WATER,
- 7. VERTICAL BRACING SHALL BE 4' TO 6' APART.

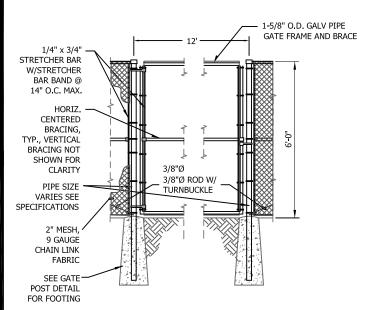


NOTES:

- 1. ALL FENCING MATERIAL INCLUDING GATE HARDWARE SHALL BE GALV.
- 2. GATE SHALL BE PROVIDED WITH PROVISIONS FOR PADLOCKING.
- 3. CORNER FITTINGS FOR GATE FRAMES MAY BE USED IN LIEU OF WELDING.
- 4. GATE SHALL HAVE KNUCKLED SELVAGE TOP AND BOTTOM.
- 5. TOP OF CONCRETE FOOTING SHALL BE CROWNED TO SHED WATER.
- 6. VERTICAL BRACING SHALL BE 4' TO 6' APART.



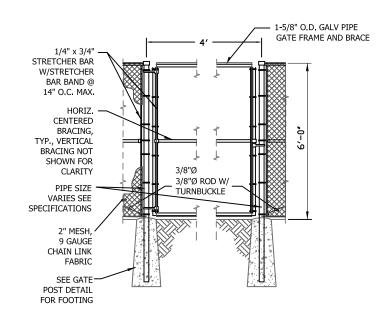

CORNER TO END POST SCALE: 1/8" =1' - 0"

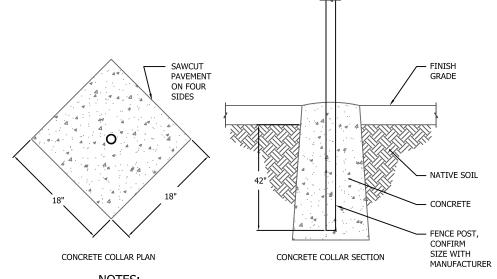

NOTES:

- 1, INSTALL CONCRETE COLLAR AROUND POSTS INSTALLED IN PAVED
- 2. AFTER ADJUSTING POST TO FINISH GRADE, BACKFILL WITH CONCRETE ONLY.
- 3, ASHFORD FORMULA OR APPROVED EQUAL SHALL BE APPLIED AS A CURING COMPOUND, APPLICATION SHALL CONFORM TO MANUFACTURER RECOMMENDATIONS.
- 4. UNLESS IMMEDIATELY BACKFILLED WITH CONCRETE, ALL SAWCUTS AND EXCAVATIONS SHALL BE PROTECTED WITH STEEL PLATES OR OTHER SUITABLE MATERIALS.
- 5. INCREASE BOTTOM SECTIONS 6" CREATING BELL SHAPE.

GATE POST DETAIL

SCALE: NTS

GRADE 209 SCHOOL E10-Š. EMENTARY ROUND CONTRACT GLACIER $\overline{\mathcal{G}}$



Drafted By: S. Stekoll



Scale: AS NOTED


Date: MARCH 12, 2010


_06

Sheet number: 9 of 13

DOUBLE SWING GATE- 12' SCALE: NTS


SINGLE SWING GATE SCALE: NTS

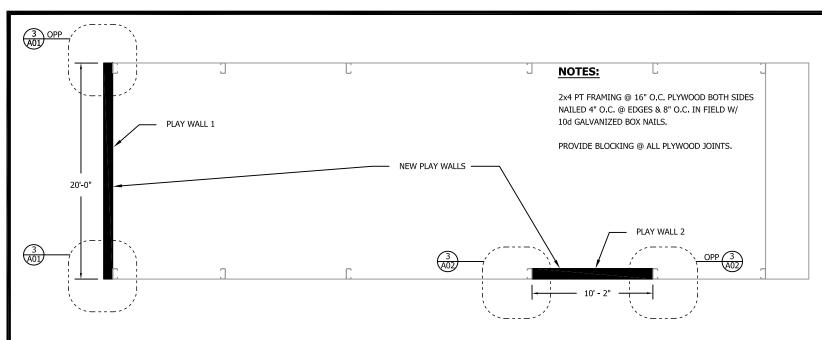

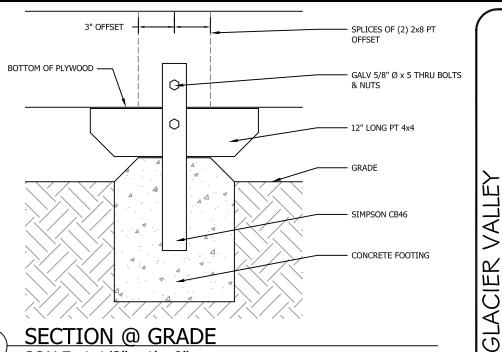


SECTION @ GRADE SCALE: 1-1/2" =1' - 0"

STEEL STRUCTURE PLAY WALL LOCATION PLAN
SCALE: 1" =10' - 0"

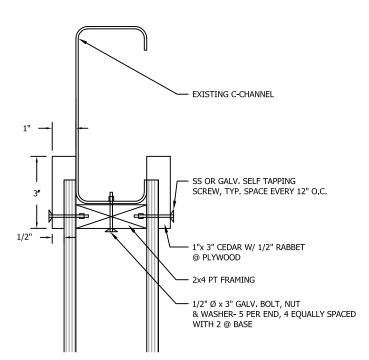

C-CHANNEL CONNECTION SCALE: NTS

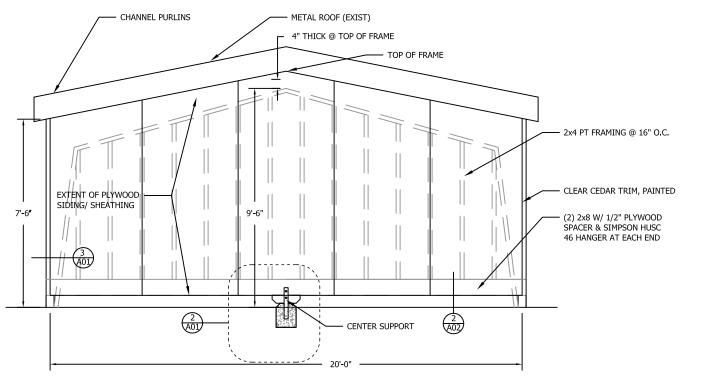

PLAY WALL 1 ELEVATION
SCALE: 1/4" =1' - 0"

Sheet Title: PLAY WALL ELEV

UPGRADE

PLAYGROUND

E10-209

CONTRACT NO.

SCHOOL

ELEMENTARY

VALLEY

DETAILS Project Manager: N. Coffee

Designed by: N. Coffee

Drafted By: S. Stekoll

4831-A

Scale: AS NOTED

Date: MARCH 12, 2010


A01


Sheet number: 10 of 13

NOTES:


2x4 PT FRAMING @ 16" O.C. PLYWOOD BOTH SIDES NAILED 4" O.C. @ EDGES & 8" O.C. IN FIELD W/ 10d GALVANIZED BOX NAILS.

PROVIDE BLOCKING AT ALL PLYWOOD JOINTS.

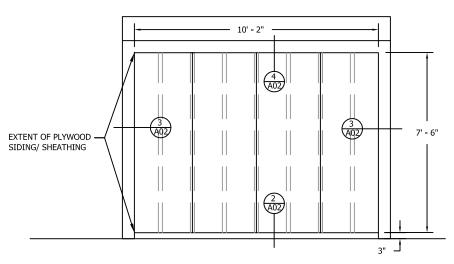

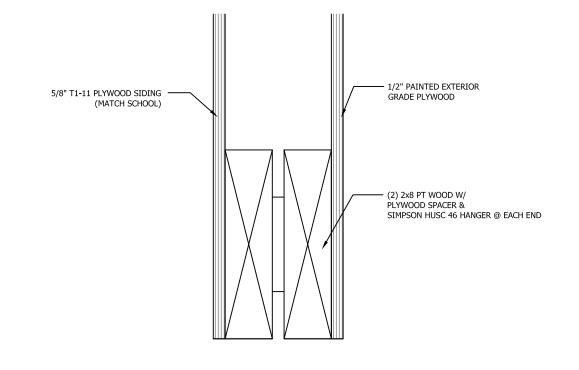


PLAY WALL 2 ELEVATION SCALE: 1/4"= 1' - 0"

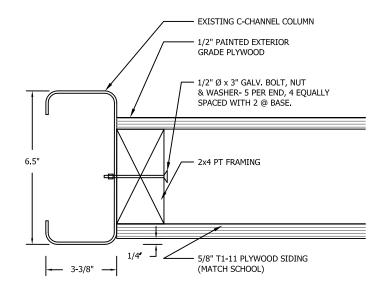

SECTION @ COLUMN SCALE: 3' = 1'-0"

SECTION @ BASE OF WALL
SCALE: 3"= 1' - 0"

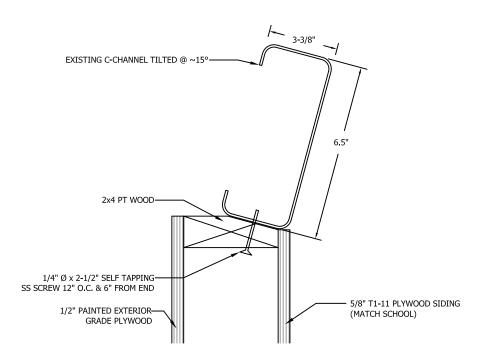


HEAD DETAIL SCALE: 3"= 1' - 0"



Sheet Title:

PLAY WALL DETAILS

Project Manager: N. Coffee Designed by: N. Coffee Drafted By: S. Stekoll

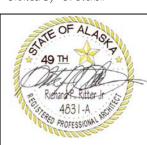


Scale: AS NOTED

Date: MARCH 12, 2010


A02

Sheet number: 11 of 13

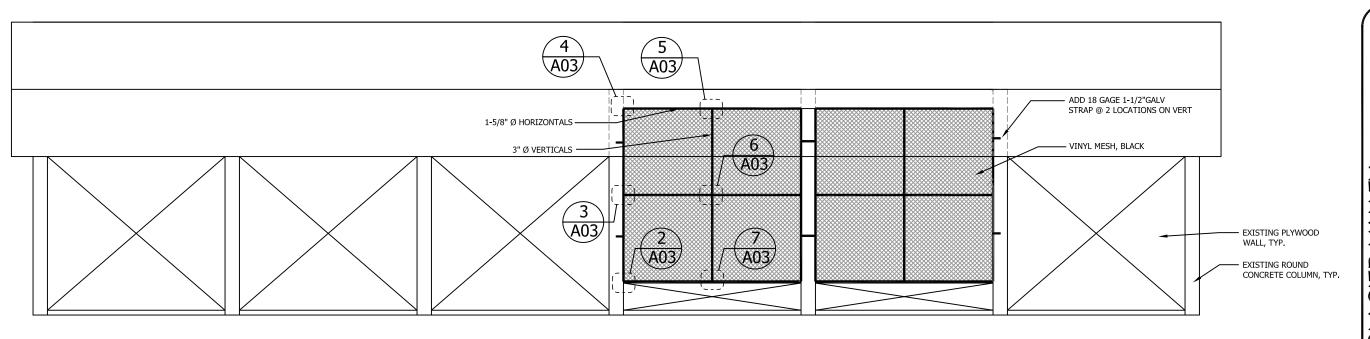


COVERED PLAY AREA FENCING ELEVATION


SCALE: 1"= 10'

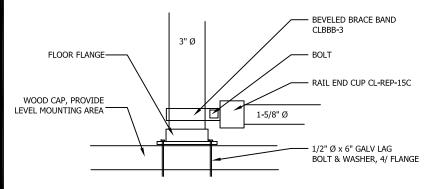


FENCE CONNECTION DETAIL SCALE: 1-1/2"= 1' - 0"

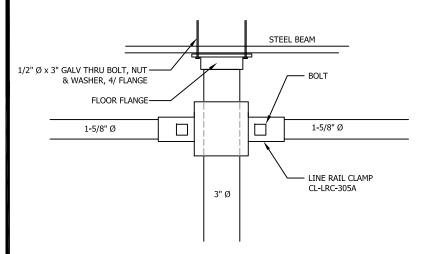


FENCE CONNECTION DETAIL SCALE: 1-1/2"= 1' - 0"

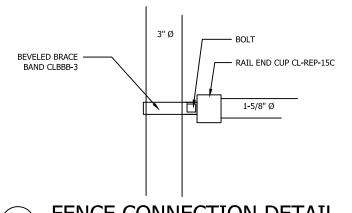


FENCE CONNECTION DETAIL
SCALE: 1-1/2"= 1' - 0"

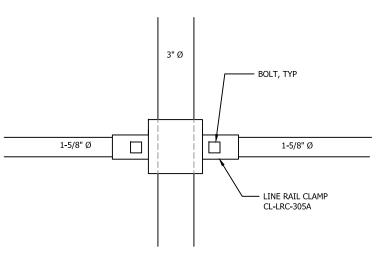

FENCE CONNECTION DETAIL
SCALE: 1-1/2"= 1' - 0"

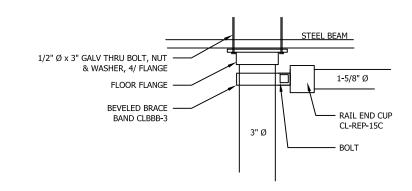

FENCE CONNECTION DETAIL SCALE: 1-1/2"= 1' - 0"

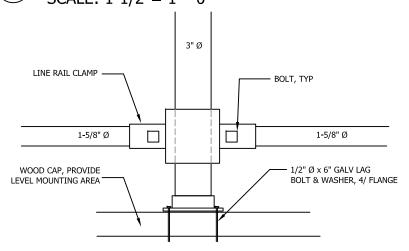

FENCE CONNECTION DETAIL SCALE: 1-1/2"= 1' - 0"



Designed by: N. Coffee Drafted By: S. Stekoll




Scale: AS NOTED

Date: MARCH 12, 2010

A03


Sheet number: 12 of 13

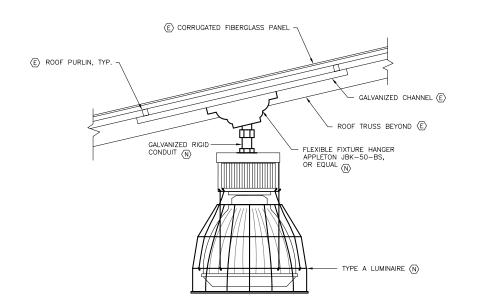


NOTES:

- 1. REPLACE ALL TYPE A LUMINAIRES AS SCHEDULED. PROVIDE NEW MOUNTING HARDWARE AS ILLUSTRATED IN DETAIL 2.
- 2. REPLACE TYPE B LUMINAIRES ON NORTH SIDE OF STRUCTURE AS SCHEDULED. MOUNT TO EXISTING CROSS ARM SUPPORT. PROVIDE MOUNTING HARDWARE AS REQUIRED.
- 3. RACEWAYS AND WIRING ARE EXISTING, UON.
- 4 EXISTING LUMINAIRE REMOVED BY OWNER. PROVIDE NEW LUMINAIRE AS SCHEDULED.
- $\langle 5 \rangle$ RE-WIRE TO SWITCH GROUP g.

LUMINAIRE SCHEDULE				
TYPE	DESCRIPTION	MANUFACTURER	LAMPS	REMARKS
Α	22" DIA PENDANT MOUNT HID HIGH BAY INDUSTRIAL, WITH PRISMATIC ACRYLIC REFRACTOR, FULL WIREGUARD, 1 LAMP.	WIDE-LITE ILXP-400-C22E-120-FWG	(1) 400W MH 3600K, CRI 70 VENTURE PULSE—START	PENDANT LIGHT MOUNTING HEIGHT 24'
В	FLOOD LIGHT WITH DIE CAST ALUMINUM HOUSING, TEMPERED GLASS LENS, TOP VISOR, ANODIZED ALUMINUM ALLOY REFLECTOR, WIDE DISTRIBUTION	HOLOPHANE PF-40LPM-VT-K-W-1-B- C-08657	(1) 400W MH PULSE-START	FLOOD LIGHT MOUNTING HEIGHT 22'

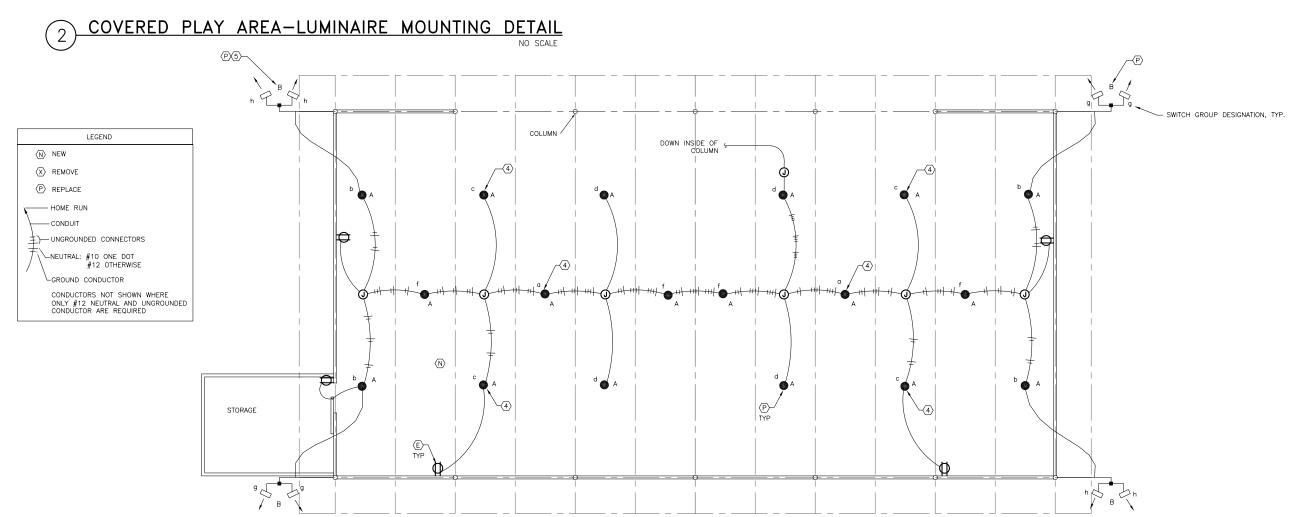

1) EXISTING LIGHTING PLAN

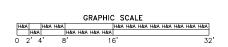








Sheet Title:

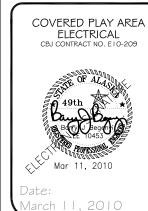

EO I

Sheet number:

l of l