STATTER HARBOR PHASE IIIC – RESTROOMS AND COVERED SHELTER Volume II of II

Contract No. DH23-010



STATTER HARBOR PHASE IIIC RESTROOMS AND COVERED SHELTER

CBJ CONTRACT No. DH23-010 JUNEAU, ALASKA SEPTEMBER 29,2022

E301

E302

FLOOR PLAN - LIGHTING, LUMINARE SCHEDULE

SCHEMATIC DIAGRAMS


HEET II	NDEX	CONSULTANTS
		ARCHITECT
Sheet Number	Sheet Name	JENSEN YORBA WALL, INC.
.001	COVER SHEET & CODE SUMMARY	522 WEST 10TH STREET JUNEAU, ALASKA 99901
A002	ABBREVIATIONS, SYMBOLS, SCHEDULES	(907) 586-1070
1003	SCHEDULES	FAX (844) 350-5352
A201	FLOOR PLAN	
A202	ROOF PLAN	ON/IL ENGINEED
A301	EXTERIOR ELEVATIONS	CIVIL ENGINEER
\302	EXTERIOR ELEVATIONS	PND ENGINEERS, INC.
A303	EXTERIOR ELEVATIONS	9360 GLACIER HIGHWAY, SUITE 100
A304	BUILDING SECTIONS	JUNEAU, ALASKA 99801
A305	WALL SECTIONS	(907) 586-2093
A306	WALL SECTIONS	FAX (907) 586-2099
A401	ENLARGED PLAN	OTDUCTUDAL ENGINEED
A500	STANDARD FIXTURE HEIGHTS	STRUCTURAL ENGINEER
A501	INTERIOR ELEVATIONS	PND ENGINEERS, INC.
A502	INTERIOR ELEVATIONS	9360 GLACIER HIGHWAY, SUITE 100
A503	INTERIOR ELEVATIONS	JUNEAU, ALASKA 99801
A601	REFLECTED CEILING PLAN	(907) 586-2093
A801	EXTERIOR DETAILS	FAX (907) 586-2099
A802	EXTERIOR DETAILS	
A803	EXTERIOR DETAILS	MECHANICAL ENGINEER
A804	EXTERIOR DETAILS	
A805	EXTERIOR DETAILS	RESPEC
A901	INTERIOR DETAILS	9109 MENDENHALL MALL RD. SUITE 4
		JUNEAU, ALASKA 99801
C101	LEGEND, GENERAL NOTES, ABBREVIATIONS, LAYOUT TABELS, SURVEY CONTROL	(907) 780-6060 FAX (907) 586-3771
C102	EXISTING CONDITIONS	1 AA (301) 300-3111
C102 C103	GENERAL SITE PLAN	
C103	SITE SECTIONS	ELECTRICAL ENGINEER
C104	CIVIL DETAILS	RESPEC
0100	ONE DETAILS	
S001	GENERAL NOTES	9109 MENDENHALL MALL RD. SUITE 4
S002	CONCREAT REINFORCING SCHEDULES AND TYPICAL DETAILS	JUNEAU, ALASKA 99801 (907) 780-6060
S200	FOUNDATION PLAN	FAX (907) 586-3771
S200	1ST FLOOR FRAMING PLAN	
S202	ROOF FRAMING PLAN	
S300	FOUNDATION DETAILS	
S301	WALL ELEVATIONS	
S302	ROOF DETAILS	
S303	ROOF DETAILS	
M001	LEGENDS AND ABBREVIATIONS	
M002	SCHEDULES	
M110	UNDERFLOOR PLUMBING PLAN	
M111	FIRST FLOOR PLUMBING PLAN	
M112	ROOF PLAN	
M121	FIRST FLOOR MECHANICAL PLAN	
/1401	MECHANICAL SECTIONS	
1402	MECHANICAL SECTIONS	
M501	DETAILS AND DIAGRAMS	
E100	LEGEND, SITE PLAN	
E201	FLOOR PLAN - POWER	

CODE SUMMARY **CODE SUMMARY CODE EDITION:** 2012 INTERNATIONAL BUILDING CODE AS ADOPTED BY CBJ OCCUPANCY: COVERED SHELTER Α3 1095 SF 219 RESTROOMS* 1423 SF 28 2518 SF * ACCESSORIY AREA-OCCUPANTS NOT COUNTED IN TOTAL **TYPE OF CONSTRUCTION: BUILDING HEIGHT:** ACTUAL OF BUILDING: 13 FT ALLOWABLE HEIGHT: 40 FT SITE DESCRIPTION: **FIRE SEPARATION** NORTH SIDE NONE EAST SIDE 100 FT NONE SOUTH SIDE NONE WEST SIDE 100 FT NONE PERIMETER FRONTING ON PUBLIC WAY OR OPEN SPACE: 80 FT WEIGHTED AVERAGE WIDTH OF FRONTAGE: 30 FT 11.36% ALLOWABLE AREA INCREASE DUE TO FRONTAGE: **ALLOWABLE AREA** <u>ALLOWED</u> RATIO STATUS FIRST FLOOR COVERED SHELTER 1095 SF RESTROOMS* 1423 SF 6681 SF 0.21 OK TOTAL 2518 SF 6681 SF 0.38


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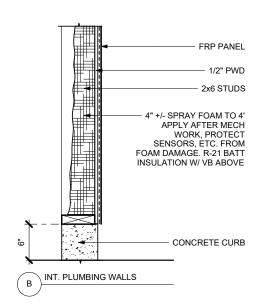
OCCUPANCY SEPARATIONS:




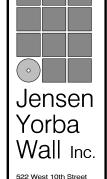


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ABBREVIATIONS

AC ACM ACP ADJ AFF AIB AL APPROX ARCH ASB	ANGLE ASPHALT CONCRETE ASBESTOS CONTAINING MATERIAL ACOUSTICAL CEILING PANEL ADJUSTABLE ABOVE FINISH FLOOR AIR INFILTRATION BARRIER ALUMINUM APPROXIMATE ARCHITECTURAL ASBESTOS
BD BLDG BLK BLKG BM BOT	BOARD BUILDING BLOCK BLOCKING BEAM BOTTOM
CAB CB CEM CG CI CLG CONC CONT CTR CTSK	CABINET CATCH BASIN CEMENT CORNER GUARD CAST IRON CEILING COLUMN CONCRETE CONTINUOUS CENTER COUNTERSUNK
DBL DEPT DF DET DIA DIM DISP DN DR DS DWG DWG	DOUBLE DEPARTMENT DRINKING FOUNTAIN DETAIL DIAMETER DIMENSION DISPENSER DOWN DOOR DOWNSPOUT DRAWING DRAWER

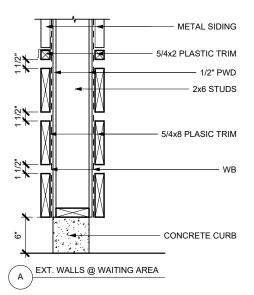FACH EXHAUST FAN

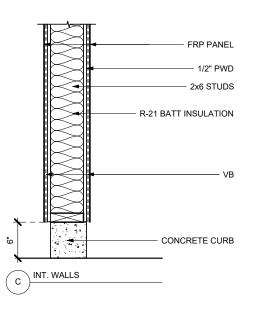ELEC

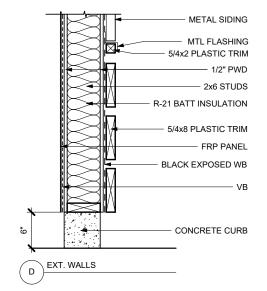ELEV

EXTERIOR INSULATION & FINISH SYSTEM

EXPANSION JOINT

ELEVATION


ELECTRICAL

ELEVATOR

EMER ENCL	EMERGENCY ENCLOSURE	LAB LAM	LABORATORY LAMINATE
EPDM	ETHYLENE PROPYLENE DIANE MONOMER	LAV LB	LAVATORY POUND
EPS EQ	EXPANDED POLYSTYRENE EQUAL	LT	LIGHT
EQP EX	EQUIPMENT EXISTING	MIR MAX	MIRROR MAXIMUM
EXT	EXTERIOR	MDO MECH	MEDIUM DENSITY C
FA FD	FIRE ALARM FLOOR DRAIN	MEMB MFR	MEMBRANE MANUFACTURER
FDN FEC	FOUNDATION FIRE EXTINGUISHER CABINET	MH MIN	MANHOLE MINIMUM
FF FGL	FINISH FLOOR FIBER GLASS	MISC MTD	MISCELLANEOUS MOUNTED
FHC FIN	FIRE HOSE CABINET FINISH	MTL MUL	METAL MULLION
FLASH	FLASHING		
FLR FOC	FLOOR FACE OF CONCRETE	NIC NO OR #	NOT IN CONTRACT NUMBER
FOF FOS	FACE OF FINISH FACE OF STUD	NOM NTS	NOMINAL NOT TO SCALE
FRP	(GLASS) FIBER REINFORCED PLASTIC	OA	OVERALL
FRPF FR	FIREPROOF FIRE RETARDANT	OC OD	ON CENTER OUTSIDE DIAMETER
FSR FT	FLEXIBLE SHEET ROOFING FOOT OR FEET	OFCI	OWNER FURNISHED CONTRACTOR INST
FTG FURR	FOOTING FURRING	OFOI	OWNER FURNISHED
GA	GAUGE	OFD OFF	OVERFLOW DRAIN OFFICE
GALV GB	GALVANIZED GRAB BAR	OPNG OPP	OPENING OPPOSITE
GL GWB GYP	GLASS GYPSUM WALL BOARD GYPSUM	OSB OTS	ORIENTED STRAND OPEN TO STRUCTU
НВ	HOSE BIBB	PL PLAM	PLATE PLASTIC LAMINATE
HDWD HM	HARDWOOD HOLLOW METAL	PLAS PC	PLASTER PRE-CAST
HORIZ HR	HORIZONTAL HOUR	PF PR	PRE-FINISHED PAIR
HT HW	HEIGHT HOT WATER	PWD	PLYWOOD
ID	INSIDE DIAMETER	R RAD	RISER RADIUS
INSUL INT	INSULATION INTERIOR	RD REF	ROOF DRAIN REFERENCE
JAN JT	JANITOR JOINT	REFR REINF REQ	REFRIGERATOR REINFORCED REQUIRED

,	RESIL RH RL RM RO RUB RWD	RESILIENT ROBE HOOK RAIN LEADER ROOM ROUGH OPENING RUBBER REDWOOD	
SITY OVERLAID RER DUS	SASU SCD SCHED SF SHR SHTH SIM SND	SELF ADHERING SHEET UNDERLAYMENT SEAT COVER DISPENSER SCHEDULE SQUARE FOOT SHOWER SHEATHING SIMILAR SANITARY NAPKIN DISPENSER	
RACT E METER NISHED	SNR SPEC SQ STA STC STD STL STOR STRUCT SS SUSP	SANITARY NAPKIN RECEPTACLE SPECIFICATIONS SQUARE STATION SOUND TRANSMISSION CLASS STANDARD STEEL STORAGE STRUCTURAL STAINLESS STEEL SUSPENDED	
R INSTALLED INST	TB TC TEL TEMP T&G TOB TOC TOD TOP TPD TRD TRD TRTD TOW TYP	SQUARE YARD TOWEL BAR TOP OF CURB TELEPHONE TEMPORARY TONGUE & GROOVE TOP OF BEAM TOP OF CONCRETE TOP OF DECK TOP OF PLATE TOILET PAPER DISPENSER TREAD PRESSURE TREATED TOP OF WALL TYPICAL	
OR	UL UNF UON UR VERT VEST VR	UNDERWRITERS LABORATORIES UNFINISHED UNLESS OTHERWISE NOTED URINAL VERTICAL VESTIBULE VAPOR RETARDER	
	VTR	VENT THROUGH ROOF	

WC	WATER CLOSET
WD	WOOD
WO	WALK OFF MAT
WP	WATERPROOF/WALL PANEL
WR	WASTE RECEPTACLE
WSCT	WAINSCOT
WT	WEIGHT

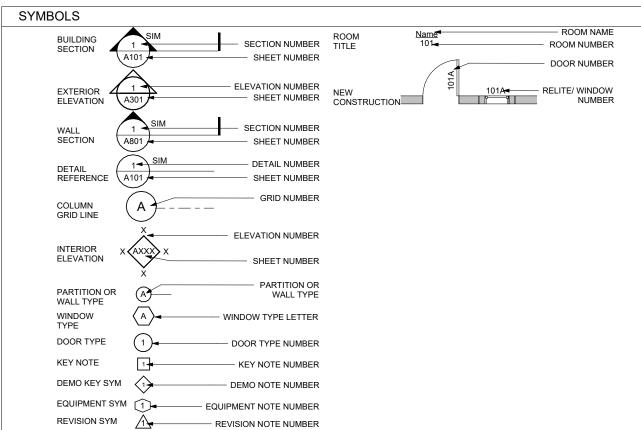

CITY AND BOROUGH OF JUNEAU STATTER HARBOR PHASE IIIC RESTROOMS AND COVERED SHELTER CBJ CONTRACT No. DH23-010 JUNEAU, ALASKA

SHEET TITLE ABBREVIATIONS,

SYMBOLS, SCHEDULES


FINISH SCHEDULE

	Finish Schedule								
Room				Wa	alls				
No.	Room Name	Floor Finish	North	East	South	West	Ceiling	Comments	
100	MAINTENANCE	SLR	FRP	FRP	FRP	FRP	STAIN		
101	MEN	SLR	FRP	FRP	FRP	FRP	STAIN		
103	WOMEN	SLR	FRP	FRP	FRP	FRP	STAIN		
102	PLUMBING	SLR							
104	FAMILY	SLR	FRP	FRP	FRP	FRP	FRP		
105	WAITING						STAIN		

DOOR SCHEDULE

	Opening Schedule															
	Оре	ening		De	oor	Fra	ame			Signage			Details			
Mark	Туре	Width	Height	MAT	FIN	MAT	FIN	Glass	Туре	Text	Fire Rating	Jamb	Head	Sill	HW	Remarks
										,	,					
100	Α	3' - 0"	7' - 0"	FGL	PF	FGL	PF		В	MAINTENANCE		5/A801, SIM	2/A801, SIM			
101	Α	3' - 0"	7' - 0"	FGL	PF	FGL	PF		Α	MEN		5/A801	2/A801			
102	Α	3' - 0"	7' - 0"	FGL	PF	FGL	PF					5/A801, SIM	2/A801, SIM			
103	А	3' - 0"	7' - 0"	FGL	PF	FGL	PF		Α	WOMEN		5/A801	2/A801			
104	А	3' - 0"	7' - 0"	FGL	PF	FGL	PF		Α	FAMILY		5/A801	2/A801			

DOOR TYPES WINDOW TYPES (3) (A801) 3 A801 6 A801 SEE SCHEDULE $\langle 1 \rangle$ A

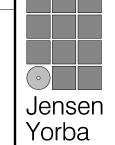

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CBJ CONTRACT No. DH23-010

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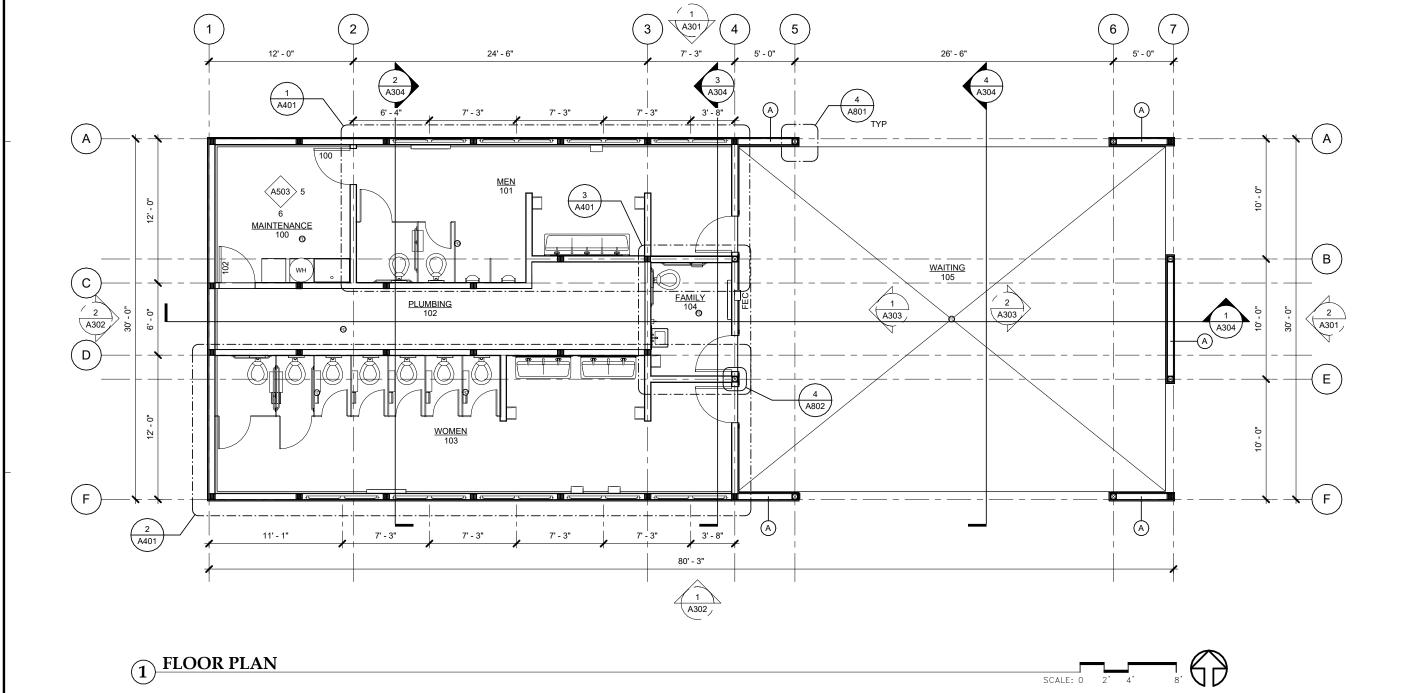
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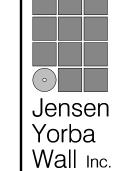
SCHEDULES

DATE: SEPTEMBEI









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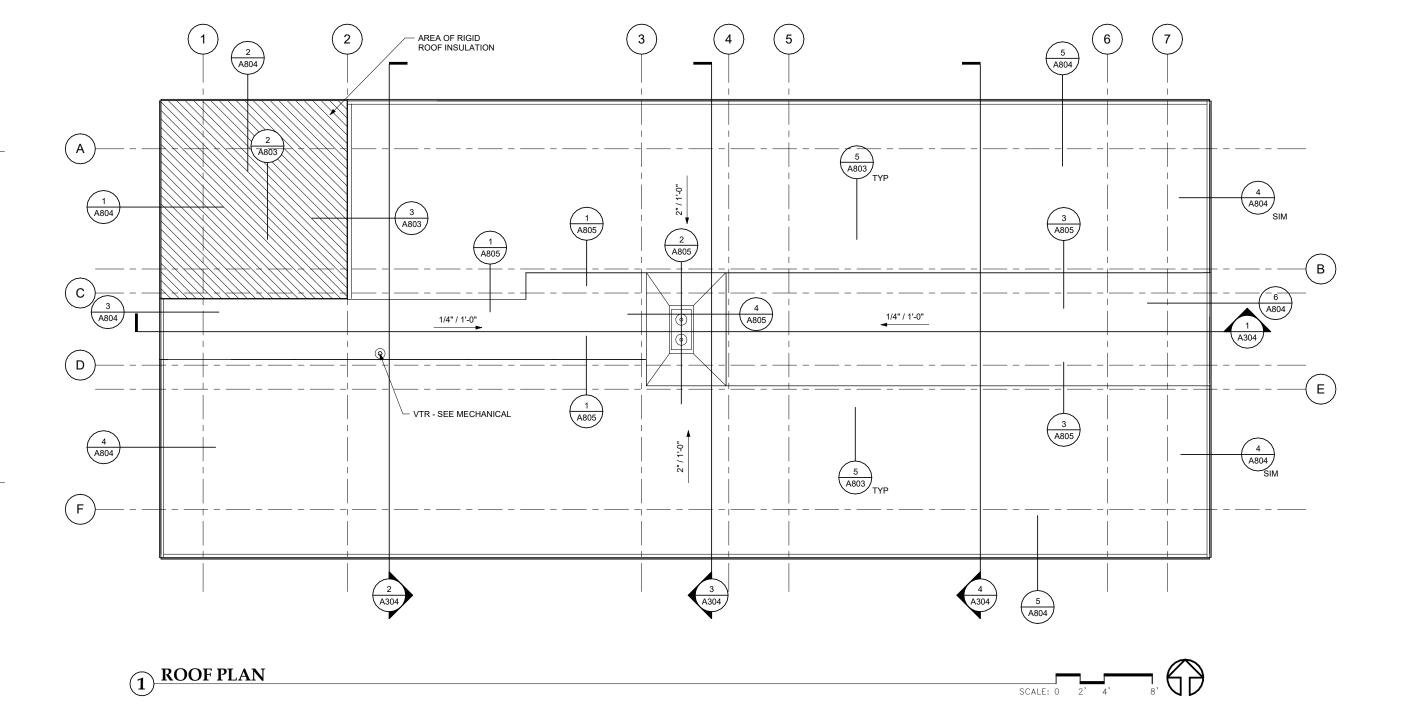



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SHEET TITLE FLOOR PLAN







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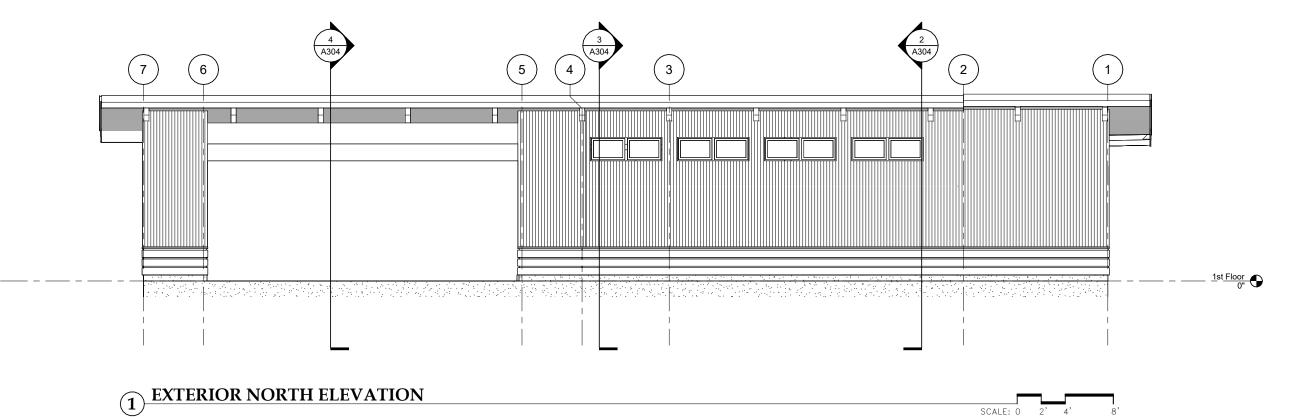
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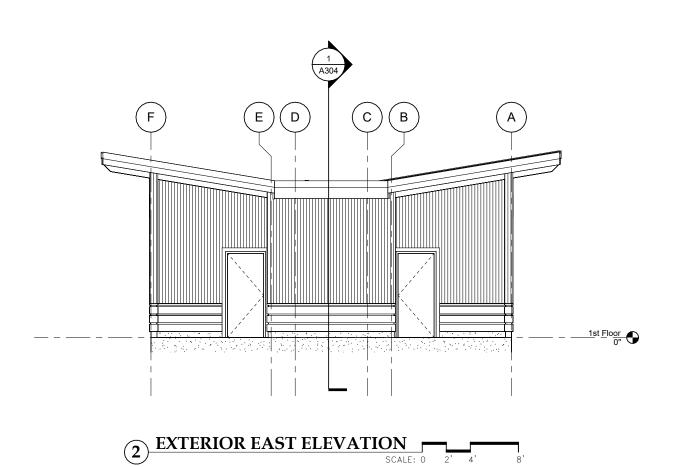
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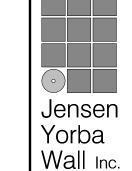
SHEET TITLE

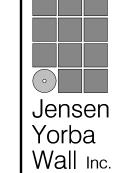ROOF PLAN

DATE: SEPTEMBER 29,2022 FILE: 22017







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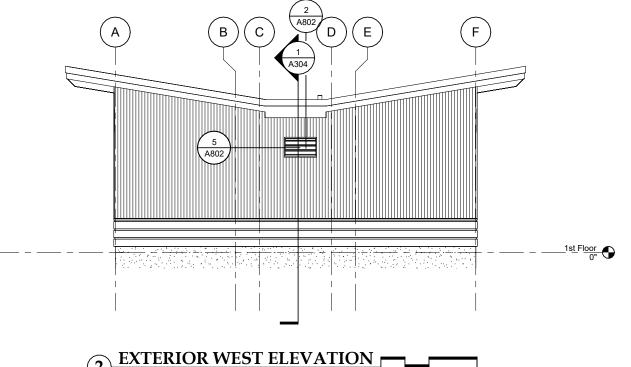
REVISIONS

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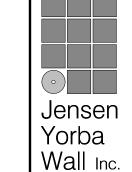
EXTERIOR ELEVATIONS

3 A304

2 A304



SCALE: 0 2' 4'



6

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1st Floor 0"

CITY AND BOROUGH OF JUNEAU STATTER HARBOR PHASE IIIC SESTROOMS AND COVERED SHELTE CBJ CONTRACT NO. DH23-010


REVISIONS

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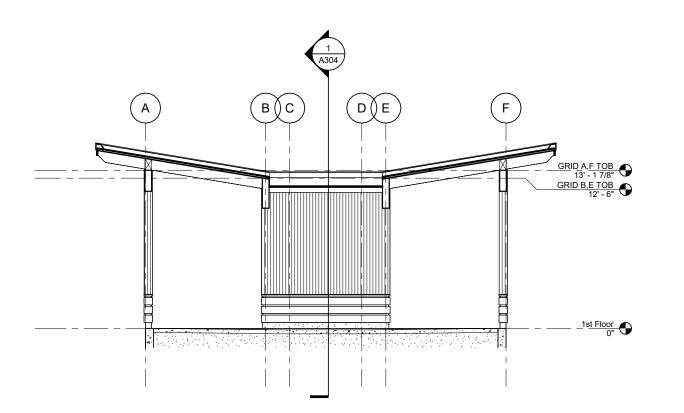
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EXTERIOR


ELEVATIONS




1 WAITING 105 EAST ELEVATION

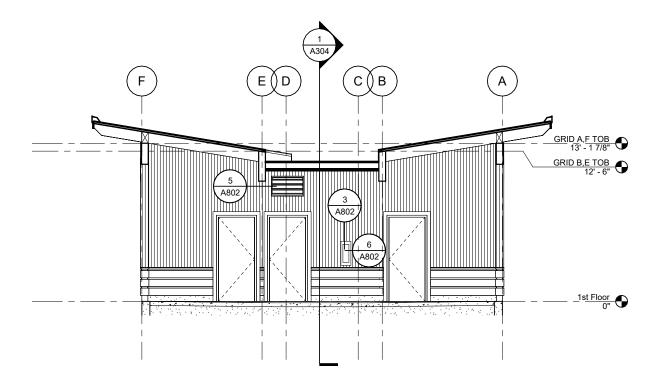

2 WAITING 105 WEST ELEVATION

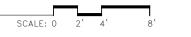

SCALE: 0 2' 4'

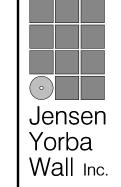

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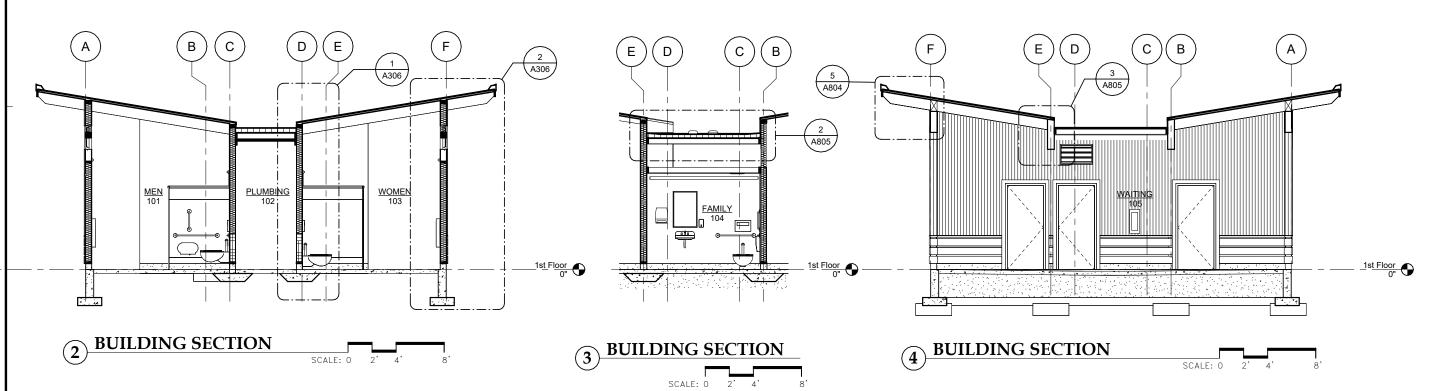
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SHEET TITLE

EXTERIOR ELEVATIONS

DATE: SEPTEMBER 29,2022 FILE: 22017






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SHEET TITLE

BUILDING SECTIONS

DATE: SEPTEMBER 29,2022 FILE: 22017



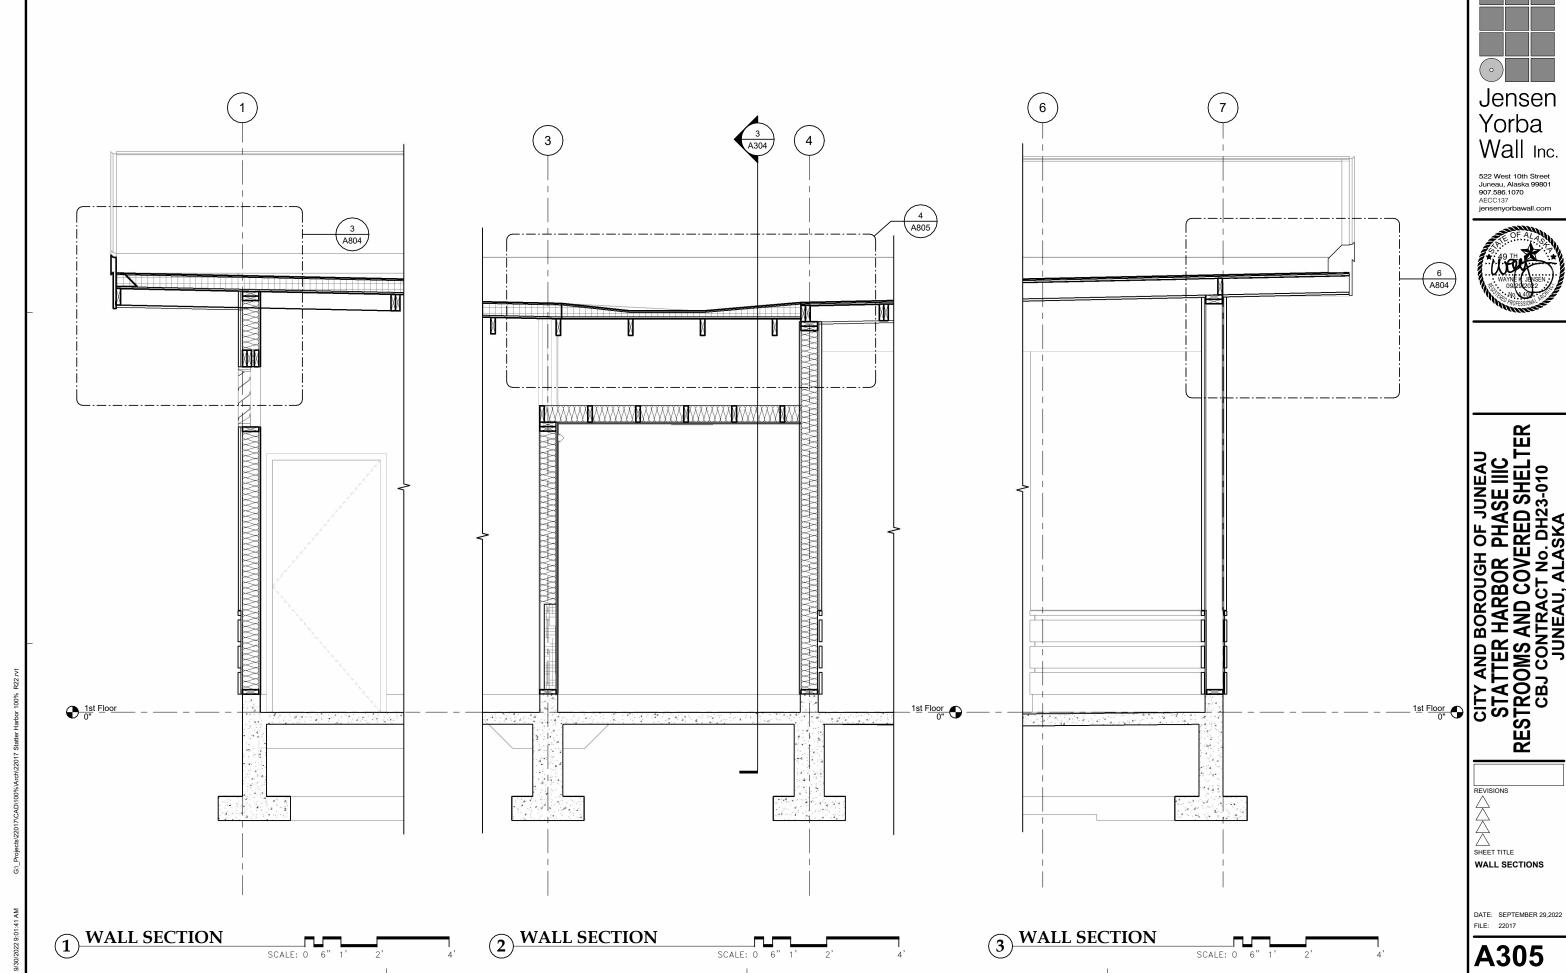

D

(E `

1st Floor 0"


GRID A,F TOP 14' - 0 3/4"

10' - 0"

1st Floor 0"

A801)

A801

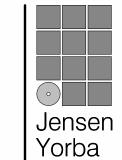

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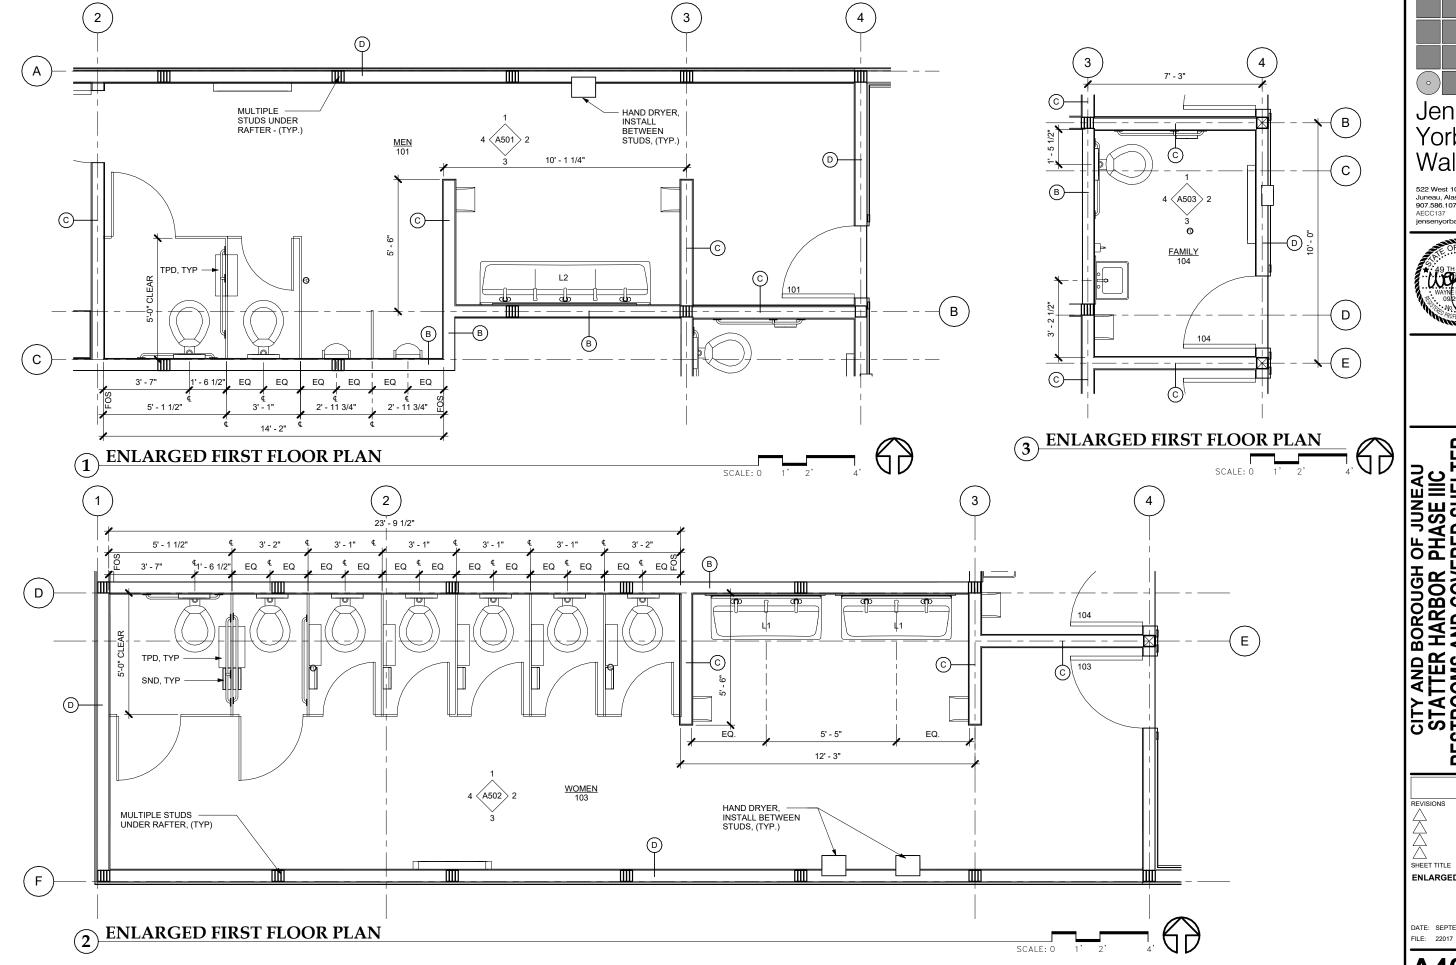


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SHEET TITLE

WALL SECTIONS



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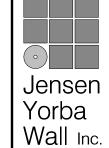
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SHEET TITLE **ENLARGED PLAN**

DATE: SEPTEMBER 29,2022



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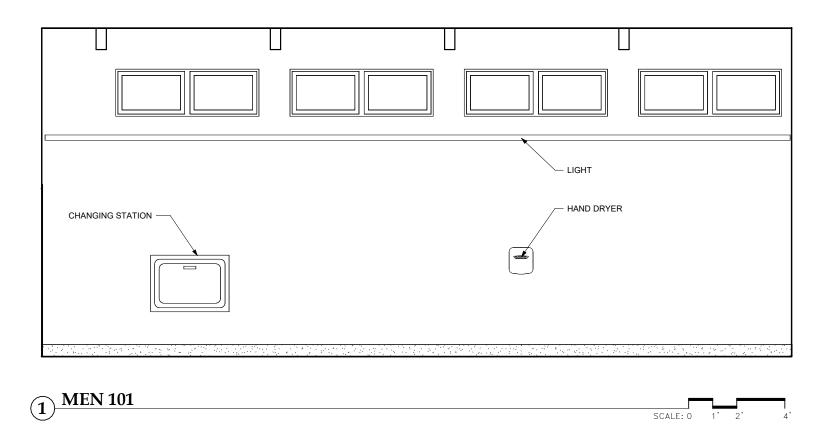
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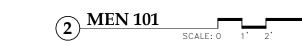
SHEET TITLE

STANDARD FIXTURE

STANDARD FIXTURE HEIGHTS

DATE: SEPTEMBER 29,2022 FILE: 22017







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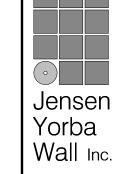
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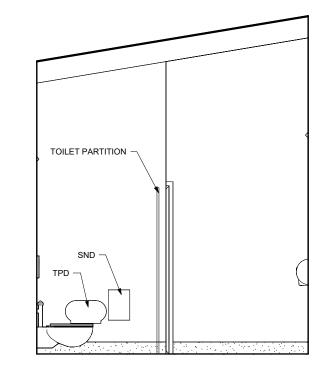


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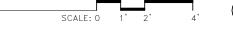



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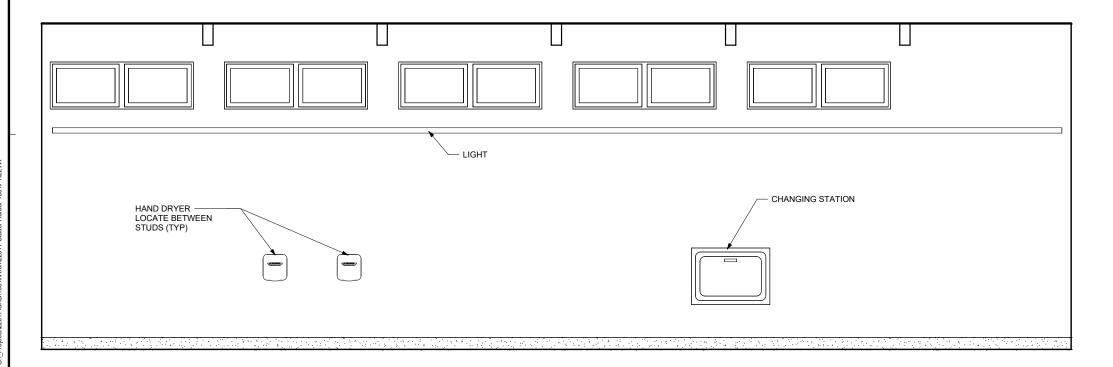
SHEET TITLE INTERIOR ELEVATIONS

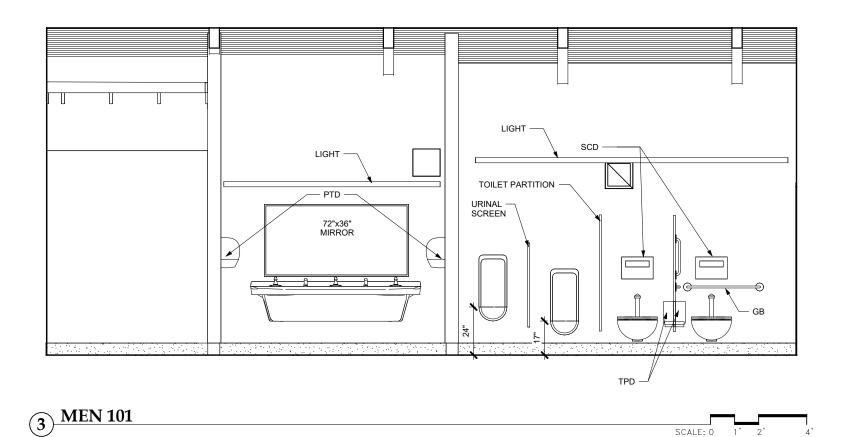


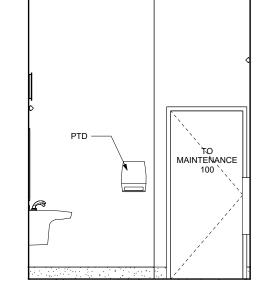WOMEN 103





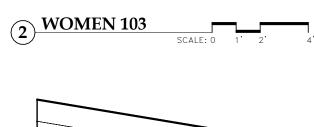

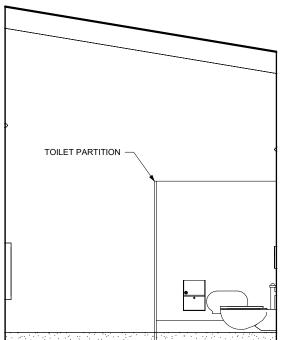

3 WOMEN 103


4 WOMEN 103 SCALE: 0 1' 2' Jensen Yorba Wall Inc.


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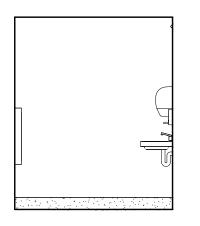



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SHEET TITLE INTERIOR ELEVATIONS





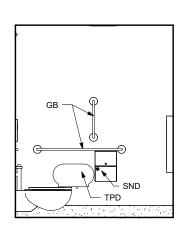


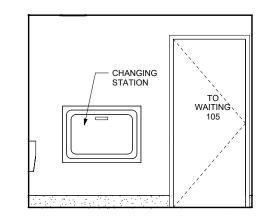


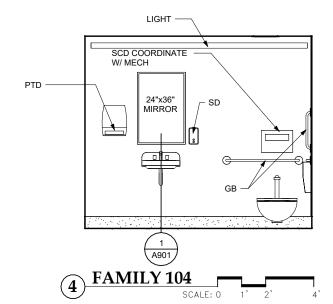





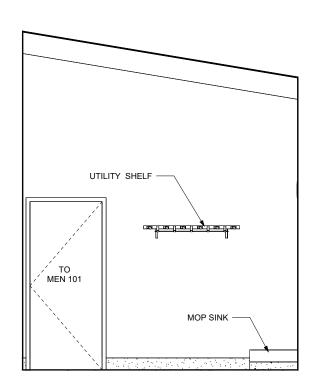

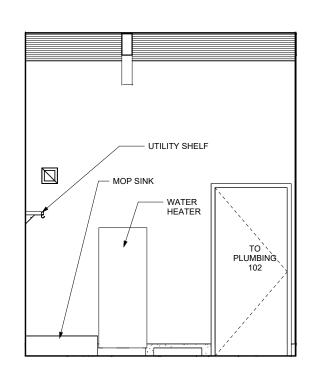







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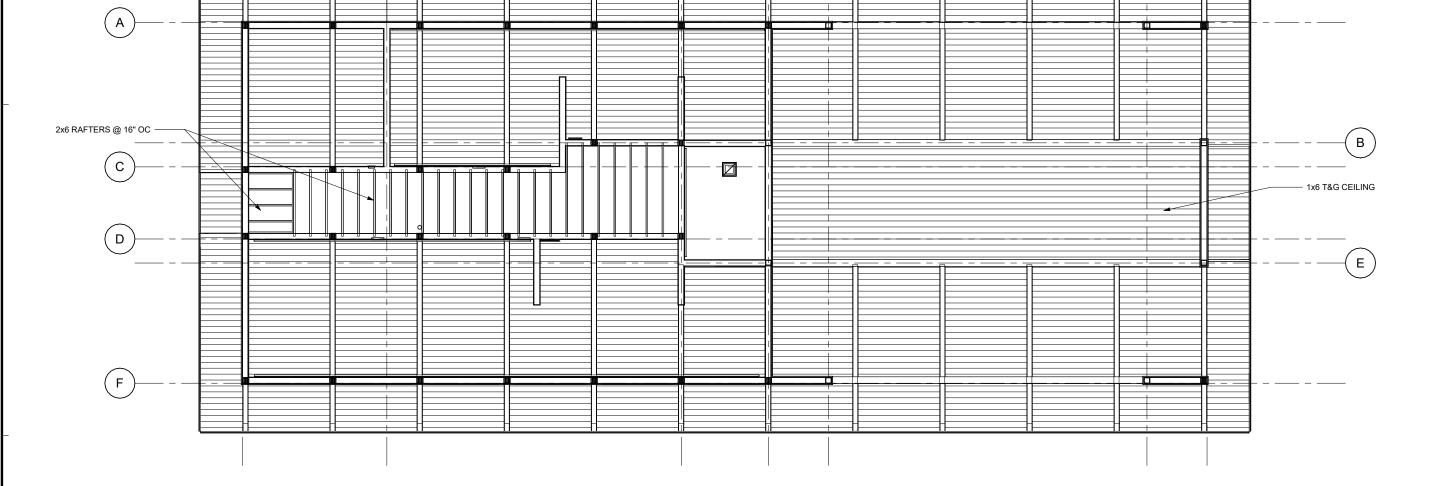
SHEET TITLE

INTERIOR

ELEVATIONS







(3)

(2)

1 REFLECTED CEILING PLAN

(5)

(6 [`]

SCALE: 0 2' 4'


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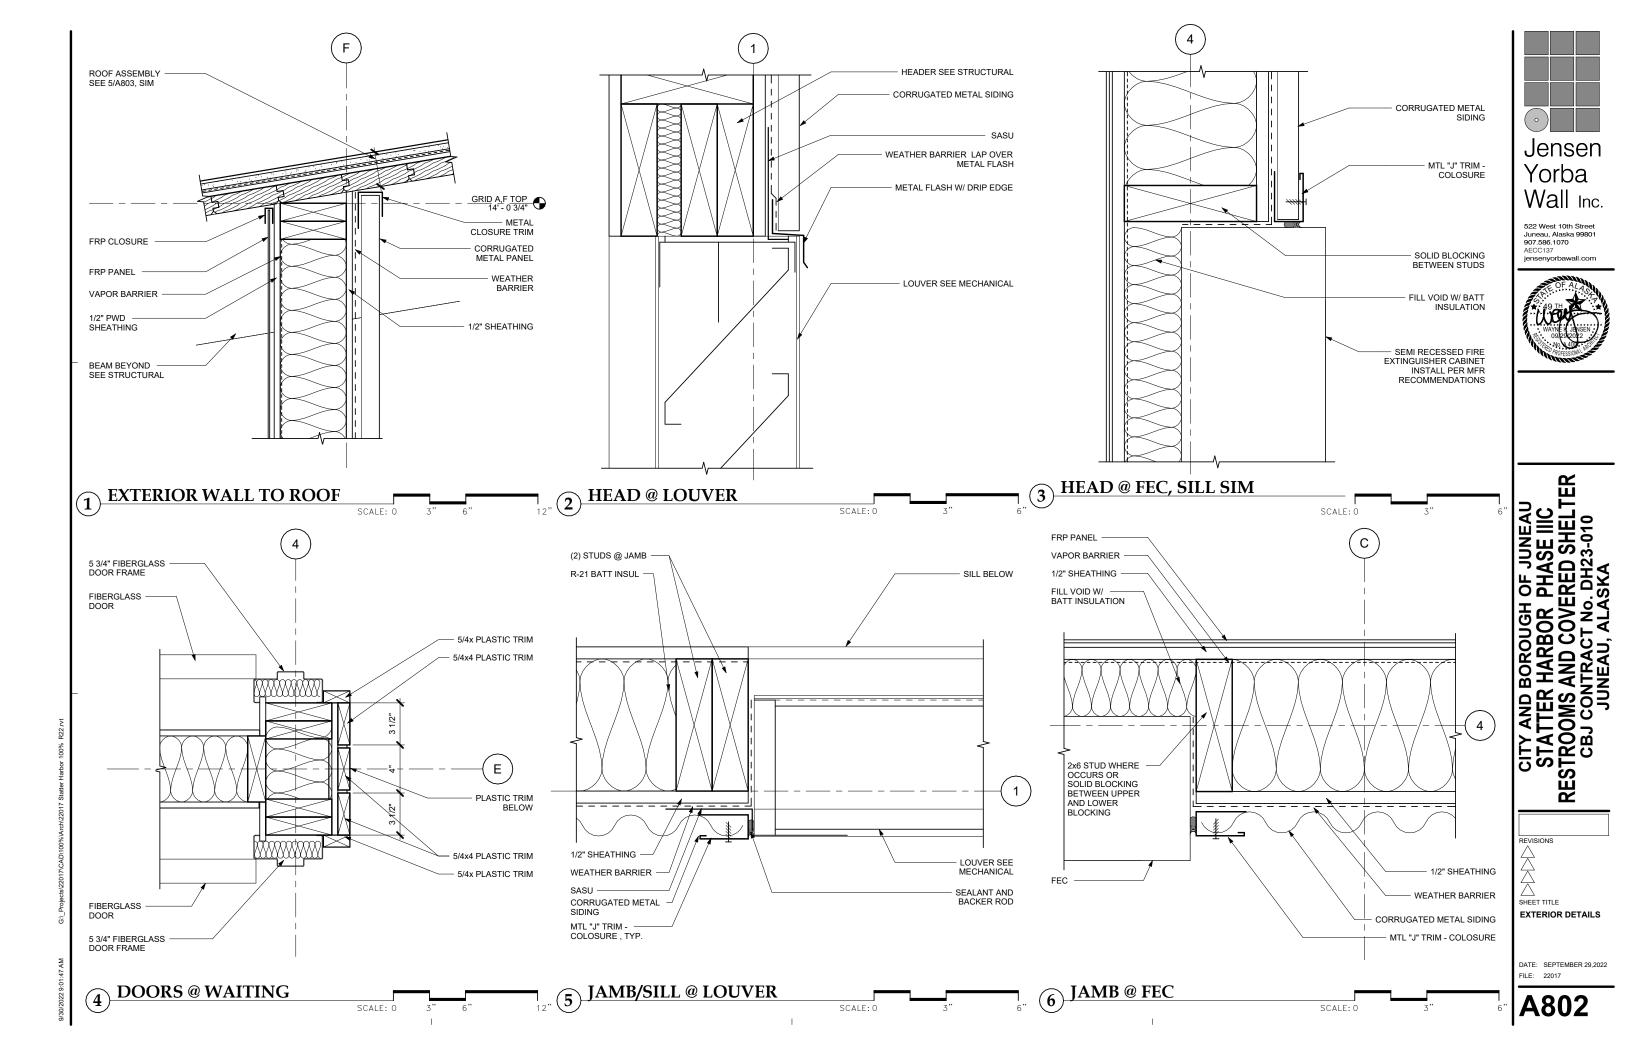



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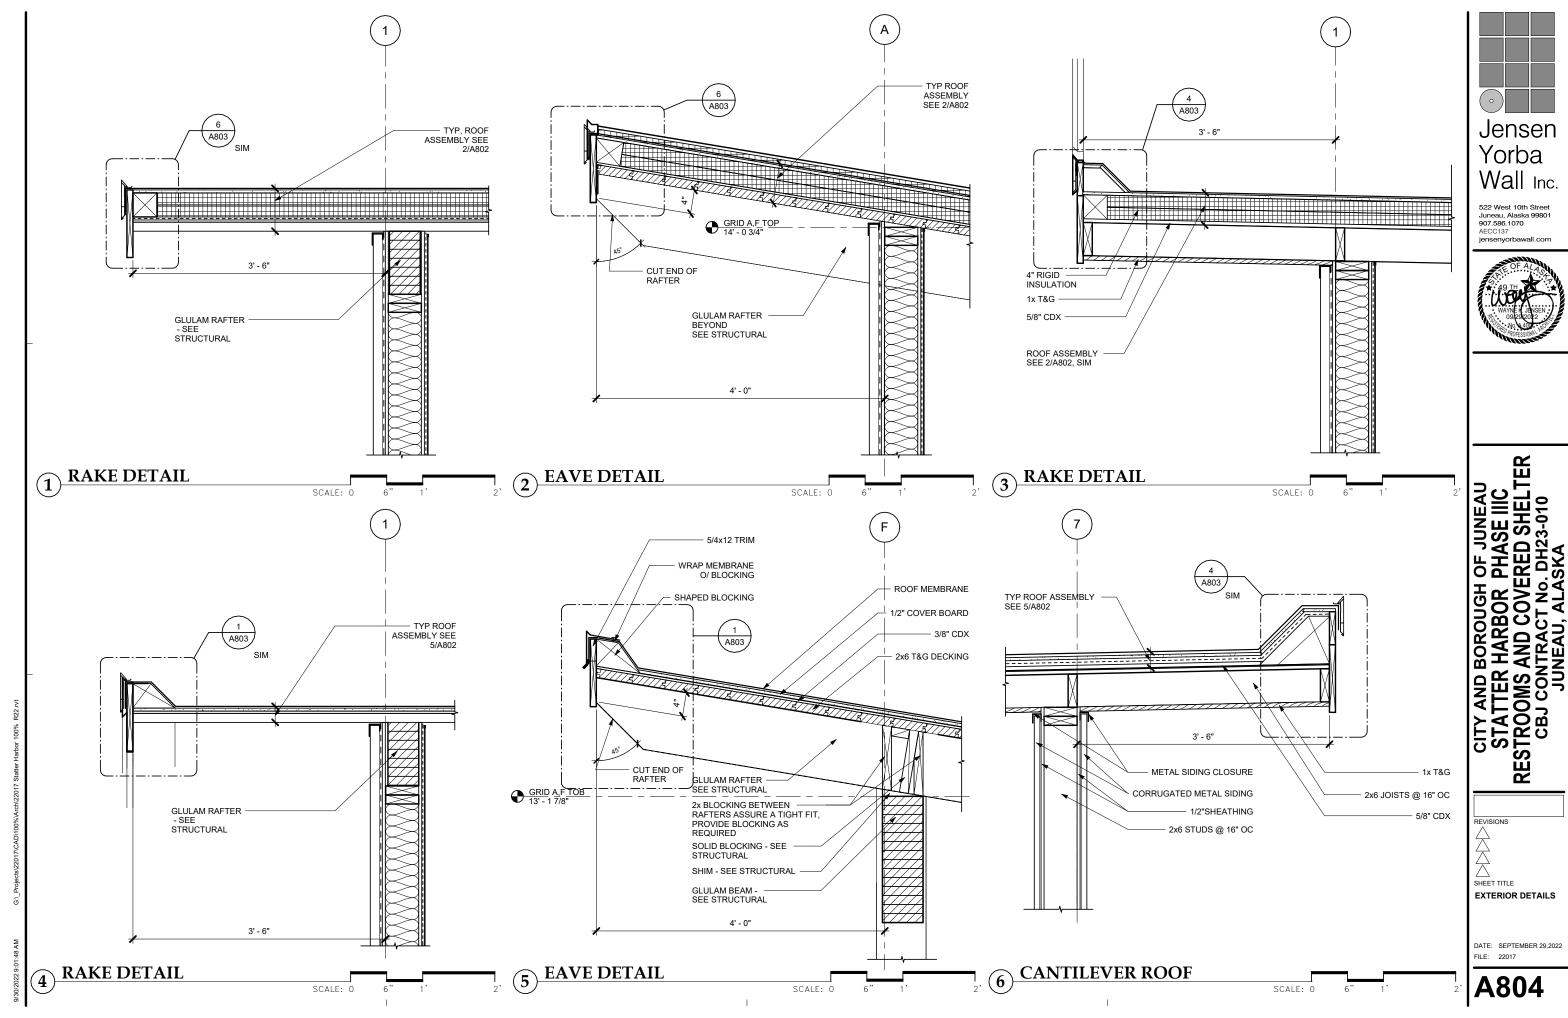
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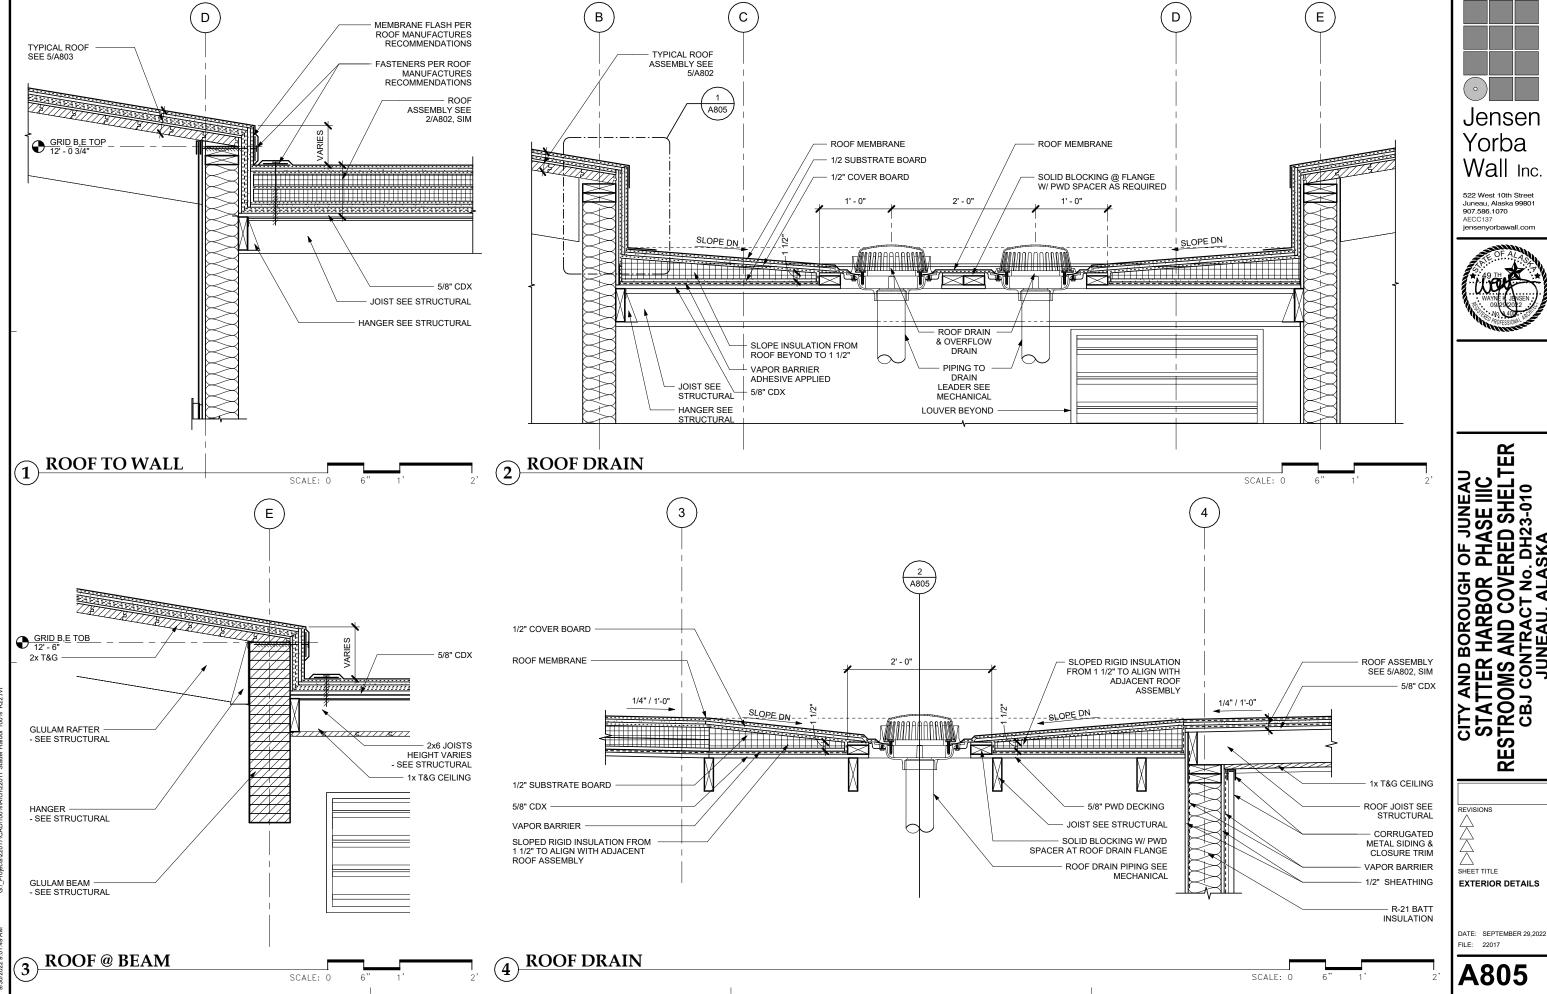









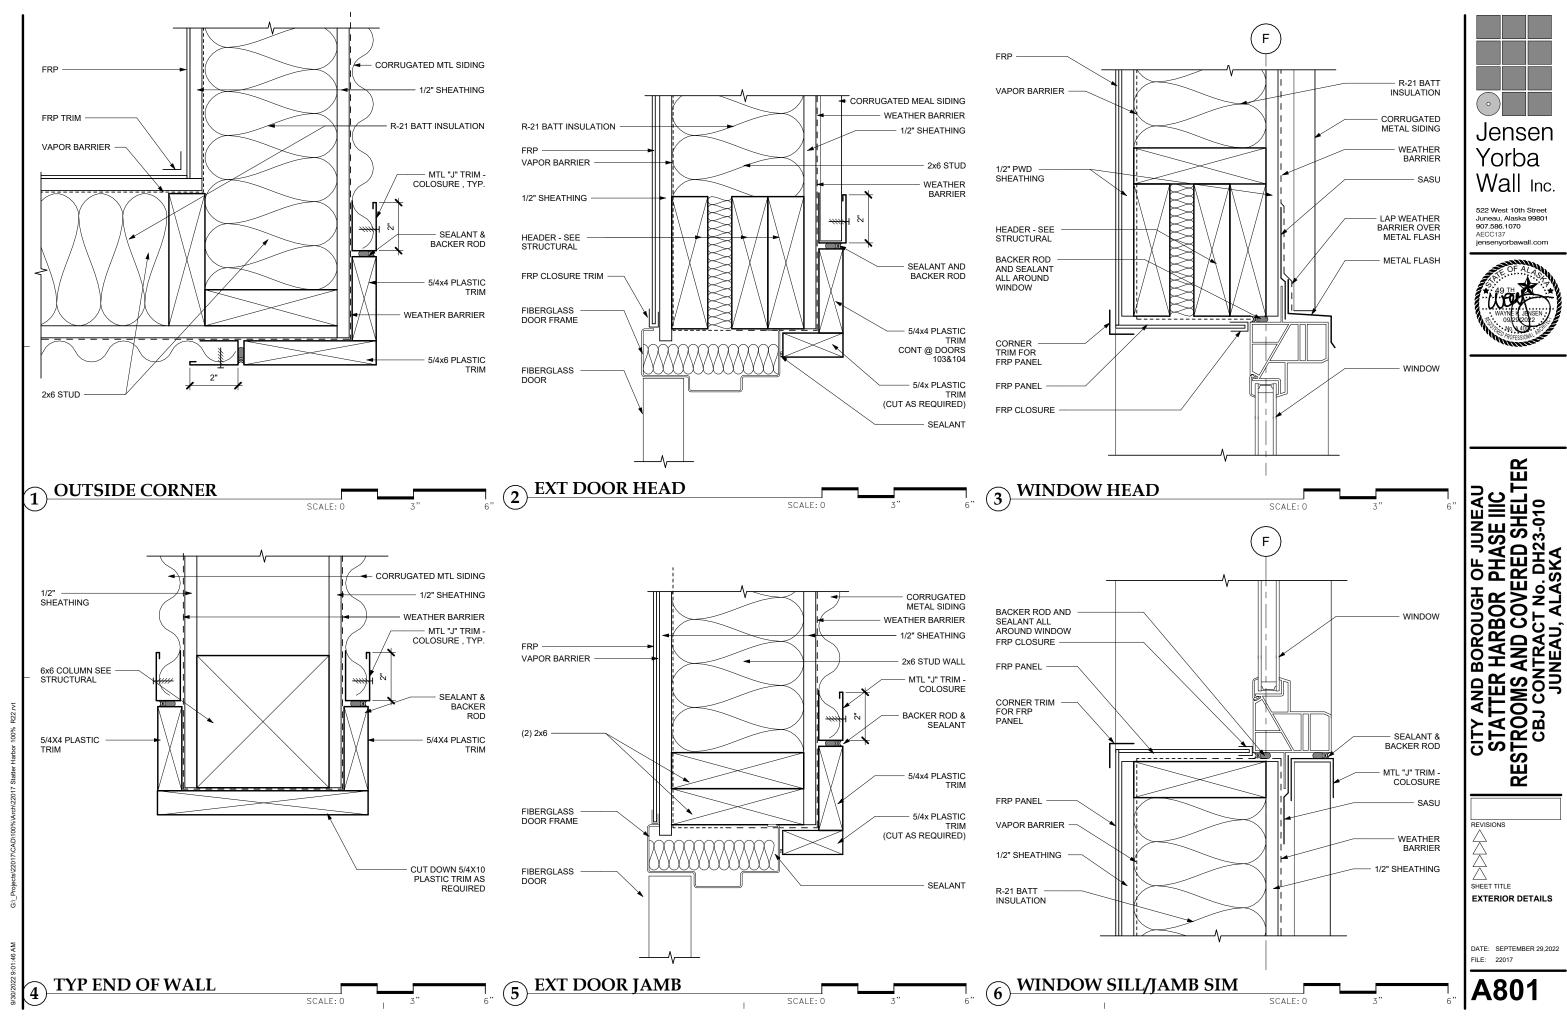

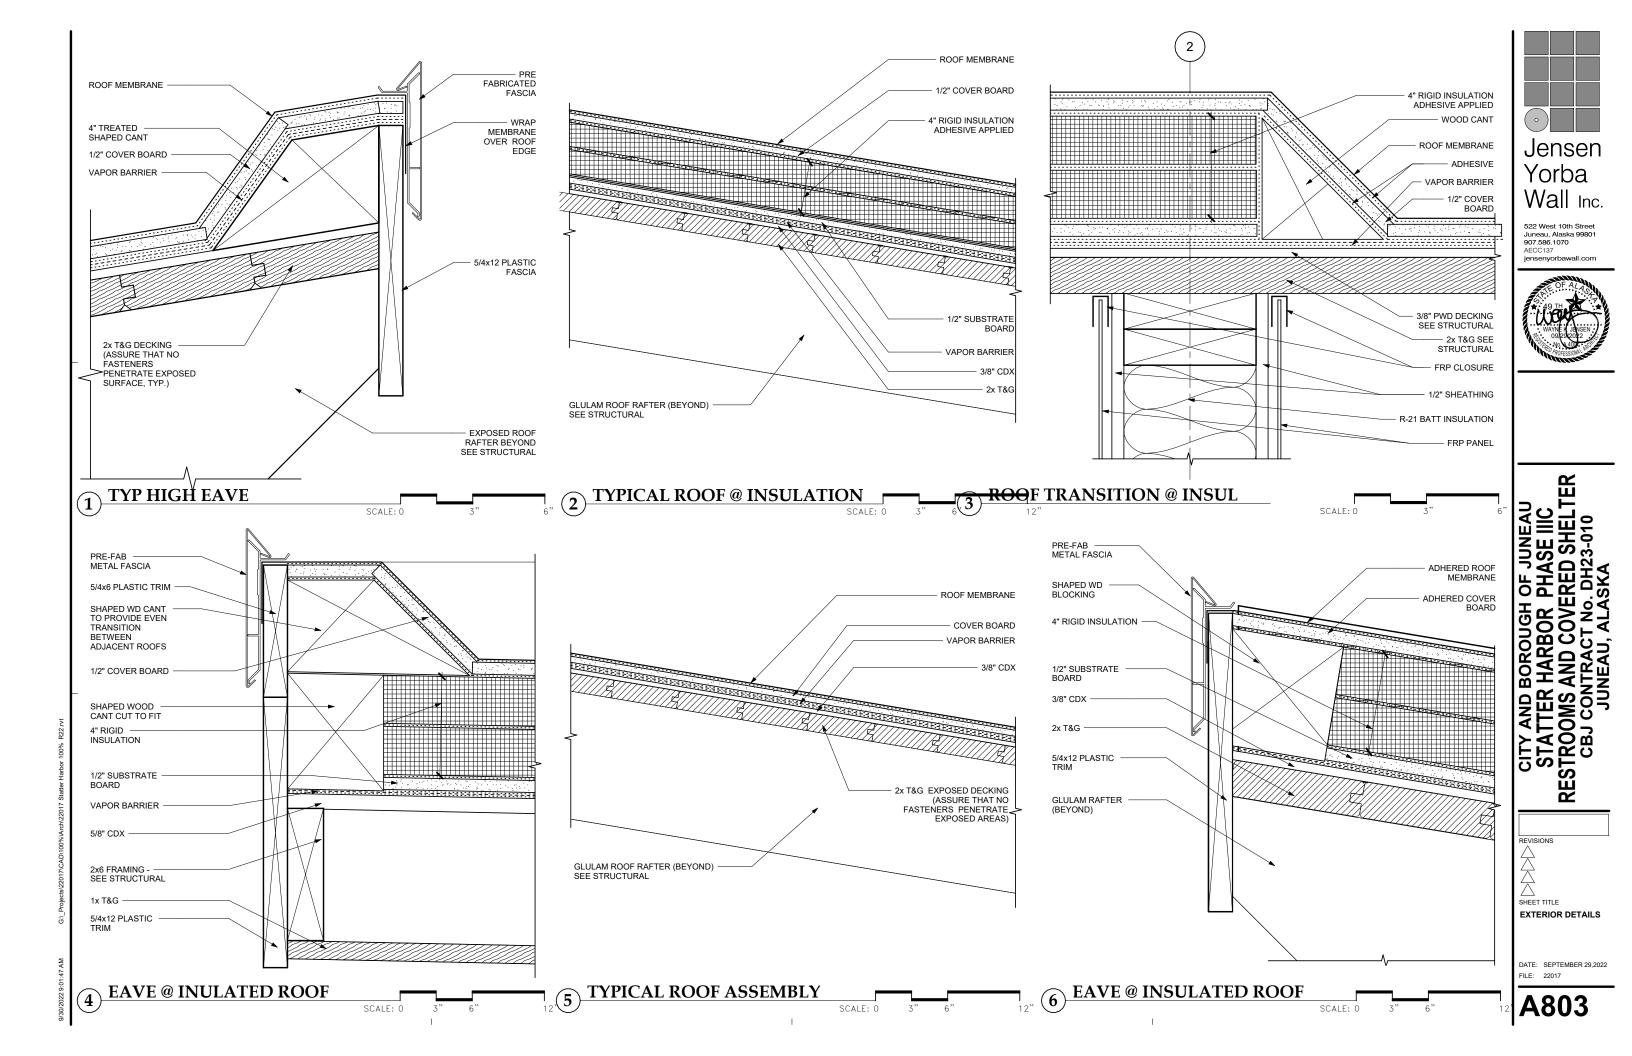


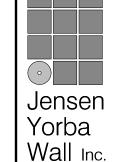

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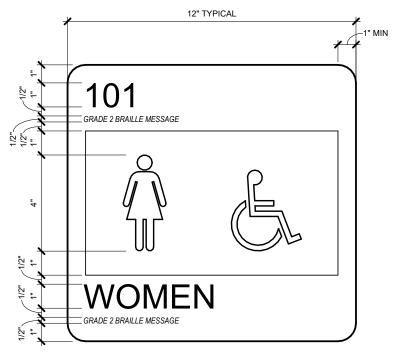



ER CITY AND STATTER STATTER RESTROOMS CBJ COI

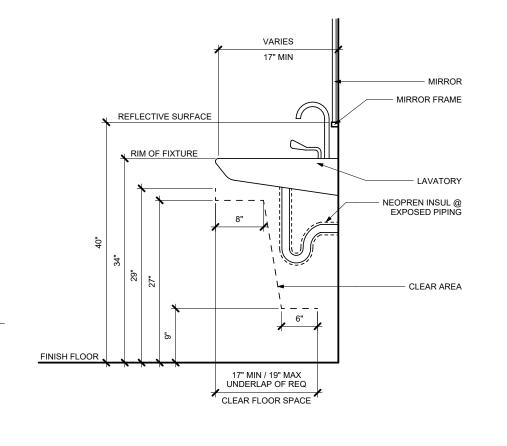

BACKING PLATE CONSTRUCTION

@ WD STUDS




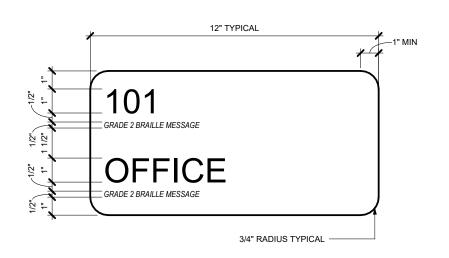


INTERIOR PANEL SIGN TYPE B VARY SIZE AS REQUIRED TO FIT MESSAGE TEXT

6 TYPICAL SIGNAGE

INTERIOR PANEL SIGN TYPE A

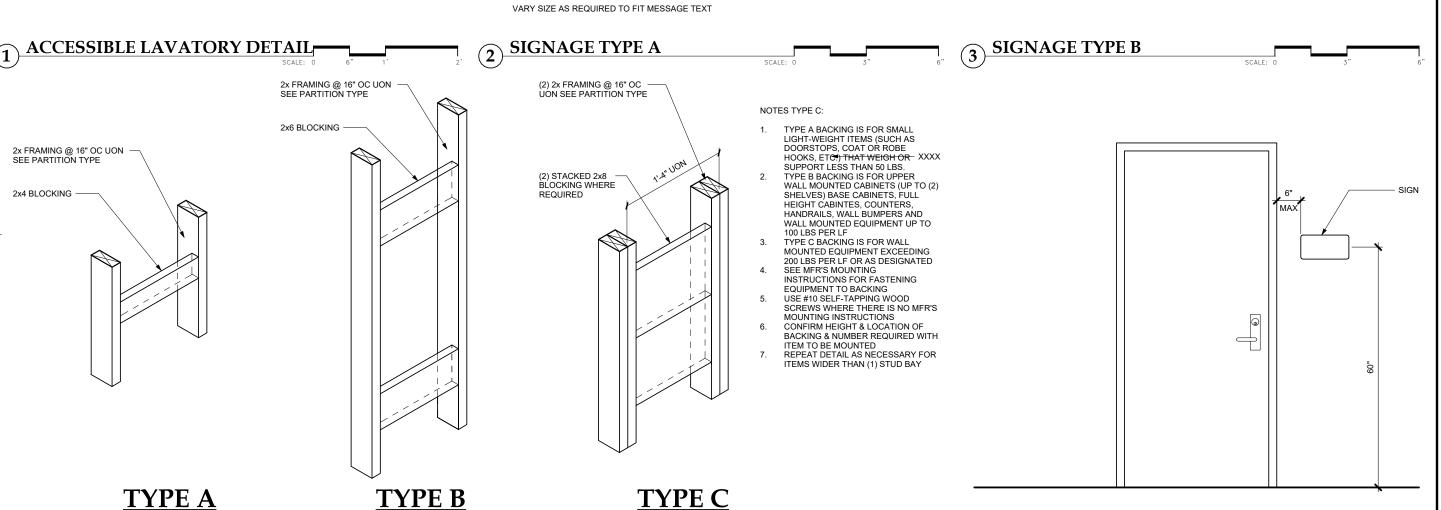

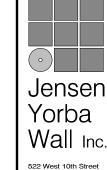

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AND BOROUGH OF JUNEAU ATTER HARBOR PHASE IIIC DOMS AND COVERED SHELTEF 3J CONTRACT No. DH23-010 JUNEAU, ALASKA

REVISIONS

SHEET TITLE

INTERIOR DETAILS

DATE: SEPTEMBER 2 FILE: 22017

GENERAL NOTES

- PROPERTY DISTURBED DURING CONSTRUCTION SHALL BE RESTORED TO ITS PRE-CONSTRUCTION CONDITION OR BETTER AT NO ADDITIONAL COST.
- CBJ ENGINEERING STANDARD DETAILS BOOK DATED AUGUST, 2011 IS MADE A PART OF THIS CONTRACT, WITH CURRENT REVISIONS AS APPLICABLE. STANDARD DETAILS SHALL ONLY BE UTILIZED
- AS SPECIFICALLY REFERENCED IN THE DRAWINGS WITH MODIFICATIONS SPECIFIED.
 THE CONTRACTOR SHALL BE RESPONSIBLE FOR ADHERING TO ALL APPLICABLE, LOCAL, STATE AND FEDERAL CODES, PERMITS AND SAFETY REQUIREMENTS.
- THE LOCATIONS OF EXISTING FEATURES AND UTILITIES SHOWN ON THE DRAWINGS ARE APPROXIMATE. ADDITIONAL UTILITIES NOT SHOWN IN THESE DRAWINGS MAY BE PRESENT. THE CONTRACTOR SHALL VERIFY ALL UTILITY LOCATIONS IN THE FIELD AS NECESSARY, PRIOR TO BEGINNING WORK. THE HORIZONTAL AND VERTICAL LOCATIONS OF ALL UTILITIES ENCOUNTERED IN THE FIELD SHALL BE RECORDED ON THE CONTRACTOR'S RECORD DRAWINGS. CONTACT LOCAL UTILITY COMPANIES PRIOR TO ANY/ ALL EXCAVATIONS AT THE FOLLOWING TELEPHONE NUMBERS:

DIAL BEFORE YOU DIG! 586-1333

UNDERGROUND POWER, TELEPHONE, T.V., COMMUNICATIONS, WATER AND WASTEWATER LINES ARE IN THE AREA. UTILITIES SHOWN HERE DO NOT SUBSTITUTE FOR FIELD LOCATES.

- GRADING AND FINAL ALIGNMENT OF UTILITIES & PIPING ARE SUBJECT TO MINOR REVISIONS BY THE ENGINEER TO FIT SITE CONDITIONS, AT NO ADDITIONAL COST.
- CONTRACTOR SHALL COORDINATE WITH ALL AFFECTED BOROUGH DEPARTMENTS AND LOCAL UTILITY
- COMPANIES DURING CONSTRUCTION.
 THE CONTRACTOR SHALL NOT DISRUPT UTILITY SERVICES EXCEPT AS REQUIRED TO COMPLETE THE RECONFIGURATION OF THOSE SERVICES AS SHOWN IN THE PLANS. COORDINATE ANY DISRUPTIONS WITH OWNER A MINIMUM OF 48 HOURS IN ADVANCE.

ABBREVIATIONS

FORCE MAIN SEWER

GRADE BREAK

GATE VALVE

FT G

GB GV

ADL	INL VIA HONS				
A A A C ACP ACP APPROX. B BLDG BTM, BOT BBWN C C C C C C C C C C C C C	AT ASPHALT CONCRETE PAVEMENT APPROXIMATE BUILDING BOTTOM BETWEEN CURB & GUTTER CATCH BASIN CAST—IN—PLACE CENTER LINE CLEAR CORRUGATED METAL PIPE CLEANOUT CONCRETE CORRUGATED POLYETHYLENE PIPE CORNERS CONNECT TO EXISTING CENTER CUBIC YARD DIAMETER DOUBLE DUCTILE IRON PIPE DIMENSION DETAIL EAST EACH EXPANSION JOINT ELEVATION EQUAL EXISTING STRUCTURE EACH WAY	H HDG HWY. I ID IE INV J JB K K L LF LONG M MAX MH MIN MSE MTL N NFS NTS O OC OD OHE OSHA	HOT-DIPPED GALVANIZED HIGHWAY INSIDE DIAMETER INVERT ELEVATION INVERT JUNCTION BOX RATE OF CURVATURE LINEAR FEET LONGITUDINALLY MAXIMUM MANHOLE MINIMUM MEAN LOWER LOW WATER MECHANICALLY STABILIZED EARTH MATERIAL (S) NORTH NON FROST SUSCEPTIBLE NOT TO SCALE ON CENTER OUTSIDE DIAMETER OVERHEAD ELECTRICAL OCCUPATIONAL SAFETY & HEALTH ADMIN.	Q QTY R R/RAD RE REQD REQMTS ROW S SDI SDO SDR SF SHT SPEC SS SDMH STA STD SWR SY SYMM T L&B t/THK TD TRANS TYP U UE V W W/ WL	QUANTITY RADIUS RIM ELEVATION REQUIRED REQUIRED REQUIREMENTS RIGHT OF WAY STORM DRAIN INLET STRUCTL STORM DRAIN OUTLET STRUCTL STORM DRAIN OUTLET STRUCTL STANDARD DIMENSION RATIO SQUARE FOOT SHEET SPECIFICATION (S) STAINLESS STEEL, SANITARY STORM DRAIN MANHOLE SANITARY SEWER MANHOLE STATION STANDARD SEWER SQUARE YARD SYMMETRICAL TOP AND BOTTOM THICK TRENCH DRAIN TRANSVERSE TYPICAL UNDERGROUND ELECTRIC VALVE BOX WITH WATERLINE
EQ ES EW (E)/EXIST	EQUAL EXISTING STRUCTURE			W W/	WITH
F FD FF FH	FLOOR DRAIN FINISHED FLOOR FIRE HYDRANT, FLAT HEAD			XFMR	TRANSFORMER

CIVIL LEGEND

EXISTING	THIS PROJECT	
——— F0 ^u ———		BURIED FUEL LINE
——— Е й ———		ELECTRICAL (UNDERGROUND)
w _x	—— w ——	WATER
ss _x	—— ss ——	GRAVITY SANITARY SEWER
ROW		RIGHT-OF-WAY
c _n		COMMUNICATION (CABLE/TEL)
so x		STORM DRAIN
FM _x	—— ғм ——	FORCE MAIN SANITARY SEWER
xx		FENCE
(42)		SURVEY CONTROL
,O _{UP}		UTILITY POLE
ď	寒	FIRE HYDRANT
,		LIGHT POLE
SDMH		GRINDER PUMP STATION
SDMH		STORM DRAIN MANHOLE
		STORM DRAIN INLET
AMIMO.		SIGN
		TREE/VEGETATION
\bowtie	H	WATER VALVE
		GUARDRAIL

SURVEY CONTROL

SURVEY CONTROL									
POINT #	NORTHING	EASTING	ELEV. (FT)	DESCRIPTION					
42	510492.220	485365.881	24.67	PK NAIL W/FLASHER					
416	510963.679	484704.175	_	B.C. MONUMENT					
523	511109.967	485541.616	58.51	AKDOT AL. CAP					

SURVEY NOTES

- VERTICAL DATUM IS MEAN LOWER LOW WATER (MLLW = 0.00').
- 2. BASIS OF VERTICAL DATUM FOR THIS PROJECT IS CONTROL POINT 523 WITH A MEAN LOWER LOW WATER ELEVATION OF
- 3. THE HORIZONTAL CONTROL FOR THIS PROJECT IS BASED ON THE DOT/PF 2000 JUNEAU GRID. THE DOT/PF JUNEAU GRID IS A LOCAL GROUND SYSTEM BASED AT USC&GS FIRST ORDER CONTROL STATION "EDDIE". IT RELATES TO AKSPC ZONE 1 NAD83 THROUGH THE FOLLOWING PARAMETERS:

ZONE = NAD83 AKSPC ZONE 1 GRID SCALE = 0.999928875 $CONVERGENCE = -0^{\circ}45'27.26"$ TRANSLATION ABOUT USC&GS POINT

AS FOLLOWS:

AKSPC NORTHING = 2383469.17310 FT US AKSPC EASTING = 2512570.06318 FT US LOCAL NORTHING = 500000.0000 FT US LOCAL EASTING = 500000.0000 FT US

- 4. FIELD SURVEYS PERFORMED 2010, 2011, 2012, 2014 AND 2016 BY PND & OTHERS.
- 5. PROPERTY LINES AND EASEMENTS ARE DERIVED FROM RECORD PLATS.
- 6. BATHYMETRIC SURVEY PERFORMED BY PND 2010 AND 2016.

LAYOUT TABLES

STORM DRAIN PIPING								
PIPE DESIGNATION	NOMINAL Ø	LENGTH	FROM	ΙE	то	IE		
P1	6" PVC	38'	*BLDG	21.17	ES	19.65		
P2	6" PVC	6'	*BLDG	21.17	WYE	20.77		
P3	6" PVC	51'	TD	21.54	ES	19.50		

*COORDINATE WITH MECHANICAL FOR CONNECTION TO UTILITES AT BUILDING FOUNDATION.

WATER SYSTEM LAYOUT								
POINT	DESCRIPTION							
W1	510800.52	485285.73	CTE / 30° ELBOW					
W2	510778.90	485302.97	45° ELBOW					
W3	510766.62	485301.58	45° ELBOW					
W4	510737.48	485264.99	6x6x2 TEE					
W5	510735.20	485262.13	VALVE — CBJ STD. DTL. 407					
W6	510733.69	485260.25	FIRE HYDRANT - CBJ STD. DTL. 403					
W7	510735.61	485266.48	VALVE - CBJ STD. DTL. 407					
W8	510732.69	485268.80	45° ELBOW					
W9	510719.56	485267.31	45° ELBOW					


SANITARY SEWER SYSTEM LAYOUT				
POINT	NORTHING	EASTING	ELEVATION	DESCRIPTION
SS1	510809.85	485289.42	_	CTE / 30° ELBOW
SS2	510803.68	485294.36	-	45° ELBOW
SS3	510781.53	485291.84	-	45° ELBOW
SS4	510724.18	485219.87	SEE C105	GRINDER PUMP STATIO
SS5	510715.12	485227.06	IE = 19.63'	WYE / CLEANOUT
SS6	510711.82	485256.15	IE = 20.10'	WYE / CLEANOUT

BUILDING FOUNDATION LAYOUT				
GRID	NORTHING	EASTING	ELEVATION	DESCRIPTION
A1	510716.69	485271.44	25.05'	FOUNDATION CORNER
A7	510653.92	485321.43	25.05'	FOUNDATION CORNER



SURVEY CONTROL

NOTE: NOT ALL HARBOR FLOATS AND CURRENT SITE FEATURES SHOWN.

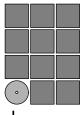

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0360 GLACIER HIGHWAY, SUITE 100 JUNEAU, AK 99801 907-586-2093 C.A.N. # AECC250 PND PROJECT #182069





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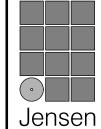
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FILE:

SHEET TITLE LEGEND, GENERAL NOTES, ABBREVIATIONS, LAYOUT TABLES, SURVEY CONTROL DATE: SEPTEMBER 29, 2022





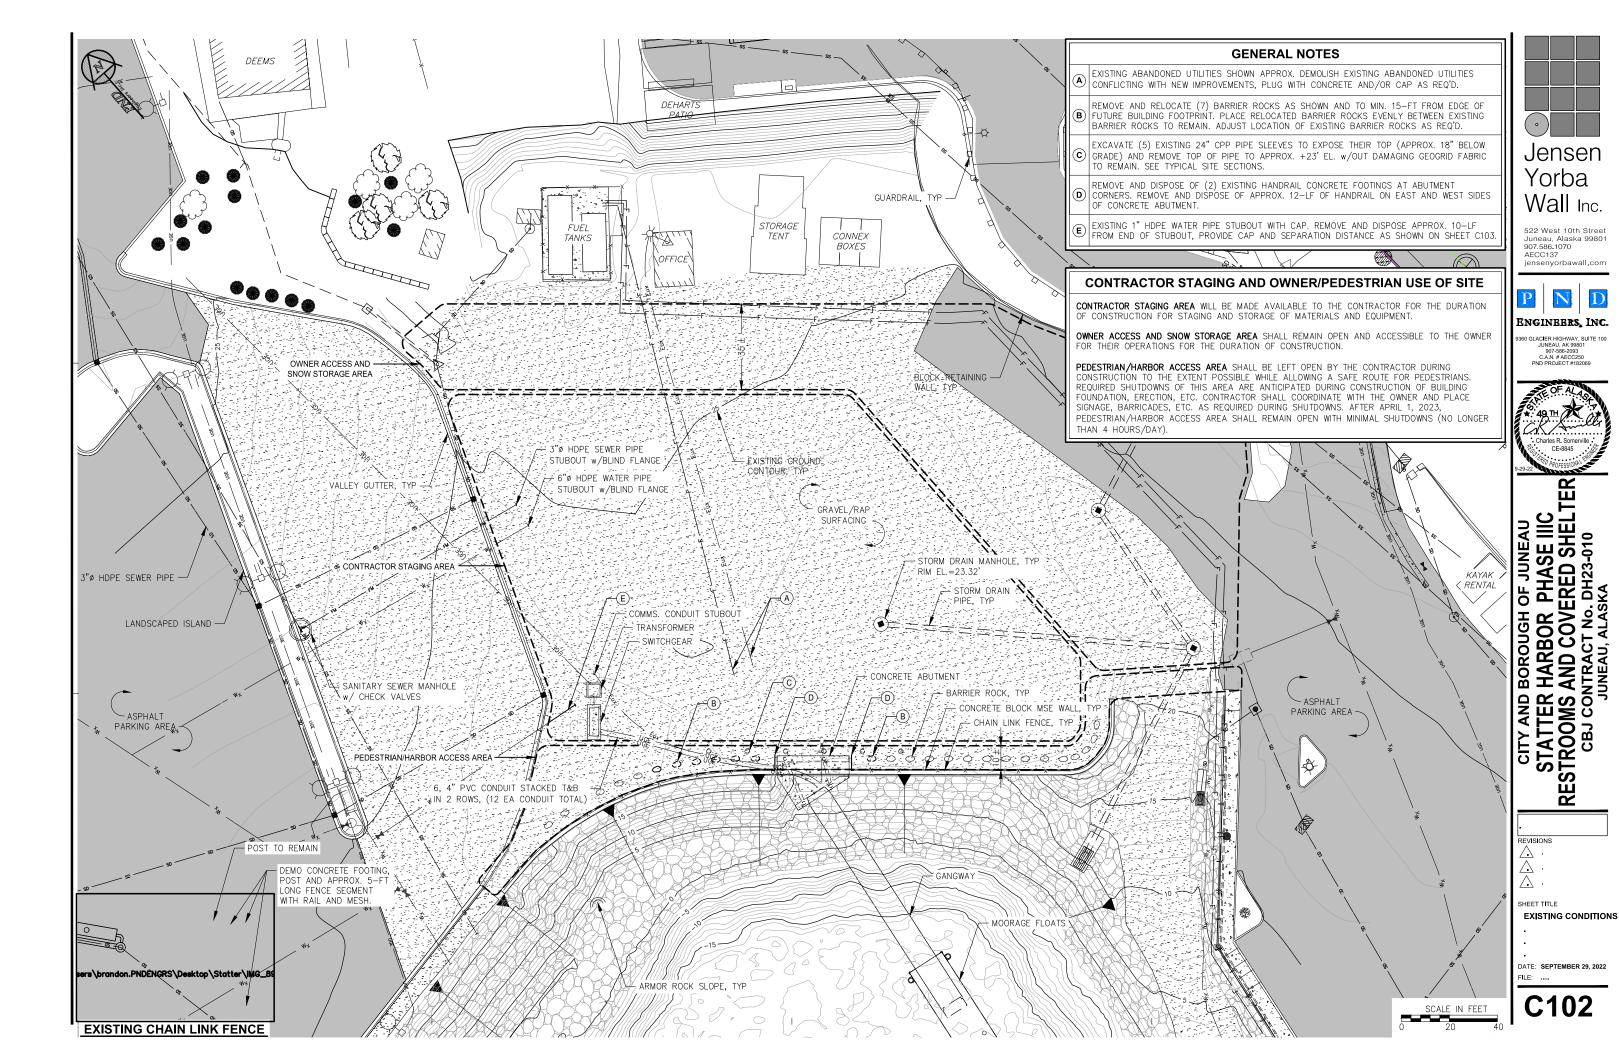
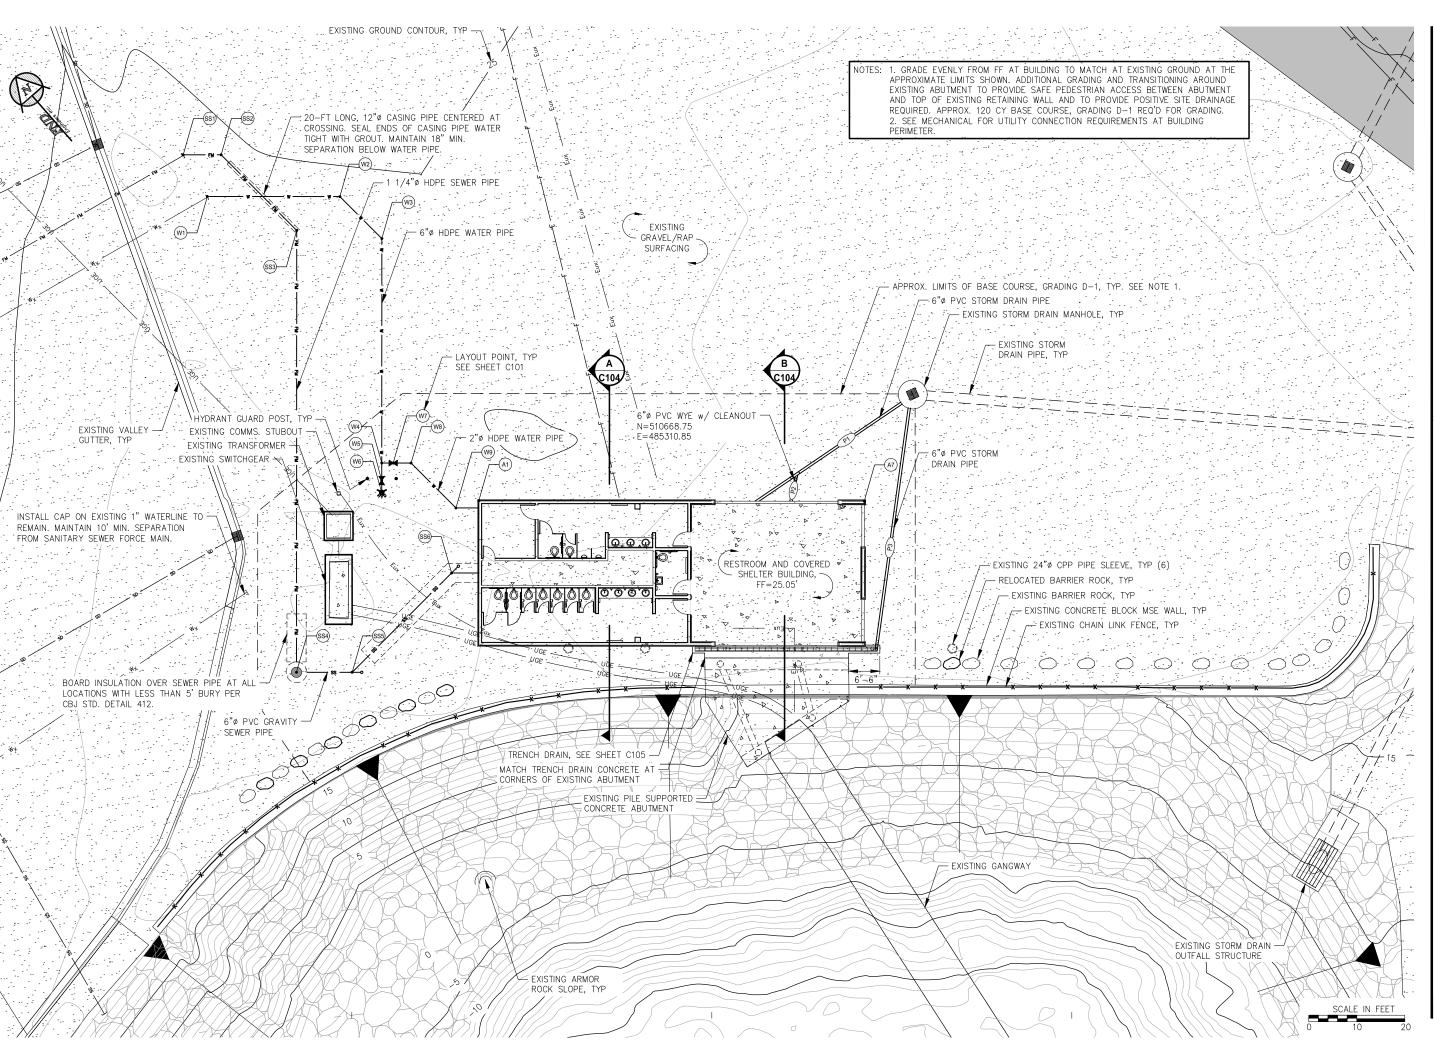
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ENGINEERS, INC.

360 GLACIER HIGHWAY, SUITE 100 JUNEAU, AK 99801 907-586-2093 C.A.N. # AECC250 PND PROJECT #182069





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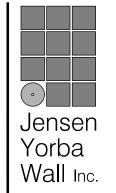
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SHEET TITLE **GENERAL SITE PLAN**

DATE: SEPTEMBER 29, 2022





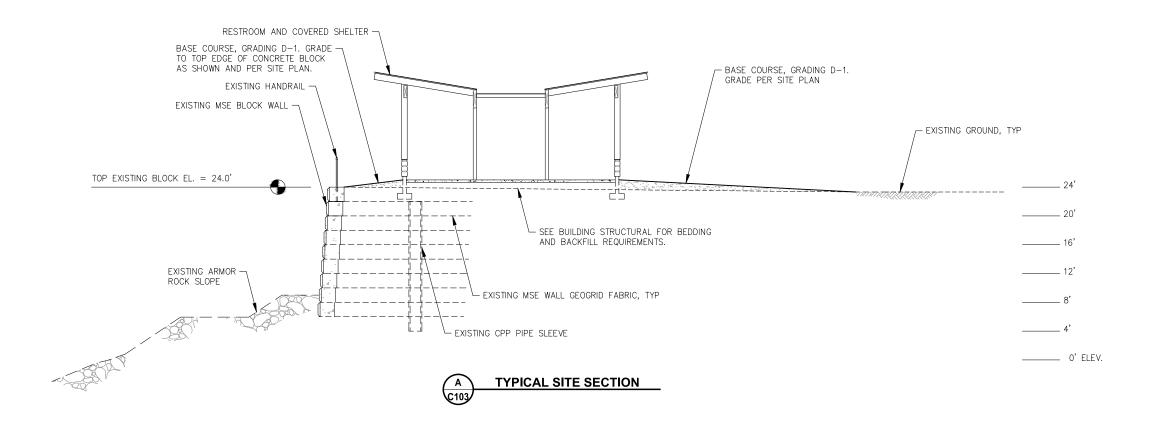
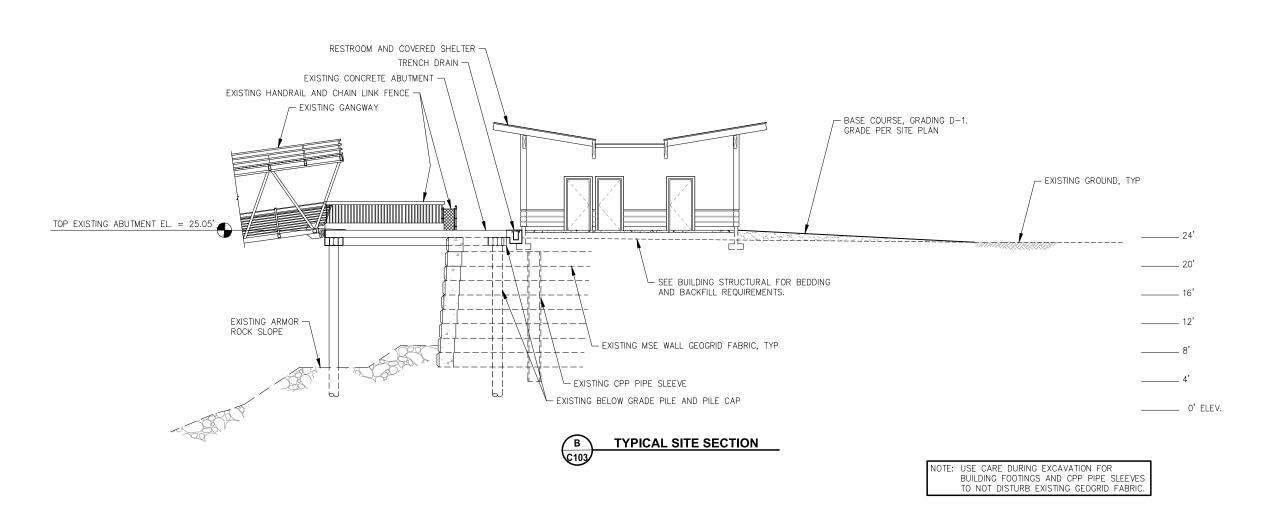
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0360 GLACIER HIGHWAY, SUITE 100 JUNEAU, AK 99801 907-586-2093 C.A.N. # AECC250 PND PROJECT #182069



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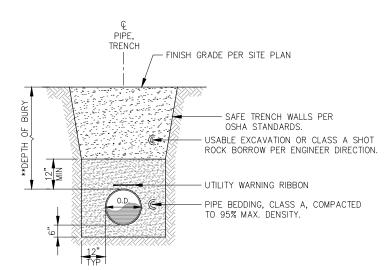
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SHEET TITLE
SITE SECTIONS

DATE: SEPTEMBER 29, 2022


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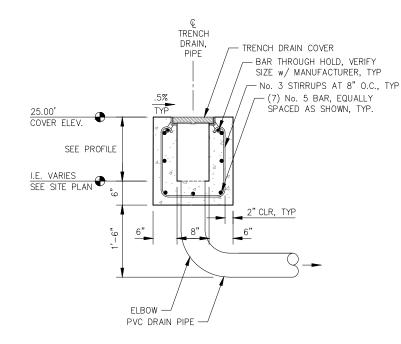
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PIPE TRENCH - TYPICAL SECTION

**NOTE: 5' MIN. WATER AND SEWER FORCE MAIN. STORM DRAIN AND GRAVITY SEWER VARIES PER SITE PLAN.






TRENCH DRAIN - TYPICAL SECTION

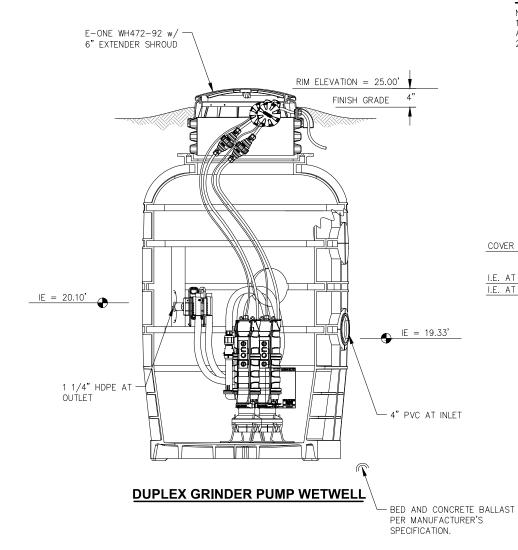
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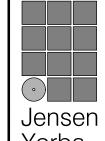
1. TRENCH DRAIN COVER SHALL BE EJIW V-7382-20 ADA BOLTED ASSEMBLY, OR APPROVED EQUAL, HOT-DIPPED GALVANIZED.

2. CAST 6" SCH. 40 PVC DRAIN PIPE INTO CONCRETE.

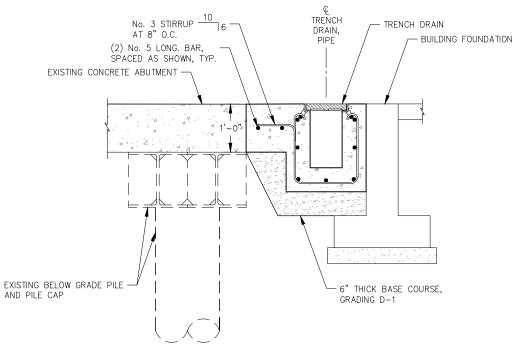

TRENCH DRAIN AT ABUTMENT



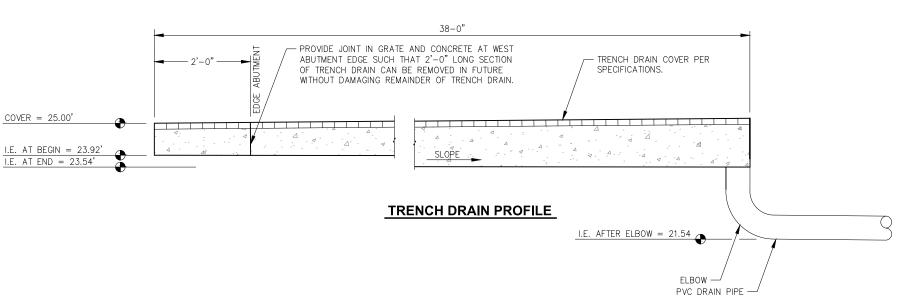

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STAT STAT RESTROC CB.

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STRUCTURAL GENERAL NOTES

STRUCTURAL GENERAL NOTES

CRITERIA

2012 EDITION OF INTERNATIONAL BUILDING CODE (IBC) AS AMENDED BY THE STATE OF ALASKA CODE:

STRUCTURAL RISK CATEGORY: II

GROUND SNOW LOAD: 70 PSE

THERMAL COEFFICIENT Ct = 1.2, (UNHEATED ROOF) EXPOSURE COEFFICIENT, Ce = 0.8 (TERRAIN CATEGORY D, FULLY EXPOSED)
IMPORTANCE, Is = 1.0 (OCCUPANCY CATEGORY II)

FLAT ROOF SNOW LOAD: 50 PSF

LIVE LOADS

SLAB ON GRADE LIVE LOAD 100 PSF

WIND LOADS:

ULTIMATE WIND SPEED: 127 MPH

EXPOSURE: D; AVERAGE ROOF HEIGHT < 15 FEET; Kz = 1.03 Kzt = 1.0; Kd = 0.85 ULTIMATE STATIC PRESSURE, qu = 38.5 PSF

SEISMIC LOADS

SITE CLASS: D:

Sds = 0.55 g; Sd1 = 0.43 g

DESIGN CATEGORY D; IMPORTANCE = 1.0

R = 6.5 (LIGHT FRAMED WOOD WALLS SHEATHED WITH WOOD PANELS)

FOUNDATION:
FOUNDATION HAS BEEN DESIGNED WITH AN ALLOWABLE BEARING PRESSURE OF 2,000 PSF BASED UPON THE ANTICIPATION OF ENCOUNTERING SANDS AT LIMIT OF FOUNDATION

STRUCTURAL MATERIALS AND CONSTRUCTION

BASE COURSE
BASE COURSE SHALL CONFORM TO GRADATION LISTED IN THE SPECIFICATIONS. PLACE AND COMPACT PER SPECIFICATIONS

CONCRETE
MIXING, PLACING, AND CURING OF CONCRETE AND SELECTION OF MATERIALS SHALL BE IN ACCORDANCE WITH THE IBC. PROPORTIONS OF AGGREGATE, CEMENT AND WATER SHALL BE SUCH TO RESULT IN A DENSE WORKARI E MIX WHICH CAN BE PLACED WITHOUT EXCESS SURFACE WATER. A MIX DESIGN WITH RECORDED CYLINDER TEST RESULTS SHALL BE SUBMITTED FOR REVIEW AND APPROVAL PRIOR TO MOBILIZING CONCRETE EQUIPMENT TO THE SITE. MAXIMUM SLUMP SHALL BE 4 INCHES PRIOR TO ADDING PLASTICISERS OR WATER REDUCERS ON SITE 28-DAY COMPRESSIVE STRENGTH (fc') SHALL BE 4 000 PSL CONCRETE SHALL BE ENTRAINED WITH AIR SO THAT AIR CONTENT WILL BE BETWEEN 5 AND 8 PERCENT. SLABS AND CURB FACES SHALL BE SEALED WITH A PENETRATING LIQUID SEALER, ASHFORD FORMULA OR APPROVED EQUAL

CONCRETE REINFORCING SHALL COMPLY WITH ASTM A615 GRADE 60. LAP REINFORCING STEEL 50 BAR DIAMETERS UNLESS OTHERWISE NOTED. AT CORNERS ADD CORNER BARS AT EACH HORIZONTAL BAR WITH LEG LENGTH AT LEAST 50 DIAMETER LAP LENGTH OR EXTEND THE HORIZONTAL BARS IN ONE WALL WITH A 90 DEGREE HOOK WITH A 50 DIAMETER LAP LENGTH

REINFORCING SHALL BE SUPPORTED AND SECURED IN PLACE PRIOR TO CONCRETE PLACEMENT USING WELL-CURED CONCRETE BLOCKS OR APPROVED STEEL CHAIRS. WELDING OF REINFORCING IS PROHIBITED UNLESS SPECIFICALLY NOTED.

PROVIDE MINIMUM COVER AT REINFORCING BARS AS FOLLOWS: CAST AGAINST EARTH 3 INCHES, EXPOSED TO EARTH OR WEATHER 2 INCHES AND SLABS ON GRADE 1.5 INCHES

SHEATHING SHALL BE PLYWOOD AND SHALL CONFORM WITH APA PS 1, EXPOSURE 1 SHEATHING GRADE CD OR OF A BETTER GRADE

<u>TIMBER FRAMING</u>
SPECIES AND GRADES: UNLESS NOTED OTHERWISE, ALL TIMBER 2 TO 4 INCHES THICK SHALL BE DOUGLAS FIR NO 2 GRADE, TIMBER 5 INCHES AND GREATER IN THICKNESS SHALL BE DOUGLAS FIR NO 1 GRADE OR OF A BETTER SPECIES AND GRADE, VISUALLY GRADED IN ACCORDANCE WITH THE WESTERN WOODS PRODUCTS ASSOCIATION, LATEST GRADING RULES. ALL SAWN FRAMING SHALL BE STAMPED WITH LUMBER

TIMBER SHALL BE FABRICATED AND JOINED TO CREATE SNUG TIGHT CONNECTIONS UNLESS NOTED OTHERWISE. BOLTS SHALL CONFORM TO ASTM A307 AND BE GALVANIZED. HOLES FOR BOLTS SHALL BE NO GREATER THAN THE BOLT DIAMETER PLUS 1/8 INCH. ALL BOLTS WITH HEAD OR NUT IN CONTACT WITH TIMBER SHALL BE INSTALLED WITH GALVANIZED WASHERS UNDER THE HEAD AND NUTS. ALL NAILED CONNECTIONS SHALL BE CONNECTED USING GALVANIZED BOX NAILS.

PRE-FABRICATED HANGERS AND CONNECTORS NOTED IN THE PLANS ARE THE PRODUCT OF THE SIMPSON STRONG-TIE COMPANY. HANGERS AND CONNECTORS MADE BY OTHER MANUFACTURERS MAY BE CONSIDERED FOR SUBSTITUTION IF THE HANGER OR CONNECTOR HAS EQUAL OR GREATER LOAD CAPACITY, EQUAL OR GREATER CORROSION RESISTANCE AND BE OF AN APPROPRIATE EQUAL CONFIGURATION. SUBMIT ICBO ER FOR REVIEW AND APPROVAL WITH ANY REQUEST FOR SUBSTITUTION

TIMBER AND LUMBER NOTED AS TREATED SHALL BE PRESSURE PRESERVATIVE TREATED IN ACCORDANCE WITH AWPA UC3B FOR IN GROUND CONTACT USING A PRESERVATIVE APPROVED BY THE ENGINEER. FIELD TREAT ALL DAMAGE TO PRESSURE TREATED ENDS AND SURFACES IN ACCORDANCE WITH AWPA M-4 USING 2 COATS OF COPPER NAPTHANATE SOLUTION AT DAMAGE, CUTS, HOLES, CHAMFERS, DAPS,

TIMBER DECKING SHALL BE TONGUE AND GROOVE, DOUGLAS FIR SELECT DECKING MATERIAL THAT MEETS AITC 112. PROTECT PRIOR TO INSTALLATION. INSTALL ON SLOPES WITH TONGUES UP. FACE NAIL EACH PIECE AT SUPPORTS WITH 16D GALVANIZED COMMON NAIL AND TOE NAIL THROUGH TONGUE AT SUPPORT

GLUED LAMINATED TIMBER BEAMS
GLUED LAMINATED TIMBER BEAMS SHALL BE MADE OF DOUGLAS FIR AND BE COMBINATION 24F-V4.

HANDLE AND STORE IN ACCORDANCE WITH MANUFACTURER'S INSTRUCTIONS

SPECIAL INSPECTIONS
REQUIRED SPECIAL INSPECTION FOR THIS PROJECT INCLUDES THE FOLLOWING:

- CONCRETE REINFORCING; VERIFICATION OF BAR SIZE, SPACING, COVER, AND ORIENTATION PRIOR TO PLACING CONCRETE
- CONCRETE: CONCRETE SHALL BE SAMPLED FOR STRENGTH TESTING, TESTED FOR AIR CONTENT AND BE SUBJECT TO SLUMP TEST. EACH DAY OF PLACEMENT GREATER THAN 5 CUBIC YARDS.
- CONCRETE CONSOLIDATION AND CONCRETE CURING
- ANCHOR BOLTS IN CONCRETE: VERIFICATION OF DEPTH OF EMBEDMENT, SPACING AND SIZE. IF POST INSTALLED RODS VERIFICATION OF SIZE, EMBEDMENT, TEMPERATURE, AND HOLE CLEANING
- PLYWOOD SHEAR WALL NAILING. VERIFICATION OF NAIL SIZE AND SPACING
- PLYWOOD DIAPHRAGM NAILING. VERIFICATION OF NAIL SIZE AND SPACING

ABBREVIATIONS

AMERICAN CONCRETE INSTITUTE

AMERICAN INSTITUTE OF TIMBER CONSTRUCTION

AMERICAN PLYWOOD ASSOCIATION ASCE AMERICAN SOCIETY OF CIVIL ENGINEERS

AMERICAN SOCIETY FOR TESTING AND MATERIALS

AWPA AMERICAN WOOD PRESERVERS ASSOCIATION

GRADE BREAK

GB IBC ICBO MAX INTERNATIONAL BUILDING CODE

INTERNATIONAL CONFERENCE OF BUILDING OFFICIALS


NO NUMBER

ON CENTER PRODUCT STANDARD

OC PS PSF PSI STD POUNDS PER SQUARE FOOT POUNDS PER SQUARE INCH


STANDARD

TYP UNO TYPICAL UNLESS NOTED OTHERWISE

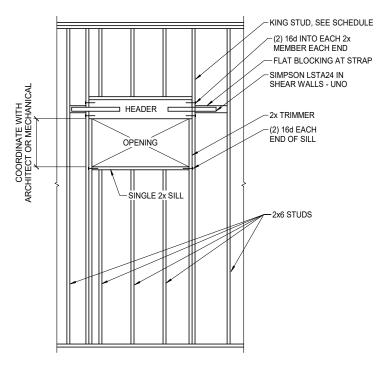

TYPICAL HEADER DETAIL

HEADER SCHEDULE			
MARK	HEADER SIZE	KING STUDS	
H1	(2) 2x6	(1) KING STUD EACH SIDE	
H2	(3) 2x6	(2) KING STUDS EACH SIDE	

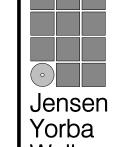

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JUNEAU, AK 9980 907-586-2093 C.A.N. # AECC250 PND PROJECT #1820





Ш 四月日の UGH OF JUN 3OR PHASE 3OVERED S 3R No. DH2 ALASKA AND BOROUG TTER HARBO OMS AND CO ONTRACTOR JUNEAU, A

REVISIONS

SHEET TITLE **GENERAL NOTES**

DATE: SEPTEMBER 29, 2022

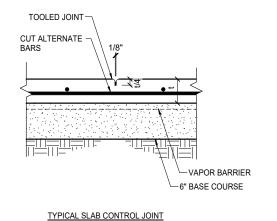

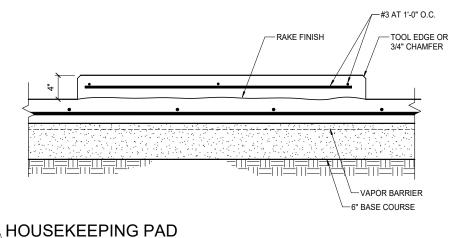

SLAB DETAIL

EDGE NAILING IN-TOP PLATES UPPER TOP PLATE PLYWOOD EDGE NAILING, SEE PLAN. 8d @ 6" O.C. MAX. SPACE ALL PLYWOOD EDGES -2x4 FLAT BLOCKING BETWEEN MUST BE SUPPORTED BY FRAMING AT ALL ABUTTING EDGES AND NAILED TO FRAMING STUD WALL, SEE PLAN OR SCHEDULE OR BLOCKING. I FOR SIZE AND SPACING PLYWOOD FIELD NAILING 8d PLYWOOD SHEATHING, (15/32" TYPICAL) SEE SCHEDULE FOR ATTACHMENT OF BOTTOM PLATE TO FLOOR, SEE SECTIONS

** NAILING TO BE 8d @ 6" O.C. MAX. UNLESS OTHERWISE SHOWN ON PLANS, SECTIONS, DETAILS, OR SCHEDULES.


- ES.
 PLYWOOD IS SHOWN HORIZONTAL, IT MAY ALSO BE POSITIONED VERTICAL.
 STAGGER PLYWOOD JOINTS A MINIMUM OF TWO STUD SPACES.
- NAILS AT ABUTTING PLYWOOD EDGES MUST PENETRATE THE SAME PIECE OF FRAMING OR BLOCKING.
- SEE TYPICAL WALL ELEVATIONS AND PLANS FOR HOLD DOWNS, STRAPS AND ADDITIONAL BLOCKING.

(2)	TYPICAL	SHEAR	WALL	DETAIL


BEARING WALL SCHEDULE STUD & SPACING MARK (2) 2x6 AT 1'-4" O.C. 2x6 AT 1'-4" O.C.

	SHEAR WALL SCHEDULE				
MARK	SHEATHING	PANEL EDGE NAILING	ANCHOR BOLT SPACING		
1>	15/32" CDX	8d AT 6	5/8"Ø AT 2'-8"*		
2>	15/32" CDX	8d AT 4	5/8"Ø AT 1'-4"*		


*10" MINIMUM EMBEDMENT

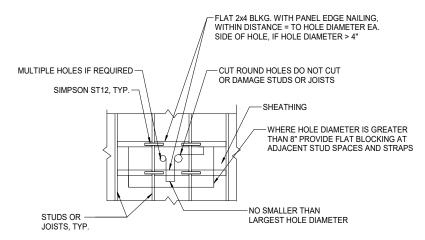

TYPICAL SHEAR WALL AND DIAPHRAGM PENETRATION DETAIL

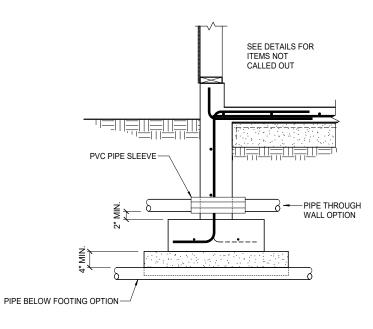

TYPICAL PIPE PENETRATION AT EXTERIOR FOUNDATION WALL AND 5 FOOTING

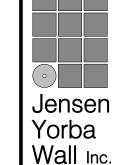

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ENGINEERS, INC. GLACIER HIGHWAY, SU JUNEAU, AK 99801 907-586-2093 C.A.N. # AECC250 PND PROJECT #18206




SHEET TITLE

FOUNDATION PLAN

- 1. # INDICATES BEARING WALL TYPE. SEE BEARING WALL SCHEDULE
- 2. #> INDICATES SHEAR WALL TYPE. SEE TYPICAL DETAIL AND SHEAR WALL SCHEDULE
- 3. AT HDU4 USE 5/8"Ø ROD, EMBED 1'-2" IN CONCRETE.
- 4. AT HDU5 USE 5/8"Ø ROD, EMBED 1'-6" IN CONCRETE.



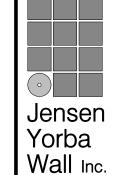

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SHEET TITLE

1ST FLOOR FRAMING PLAN


DATE: SEPTEMBER 29, 2022

(5)

5' - 0"

80' - 3"

7' - 3"

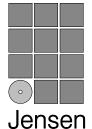

Yorba Wall Inc.

(7)

(6)

5' - 0"

26' - 6"

0 2 4 6

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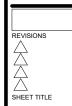
N

ENGINEERS, INC.

JUNEAU, AK 99801 907-586-2093 C.A.N. # AECC250 PND PROJECT #18206



ËR



ROOF FRAMING PLAN

DATE: SEPTEMBER 29, 2022

- 1. OFFSET POST CAP FROM & POST TO ALIGN FACE OF BEAM WITH FACE OF WALL.
- 2. 8d AT 12" FIELD NAILING OF PLYWOOD. PANELS SHALL BE IN ROWS 16 INCHES ON CENTER PARALLEL WITH SHORT EDGE OF PANEL.
- 3. H# INDICATES HEADER TYPE. SEE SCHEDULE AND TYPICAL DETAILS.




1/4" = 1'-0"


(2)


12' - 0"


24' - 6"


-5 1/8x10 1/2 GLB AT 7'-3" O.C. TYPICAL

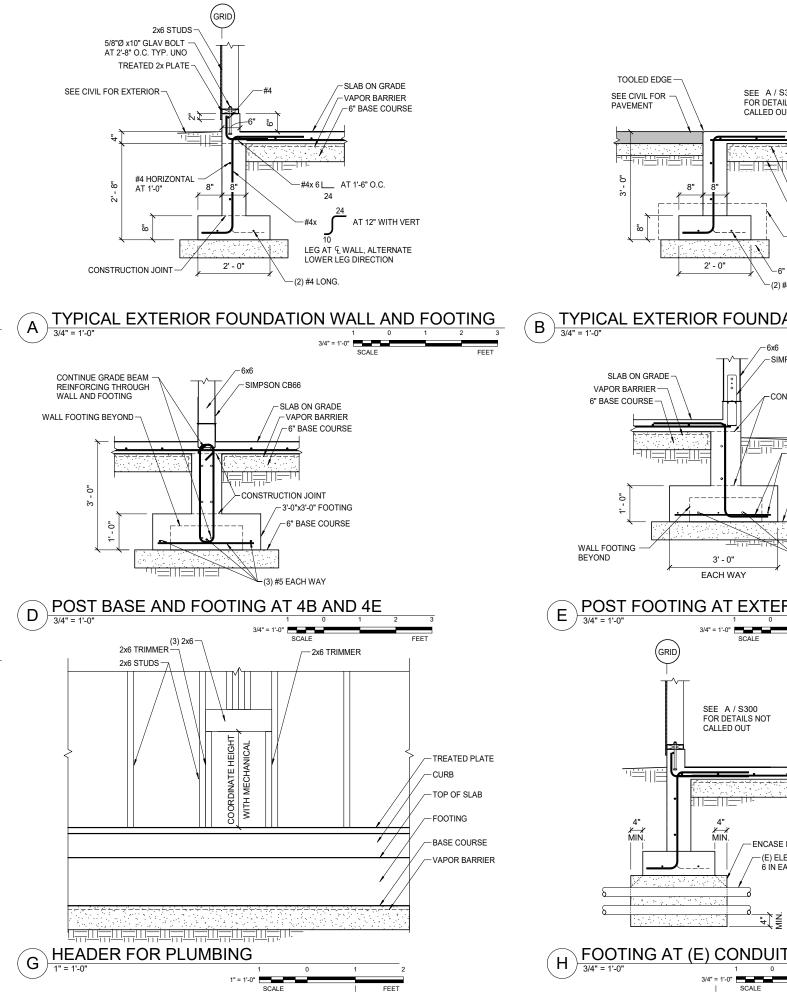


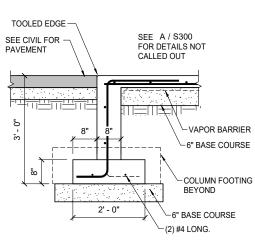


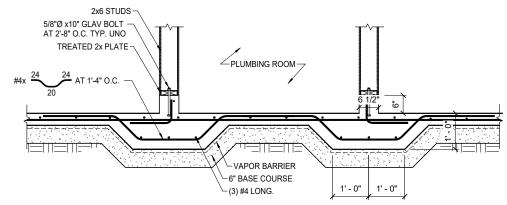


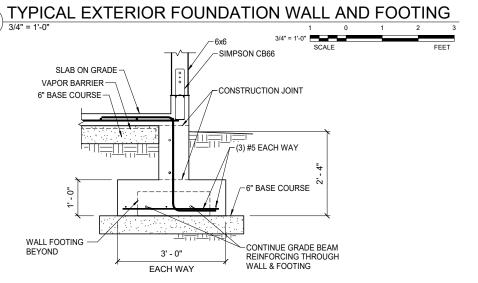

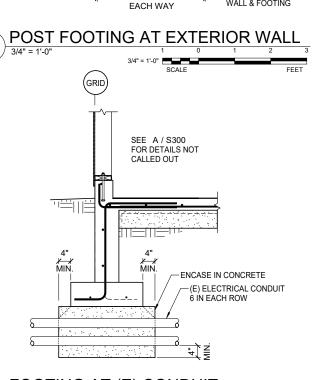

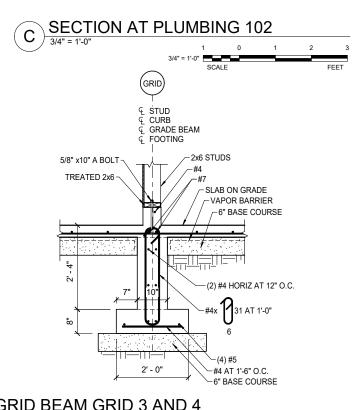

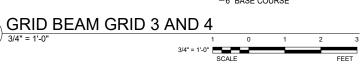

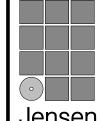


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N

ENGINEERS, INC JUNEAU, AK 99801 907-586-2093 C.A.N. # AECC250 PND PROJECT #18200

SHEET TITLE FOUNDATION DETAILS



WALL ELEVATION

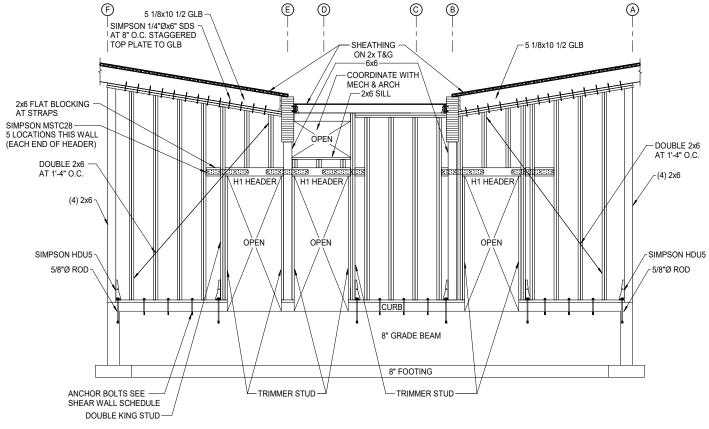

1 0 1 2 3 4 5 6 7 3/8" = 1'-0"

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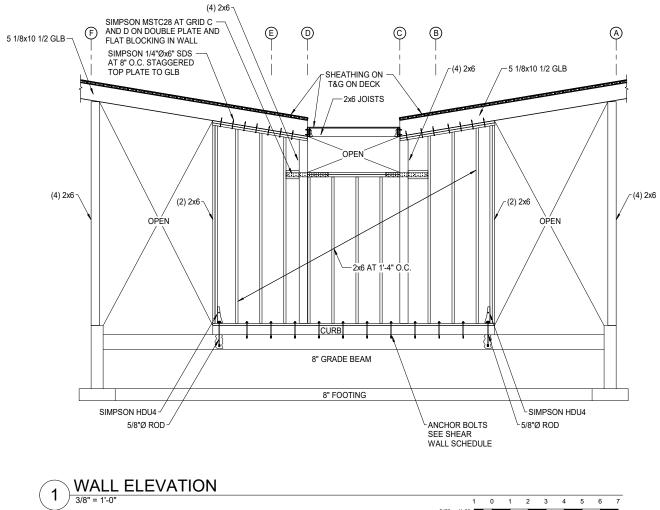
GLACIER HIGHWAY, SU JUNEAU, AK 99801 907-586-2093 C.A.N. # AECC250 PND PROJECT #182069

ND


Yorba

SHEET TITLE

WALL ELEVATIONS





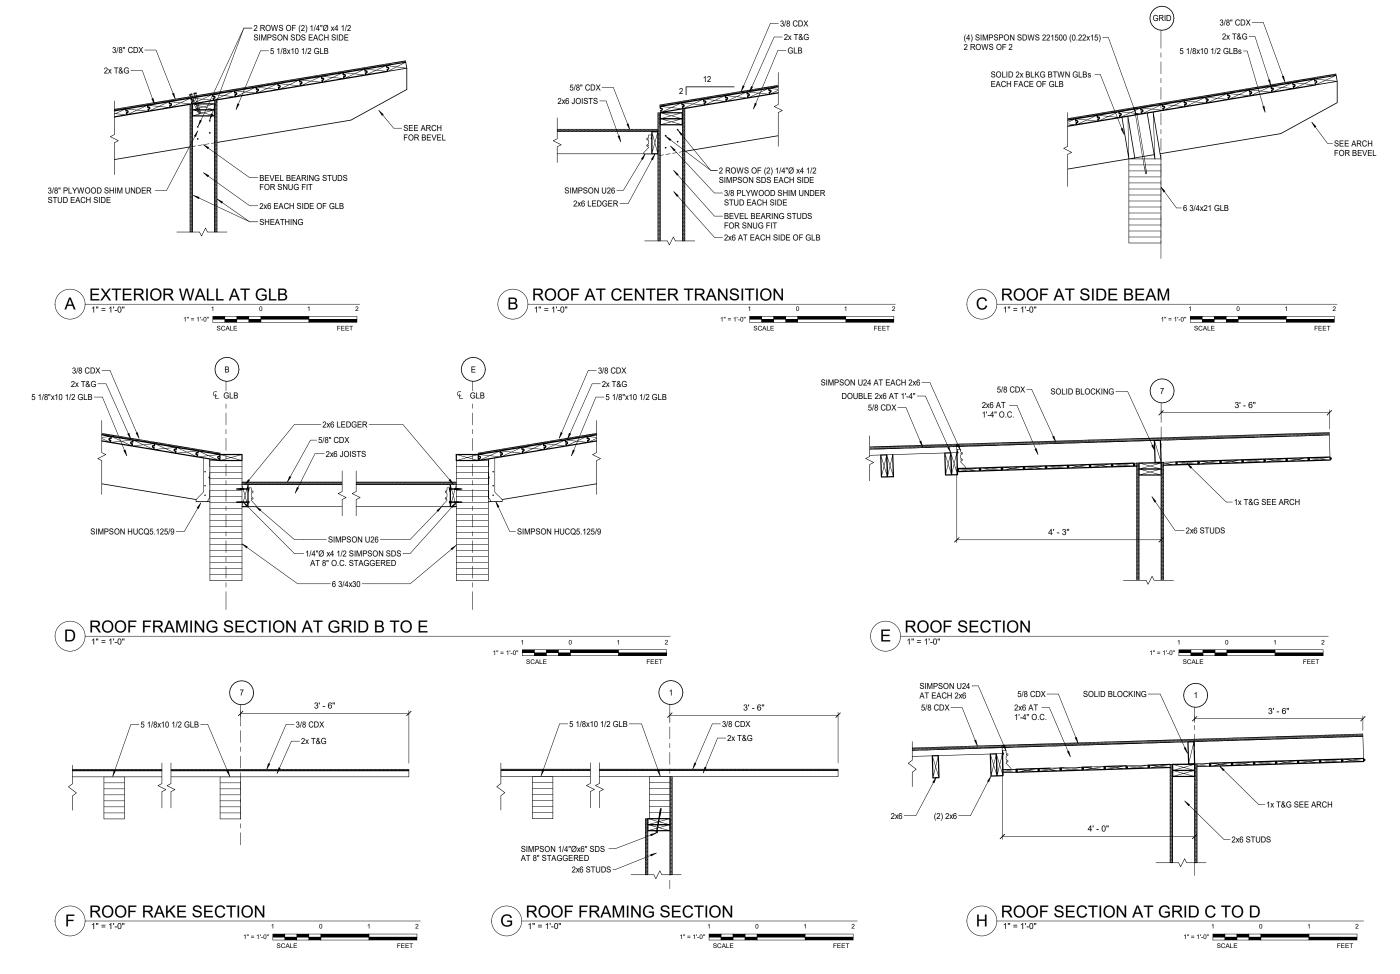

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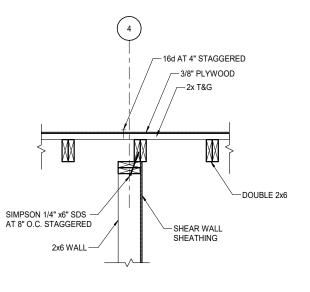
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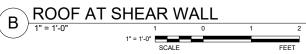
ENGINEERS, INC JUNEAU, AK 99801 907-586-2093 C.A.N. # AECC250 PND PROJECT #18200


SHEET TITLE **ROOF DETAILS**


DATE: SEPTEMBER 29, 2022







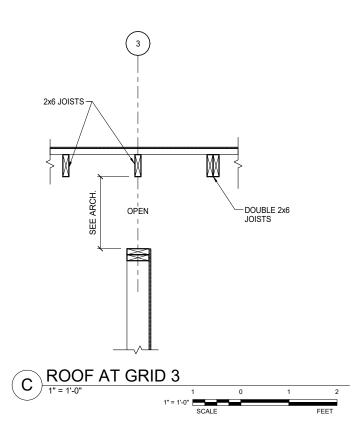

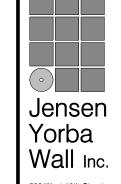

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9360 GLACIER HIGHWAY, SUITE 100 JUNEAU, AK 99801 907-586-2093 C.A.N. # AECC250 PND PROJECT #182069



HASE IIIC ED SHELTER DH23-010

STATTER HARBOR PHASE III STATTER HARBOR PHASE III STROOMS AND COVERED SHE CBJ CONTRACTOR NO. DH23-C

REVISIONS

SHEET TITLE

ROOF DETAILS

DATE: SEPTEMBER 29, 2022
FILE:

S303


GENERAL

PIPE FITTINGS & VALVES ELBOW, TURNED DOWN FLBOW, TURNED UP ——о TEE, OUTLET DOWN TEE, OUTLET UP FLOW DIRECTION CONCENTRIC REDUCER -0-ISOLATION VALVE BALL VALVE ____ PRESSURE REDUCING VALVE CHECK VALVE STRAINER STRAINER W/ BLOWDOWN PRESSURE TEMPERATURE TAP ("PETE'S PLUG") RELIEF OR SAFETY VALVE DRAIN ISOLATION VALVE AND HOSE ADAPTOR DRAIN ISOLATION VALVE AND CAP FLANGE CONNECTION PIPE ANCHOR PIPE GUIDE METER DOUBLE CHECK VALVE BACKFLOW PREVENTER REDUCED PRESSURE PRINCIPLE BACKFLOW PREVENTER THERMOMETER PRESSURE GAUGE W/

PUMP - CIRC

PUMP - INLINE

VENTILATION

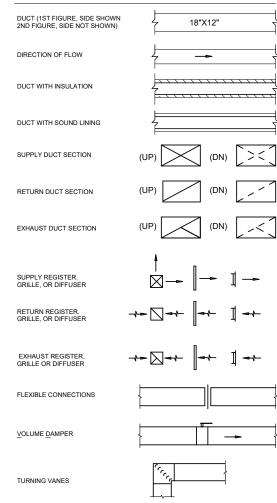


AIR TERMINAL LEGEND

PLAN	ELEVATION /SECTION	DESCRIPTION
	_	SUPPLY AIR GRILLE
		EXHAUST FAN GRILLE

ABBREVIATIONS

ACFM AFF	ACTUAL CUBIC FEET PER MINUTE ABOVE FINISHED FLOOR	MAX MBH	MAXIMUM THOUSAND BTU'S PER HOUR
AFF AHAP	AS HIGH AS POSSIBLE	MIN	MINIMUM
AHAP AHU	AIR HANDLING UNIT	MISC	MISCELLANEOUS
	APPROXIMATE		
APPROX AS	AIR SEPARATOR	NC NO	NORMALLY CLOSED NORMALLY OPEN
BDD	BACK DRAFT DAMPER	NO.	NUMBER
BTU	BRITISH THERMAL UNIT	OA OC	OUTSIDE AIR
CFM CIRC	CUBIC FEET PER MINUTE CIRCULATION	ORD	ON CENTER OVERFLOW ROOF DRAIN
	CELING	ORD	OVERFLOW ROOF DRAIN OVERFLOW RAIN LEADER
CLNG CONT	CONTINUATION, CONTINUED	OSA	OUTSIDE AIR SUPPLY
		P	
CP CU	CIRCULATING PUMP COPPER	PD PD	PUMP PRESSURE DROP
CW	COLD WATER	PDI PH	PLUMBING & DRAINAGE INSTITUTE
(D)	DEMOLISH	PSIG	PHASE
DIA DHWC	DIAMETER CIPC	PSIG	POUNDS PER SQUARE INCH GAUG
	DOMESTIC HOT WATER CIRC		POUNDS PER SQUARE INCH
DN	DOWN	RD	ROOF DRAIN
(E)	EXISTING	RL	RAINLEADER
EA	EXHAUST AIR	RPBP	REDUCED PRESSURE ZONE
EBB	ELECTRIC BASEBOARD		BACKFLOW PREVENTER
EF.	EXHAUST FAN	RWL	RAIN WATER LEADER
ENT	ENTERING	SA	SUPPLY AIR
ET	EXPANSION TANK	SCH	SCHEDULE
ESP	EXTERNAL STATIC PRESSURE	SQFT	SQUARE FEET
EUH	ELECTRIC UNIT HEATER	SS	STAINLESS STEEL
EWT	ENTERING WATER TEMPERATURE	TA	TRANSFER AIR
-co	FLOOR CLEANOUT	TEMP	TEMPERATURE
-D	FLOOR DRAIN	TDH	TOTAL DEVELOPED HEAD
-T	FEET	TP	TRAP PRIMER
-T	FINNED TUBE	TYP	TYPICAL
GAL	GALLONS	UL	UNDERWRITER'S LABORATORY
GALV	GALVANIZED	UON	UNLESS OTHERWISE NOTED
SPM	GALLONS PER MINUTE	UH	UNIT HEATER
HB	HOSE BIBB	VTR	VENT THROUGH ROOF
HP.	HORSE POWER	VR	VENT RISER
-IW	HOT WATER	W	WASTE
HWC	HOT WATER CIRCULATION	W/	WITH
HWRP	HOT WATER RECIRCULATION PUMP	W.C.	WATER COLUMN
HWT	HOT WATER TANK	wco	WALL CLEANOUT
HZ.	HERTZ	WH	WATER HEATER
D	INSIDE DIAMETER	WHA	WATER HAMMER ARRESTOR
N	INCHES	WPD	WATER PRESSURE DROP
_AV	LAVATORY	WRT	WITH RESPECT TO
LF	LINEAL FEET		
LVG LWT	LEAVING		
	LEAVING WATER TEMPERATURE		

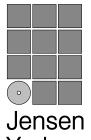

Yorba

522 West 10th Street





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STATTER HARBOR PHASE IIIC
STATTER HARBOR PHASE IIIC
RESTROOMS AND COVERED SHELTER
CBJ CONTRACT No. DH23-010
JUNEAU, ALAKSA

REVISIONS SHEET TITLE

LEGENDS AND ABBREVIATIONS

DATE: SEPTEMBER 29, 2022 FILE: 10722.22004

							PLUMBING FIXTURE SCH	EDULE
MARK	FIXTURE DESCRIPTION	HW/TW	CW	TRAP	WASTE	VENT	BASIS OF DESIGN	COMMENTS
FCO	FLOOR CLEANOUT	-	-	-	4"	-	ZURN Z1400-BZ	304 SS TOP. ANCHOR FLANGE. ACID RESISTANT EPOXY COATED FINISH.
FD-1	INTERIOR FLOOR DRAIN	-	-	2"	2"	1-1/2"	ZURN Z1726-K-Y-VP-P	PROVIDE AUTOMATIC TRAP PRIMER CONNECTION, ANCHOR FLANGE, STAINLESS STEEL SEDIMENT BUCKET, VANDAL-PROOF SECURED TOP
FD-2	EXTERIOR FLOOR DRAIN	-	-	-	3"	-	ZURN Z1726-K-Y-VP-P	ANCHOR FLANGE, STAINLESS STEEL SEDIMENT BUCKET, VANDAL-PROOF SECURED TOP.
HB-1	RECESSED WASHDOWN HOSE BIB	3/4"	3/4"	-	-	-	WOODFORD MB224	MOUNT RECESSED IN WALL, LOCKABLE COVER
L-1	LAVATORY	1/2"	1/2"	1-1/4"	1-1/2"	1-1/2"	BY ARCHITECT	PROVIDE ALL TRIM REQUIRED
L-2	LAVATORY	1/2"	1/2"	1-1/4"	1-1/2"	1-1/2"	BY ARCHITECT	PROVIDE ALL TRIM REQUIRED
L-3	LAVATORY	1/2"	1/2"	1-1/4"	1-1/2"	1-1/2"	MANSFIELD GRAND ISLAE 2018HBNS-4	PROVIDE ASSE-1070 HW TEMPERING VLAVE AND MOEN #CA8301 HARD-WIRED INFRARED ACTUATED FAUCET, INSULATED WATER AND WASTE
ORD-1	OVERFLOW ROOF DRAIN	-	-	3"	3"	-	ZURN Z100	DURA-COATED CAST IRON BODY. POLY DOME STRAINER. 2" OVERFLOW DAM.
RD-1	ROOF DRAIN	-	-	3"	3"	-	ZURN Z100	DURA-COATED CAST IRON BODY. POLY DOME STRAINER.
SS-1	SERVICE SINK	1/2"	1/2"	3"	3"	2"	MUSTEE 63M	FLOOR MOUNTED STRUCTURAL FIBERGLASS BODY.WALL BRACED SERVICE FAUCET WITH EXTENSION AND HOLDER. WALL AND BUMPER GUARDS.
TP-1	TRAP PRIMER	-	1/2"	-	1/2"	-	WATTS LFTP300T	THREADED CONNECTION. 4-PORT DISTRIBUTION UNIT.
UR-1	URINAL	-	3/4"	-	3"	1-1/2"	MANSFIELD 410-HE-RS	PROVIDE WALL CLEANOUT ON VENT PIPE ABOVE URINAL. PROVIDE SLOAN ROYAL #195 ESS-0.5-DFB-2-10-3/4-LDIM-HW CONCEALED FLUSH VALVE
UR-2	ADA URINAL	-	3/4"	-	3"	1-1/2"	MANSFIELD 410-HE-RS	PROVIDE WALL CLEANOUT ON VENT PIPE ABOVE URINAL. MOUNT WITH RIM 17" ABOVE FINISHED FLOOR. PROVIDE SLOAN ROYAL #195 ESS-0.5-DFB-2-10-3/4-LDIM-HW CONCEALED FLUSH VALVE
WC-1	WATER CLOSET	1"	-	-	4"	2"	MANSFIELD #1301	PROVIDE SLOAN ROYAL ESS-1.6-OR-2-10-3/4-LDIM-HW HARD-WIRED SENSOR OPERATED CONCEALED FLUSH VALVE. BEMIS #1955SSCT OPEN FRONT TOILET SEAT.
WC-2	ADA WATER CLOSET	1"	-	-	4"	2"	MANSFIELD #1301	MOUNT AT ADA HEIGHT. PROVIDE SLOAN ROYAL ESS-1.6-OR-2-10-3/4-LDIM-HW HARD-WIRED SENSOR OPERATED CONCEALED FLUSH VALVE. BEMIS #1955SSCT OPEN FRONT TOILET SEAT.
YCO	YARD CLEAN OUT	-	-	-	4"	-	ZURN CO-2510-PO4	COORDINATE WITH CIVIL FOR INSTALLATION REQUIREMENTS

		EXPANSION TANK SCHEDULE													
			ACCEPTANCE		BASIS OF D	ESIGN									
MARK	SYSTEM	VOLUME	VOLUME	PRESSURE (PSIG)	MANUFACTURER	MODEL	COMMENTS								
ET-1	DOMESTIC HOT WATER	2.1	0.9	55	AMTROL	ST-35CL	ASME DIAPHRAM STORAGE TANK.								

						WATER HEATER SCHEDULE												
			RECOVERY, GPH					BASIS OF D	ESIGN									
MARK	SERVICE	TYPE	@ 90F RISE	FUEL TYPE	MBH INPUT	V	PH	MANUFACTURER	MODEL	COMMENTS								
HWT-1	DOMESTIC HOT WATER	50 GAL	18	ELECT	2 @ 4500 W	208	1	AO SMITH	ENT-50	ANODE ROD. SECURE TO WALL WITH SEISMIC STRAPPING IN TWO LOCATIONS.								


	PUMP SCHEDULE												
			FLOW				ELECTRICAL		BASIS OF	DESIGN			
MARK	LOCATION	SERVICE	(GPM)	HEAD (FT)	FLUID	HP	V	PH	MANUFACTURER	MODEL	COMMENTS		
HWRP-1	MAINTENANCE	HOT WATER	1	6	WATER	1/8	120	10	TACO	006-IQBC7-1IFC	INTEGRAL FLOW CHECK.BRONZE BODY. REMOTE TEMPERATURE SENSOR.		
		RECIRCULATION											

	UNIT HEATER SCHEDULE - ELECTRIC												
					ELECTRICAL	L	BASIS OF DESIGN	I					
MARK	TYPE	CAPACITY	CFM	V	PH	HZ	MANUFACTURER	MODEL	COMMENTS				
EUH-1	CABINET, SURFACE MOUNT	5 KW	210	208	3	60	KING	KCF-2450	SURFACE MOUNTED. INTEGRAL LINE VOLTAGE THERMOSTAT				
EUH-2	UNIT	3 KW	380	208	1	60	MODINE	HER30	1/40 HP, UNIT MOUNTED THERMOSTAT. WALL MOUNT BRACKET.				
EUH-3													
EUH-4													

	FAN SCHEDULE													
NOTES: E	NOTES: ESP VALUE INDICATED IS REQUIRED PRESSURE DOWNSTREAM OF DUCT CONNECTION TO FAN EQUIPMENT (I.E. EXCLUSIVE OF FAN CABINET AND DUCT OUTLET CONNECTION) ON DISCHARGE END.													
	TSP (IN. ELECTRICAL BASIS OF DESIGN													
MARK	SERVICE	CFM	WC)	TYPE	DRIVE	RPM	HP	V	HZ	PH	VFD	MANUFACTURER	MODEL	COMMENTS
EF-1	RESTROOMS	670	0.625	INLINE	DIRECT	1675	1/4	120	60	1	ECM	GREENHECK	SQ-99-VG	DIRECT DRIVE, FILTER BOX,LINE VOLTAGE AUTOMATIC DAMPERS, TIMER CONTROLLED
EF-2	FAMILY ROOM	60	0.625	CEILING	DIRECT	-	1/8	120	60	1	ECM	GREENHECK	SP-A90	INLET GRILLE, OCCUPANCY SENSOR CONTROLLED.

	DIFFUSER, REGISTERS, & GRILLES SCHEDULE													
					BASIS OF DES	SASIS OF DESIGN								
MARK	TYPE	INLET SIZE	DIMENSIONS	COLOR	MANUFACTURER	MODEL	COMMENTS							
EG-1	WALL MOUNTED	VARIES	VARIES	WHITE	TITUS	350 RL	35DEG DEFLECTION, 3/4" BLADE SPACING							
SG-1	WALL MOUNTED	VARIES	VARIES	WHITE	TITUS	300 FS	DOUBLE DEFLECTION, 3/4" BLADE SPACING, ADJUSTABLE							

									LOUVER SCHEDULE				
	DELTA BASIS OF DESIGN												
	SYSTEM				FREE	P-MAX	MANUFACTUR						
MARK	DESCRIPTION	CFM	HEIGHT	WIDTH	AREA	(IN-WG)	ER	MODEL	COMMENTS				
LV-1	INTAKE	700	18	30	1.87	0.05"	RUSKIN	ELF6375DXH	6" DEEP SILL. 1/2" PEST SCREEN. COLOR BY ARCHITECT.				
LV-2	EXHAUST	700	36	18	2.30	0.05"	RUSKIN	ELF6375DXH	6" DEEP SILL. 1/2" PEST SCREEN. COLOR BY ARCHITECT.				

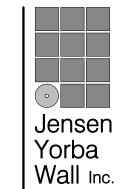

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STATTER HARBOR PHASE IIIC STATTER HARBOR PHASE IIIC RESTROOMS AND COVERED SHELTER CBJ CONTRACT No. DH23-010 JUNEAU, ALAKSA

REVISIONS

SHEET TITLE

SCHEDULES

DATE: SEPTEMBER 29, 2022 FILE: 10722.22004

M002

- 1. ROUTE DRAIN LINES AT MINIMUM 2 PERCENT
- 2. PROVIDE FLOOR DRAIN TRAP PRIMER LINES TO FLOOR DRAINS.



- 1. ROUTE 2" COLD WATER UP FROM BELOW GRADE INTO UTILITY SPACE.
- 2. WASTE UP TO LAVATORIES, URINALS AND WATER CLOSETS ABOVE, TYPICAL.
- 3. 1/2" TRAP PRIMER LINES FROM TRAP PRIMER VALVE AND DISTRIBUTION UNIT ABOVE.



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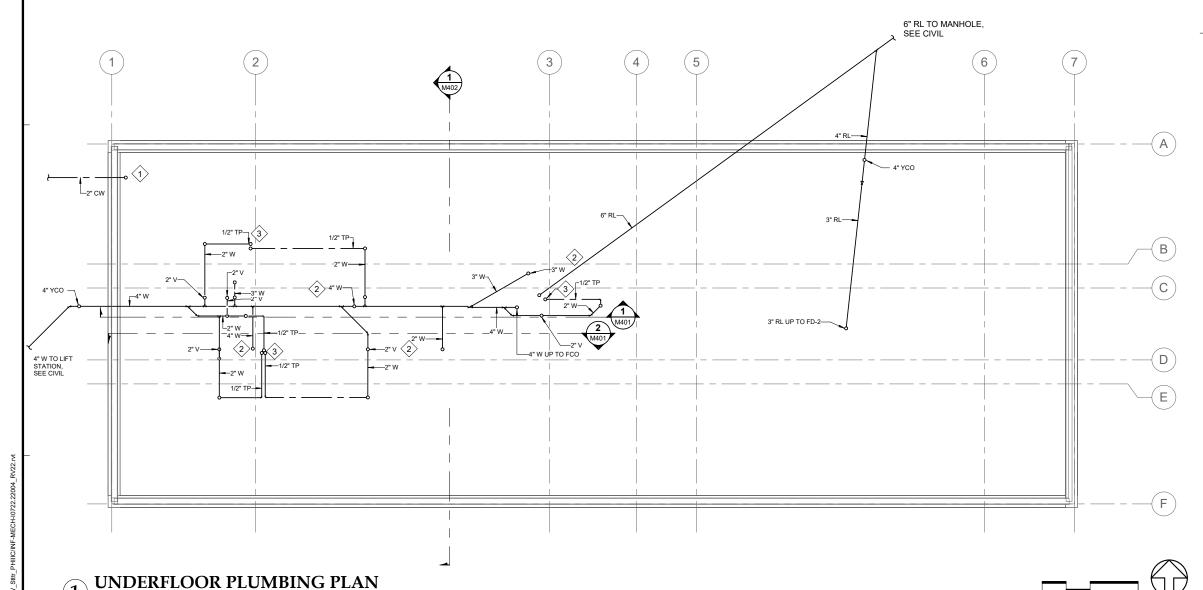
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STATTER HARBOR PHASE IIIC
STATTER HARBOR PHASE IIIC
RESTROOMS AND COVERED SHELTER
CBJ CONTRACT No. DH23-010
JUNEAU, ALAKSA

UNDERFLOOR PLUMBING PLAN

DATE: SEPTEMBER 29, 2022 FILE: 10722.22004



HB-1 →

M501 2" CW 1

FIRST FLOOR PLUMBING PLAN


SHEET NOTES


- 1. PROVIDE LOW POINTS WITH DRAIN VALVES ON WATER PIPING FOR WINTERIZATION.
- 2. PROVIDE ISOLATION VALVES AT BRANCH PIPING TO PERMIT ISOLATION FOR WINTERIZATION.




- DOUBLE-CHECK VALVE AND ISOLATION VALVE.
- PROVIDE 2" COLD WATER BRANCH TO WATER CLOSET SUPPLY HEADER AND 1" COLD WATER CONNECTION TO EACH WATER CLOSET FLUSH
- OF LAVATORIES FOR COLD WATER AND 3/4" PEX MAINIFOLD FOR HOT WATER PEX DISTRIBUTION TO EACH LAVATORY.
- 4. PROVIDE ASSE-1070 HOT WATER TEMPERING VALVE AT LAVATORY HOT WATER SUPPLY. GANG LAVATORY WASTES INTO SINGULAR 2" P-
- CLOSET OR URINAL.
- CLEANOUT ON END OF PIPE.
- 8. EXTEND 3" URINAL WASTE PAST LAST FIXTURE, TURN UP AND EXTEND TO 26" MIN. A.F.F AND PROVIDE CLEANOUT ON END OF PIPE OR WALL CLEANOUT AS INDICATED.




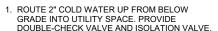

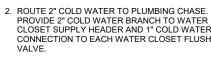


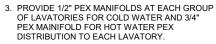



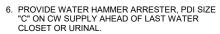

7. EXTEND 4"W PAST LAST FIXTURE, TURN UP AND EXTEND TO 20" MIN. A.F.F AND PROVIDE A

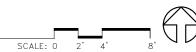


5

L-1

YCO

FD-2

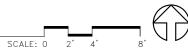

B

 $\left(\mathsf{D}\right)$




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DATE: SEPTEMBER 29, 2022

FIRST FLOOR PLUMBING PLAN

FILE: 10722.22004



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DATE: SEPTEMBER 29, 2022 FILE: 10722.22004

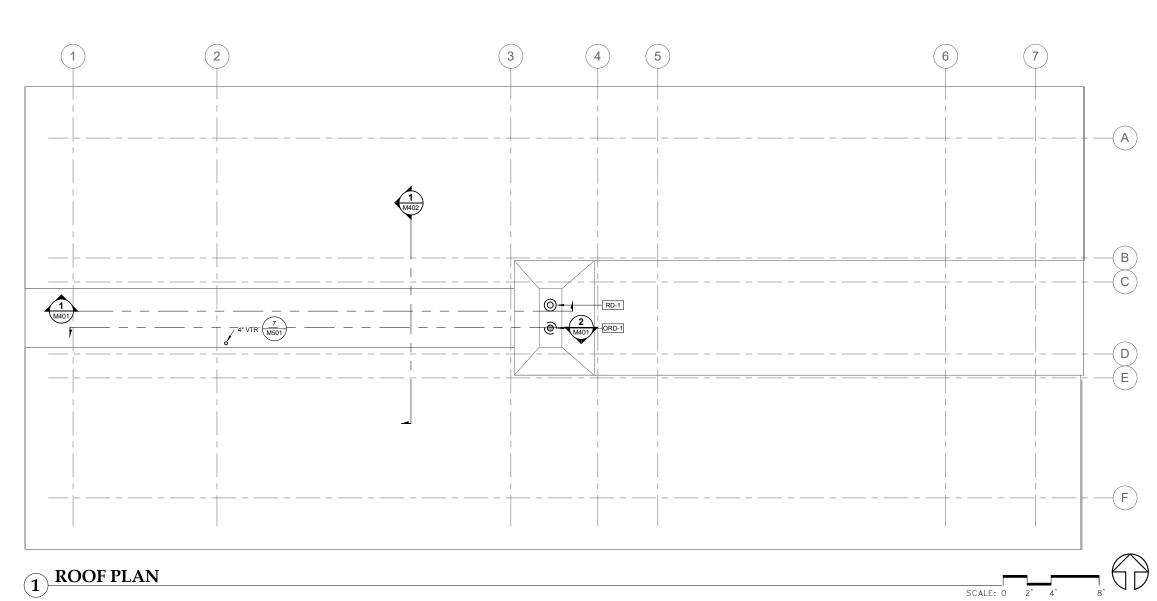M112

REVISIONS

SHEET TITLE


ROOF PLAN

1 FIRST FLOOR MECHANICAL PLAN

SHEET NOTES

- 1. SEE 4/M501 FOR EXHAUST FAN DETAIL.
- 2. SEE 2/M501 FOR RECESSED ELECTRIC CABINET UNIT HEATER DETAIL.
- 3. SEE 1/M501 FOR ELECTRIC BASEBOARD DETAIL.
- 4. PROVIDE TURNING VANES IN RECTANGULAR ELBOWS.



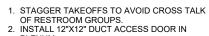



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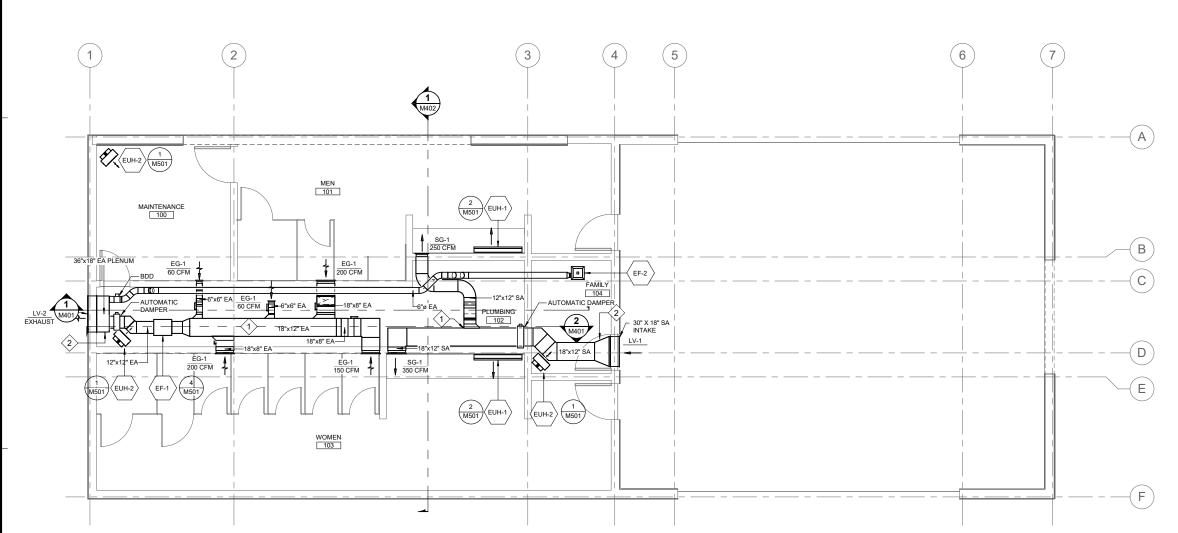
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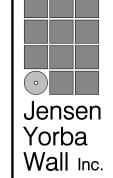


STATTER HARBOR PHASE IIIC STATTER HARBOR PHASE IIIC RESTROOMS AND COVERED SHELTER CBJ CONTRACT No. DH23-010 JUNEAU, ALAKSA

SHEET TITLE FIRST FLOOR MECHANICAL PLAN

DATE: SEPTEMBER 29, 2022 FILE: 10722.22004





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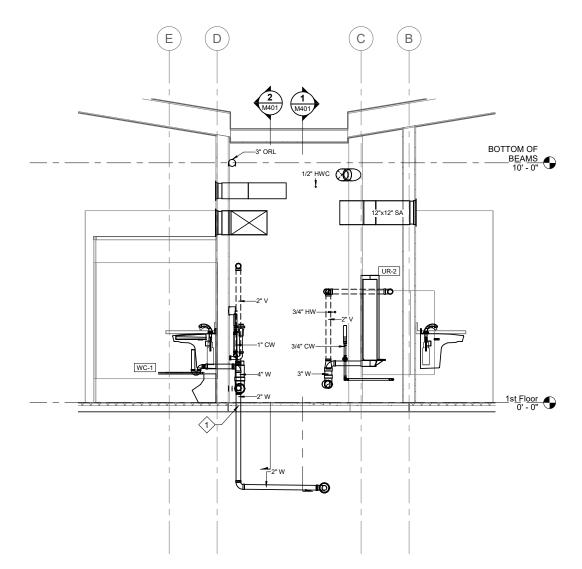


STATTER HARBOR PHASE IIIC
STATTER HARBOR PHASE IIIC
RESTROOMS AND COVERED SHELTER
CBJ CONTRACT No. DH23-010
JUNEAU, ALAKSA

REVISIONS SHEET TITLE MECHANICAL SECTIONS

DATE: SEPTEMBER 29, 2022 FILE: 10722.22004

M401



SCALE: 0 1' 2'

GRIDLINE 2.5 MECHANICAL SECTION

SHEET KEYNOTES

SLEEVE ALL PIPING INSTALLED THROUGH CONCRETE SLAB. SEE STRUCTURAL FOR LOCTIONS OF THICKENED SLABS.



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RESTROOMS AND COVERED SHELTER
CBJ CONTRACT No. DH23-010
JUNEAU, ALAKSA

REVISIONS

SHEET TITLE MECHANICAL SECTIONS


DATE: SEPTEMBER 29, 2022 FILE: 10722.22004

M402







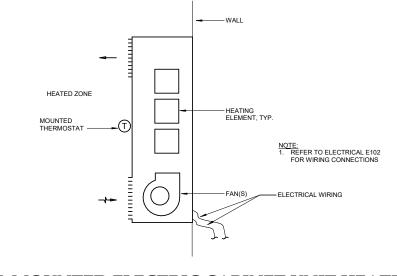

- SEAL INSIDE WATER TIGHT RIGID INSULATION INTAKE PLENUM -

ELECTRIC UNIT HEATER DETAIL

付

VIBRATION HANGER


FAN GUARD


NOTE: REFER TO ELECTRICAL


- ELECTRICAL JUNCTION

WALL MOUNTED ELECTRIC CABINET UNIT HEATER DETAIL


INTAKE LOUVER DETAIL

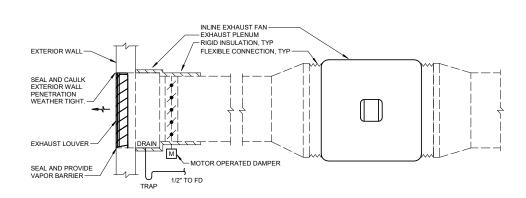

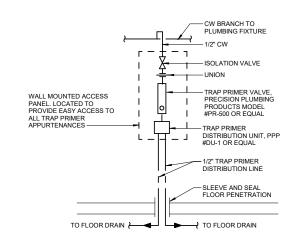

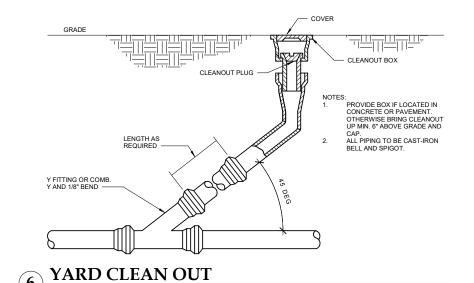

INLINE EXHAUST FAN DETAIL

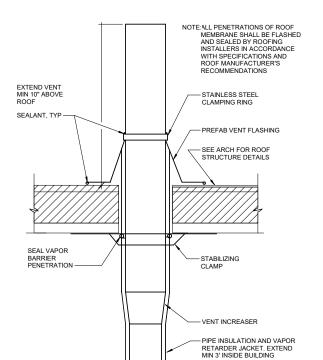


VENT THROUGH ROOF DETAIL

1/2" HWR -TO PLUMBING FIXTURES 1/2" HWR -TEMPERATURE SENSOR SET TO 2GPM INTEGRAL WITH PUMP ROUTE DISCHARGE FULL SIZE TO ET-1 SERVICE SINK. PROVIDE 2" MIN AIR (HWT-1) SECURE HWT-1 TO WALL

-₩


TRAP PRIMER DETAIL

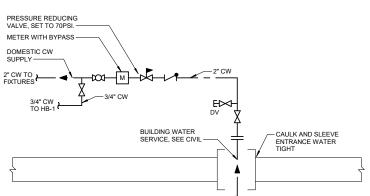

HOT WATER PIPING DIAGRAM

CONCRETE HOUSE KEEPING PAD. SEE STRUCTURAL AND COORDINATE REQUIREMENTS. —

WATER SERVICE ENTRY DIAGRAM

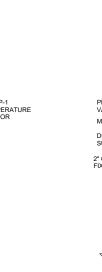

HWR RETURN SEE PLANS —

M501

FILE: 10722.22004

DATE: SEPTEMBER 29, 2022

REVISIONS

SHEET TITLE **DETAILS AND**

DIAGRAMS


STATTER HARBOR PHASE IIIC
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RESTROOMS AND COVERED SHELTER
CBJ CONTRACT No. DH23-010
JUNEAU, ALAKSA

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NOTES:


2 COORDINATE CONDUIT AND CIRCUIT REQUIREMENTS WITH LIFT STATION MANUFACTURER.

	ABBREVIATIONS
AFF	ABOVE FINISHED FLOOR
AFG	ABOVE FINISHED GRADE
DVR	DRIVER
GFCI	GROUND FAULT INTERRUPTED
PC	PHOTOELECTRIC CELL
UON	UNLESS OTHERWISE NOTED
WP	WEATHERPROOF
XFMR	TRANSFORMER
	LIGHTING SYMBOLS
	PENDANT LUMINAIRE
-	WALL MOUNTED LUMINAIRE
⇌	WALL MOUNTED LUMINAIRE
	1
	WIRING AND LIGHTING CONTROL DEVICE SYMBOLS
OA	OCCUPANCY SENSOR, WALL MOUNTED
os	OCCUPANCY SENSOR WALL SWITCH
OP	OCCUPANCY SENSOR POWER PACK
MD	MOTION SENSOR, WALL MOUNTED
PC	PHOTOELECTRIC SWITCH/CONTROL
⊕	DUPLEX RECEPTACLE
# =	DOUBLE DUPLEX RECEPTACLE
G =	GROUND-FAULT CIRCUIT INTERRUPTER (GFCI) DUPLEX RECEPTACLE
WP⊖=	WET-LOCATION, WEATHERPROOF DUPLEX RECEPTACLE
Ū.	JUNCTION BOX / EQUIPMENT CONNECTION
Ť	NONFUSIBLE SWITCH
Sм	MOTOR-STARTING SWITCH, WITHOUT OVERLOAD PROTECTION
$\widetilde{\Omega}$	MOTOR CONNECTION
ă	METER SOCKET
	DISTRIBUTION PANELBOARD
	ONE-LINE DIAGRAM SYMBOLS (600V AND BELOW)
PANELBOARD NLPxx 20BY/120V 3Ø, 4V 225A ROOM XXX	PANELBOARD
$\rightarrow \frown$	CIRCUIT BREAKER
\sim	TRANSFORMER
\subseteq	CURRENT TRANSFORMER
kwh	METER

Ŧ

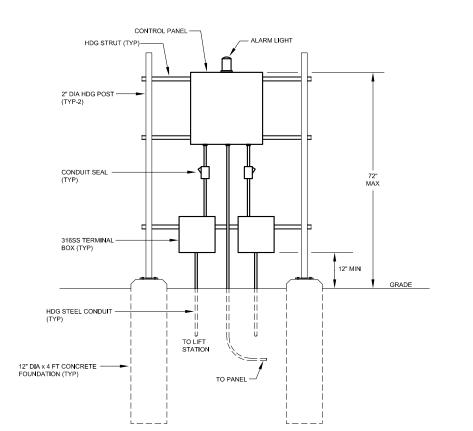GROUND

		SIGNALING SYMBOLS - SECURITY									
	CR	CARD READER									
	С	CAMERA									
	W	RADIO									
		POWER LINE TYPES									
	ABOVE GRADE CIRCUITS										
[UNDERGROUND AND BELOW GRADE CIRCUITS									

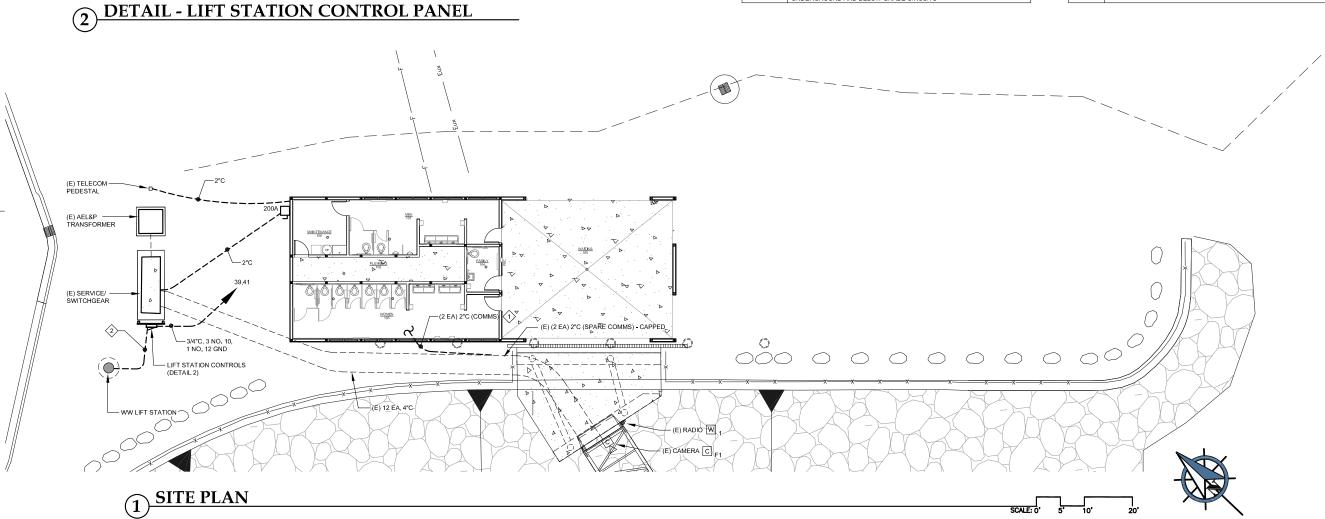



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AECC163270

CITY AND BOROUGH OF JUNEA STATTER HARBOR PHASE IIIC RESTROOMS AND COVERED SHELT CBJ CONTRACT NO. E

REVISIONS

SHEET TITLE


LEGEND, SITE PLAN

DATE: SEPTEMBER, 2022 FILE: 22017

E100

	PANEL		SIZE VOLT		TS/PHASE		MAIN		LOCATION	MOUNT		
		225 AMPS		208Y/120V, 3 PH			MLO		MAINTENANCE 100 SURI		FACE	
K 1	DESCRIPTION	BREAKER AMP/ POLE	CKT	AØ	KVA BØ	сø	СКТ	BREAKER AMP/ POLE	DESCRIPTION		C K	
1	LTG: EXTERIOR & WAITING	20/1	1.4	1.8			0.4	20/1	WAITING	∰ GFI		
3	LTG: FAMILY, PLUMBING & MAINTENANCE	20/1	0.8		1.2		0.4	20/1	WAITING	∰ GFI		
5	LTG: WOMEN & MEN	20/1	0.5			1.0	0.5	20/1	RESTROOMS	∯ GFI	1 6	
7			0.0	0.2			0.2	20/1	MAINTENANCE	Φ		
9			0.0		1.5		1.5	20/1	LAVS & TOILETS	Τ & Φ	1	
11			0.0			0.0	0.0	20/1			1	
13			0.0	0.0			0.0				1	
15			0.0		0.4		0.4	20/1	CAMERAS & ACCESS CONTROL		1	
17	HAND DRYER - WOMEN	20/1	1.5			1.5	0.0				1	
19	HAND DRYER - WOMEN	20/1	1.5	1.5			0.0				2	
21	HAND DRYER - MEN	20/1	1.5		1.5		0.0				2	
23	HOT WATER RECIRC HWRP-1	20/1	0.2			0.2	0.0				2	
25	FAMILY EUH-2	20/2	1.5	2.0			0.5	20/1 *	HEAT TRACE		2	
27	3 KW		1.5		1.7		0.2	20/1	EXHAUST FAN EF-1		2	
29	PLUMBING EUH-2	20/2	1.5			3.0	1.5	20/2	MAINTENANCE EUH-2		3	
31	3 KW		1.5	3.0			1.5	_	3KW		3	
33	WOMEN EUH-1	20/3	1.7		3.4		1.7	20/3	MEN EUH-1		3	
35	5 KW		1.7			3.4	1.7	_	5 KW		3	
37			1.7	3.4			1.7	_			3	
39	SEWER LIFT STATION	30/2	0.7		3.0		2.3	30/2	WATER HEATER (HWT-1)		4	
41			0.7			3.0	2.3	_	4.5		4	
BALANCED CONNECTED LOAD: 36.7 KVA / 101.9 AMPS 11.9 12.7 12.1						_						

* 30 mA GROUND FAULT

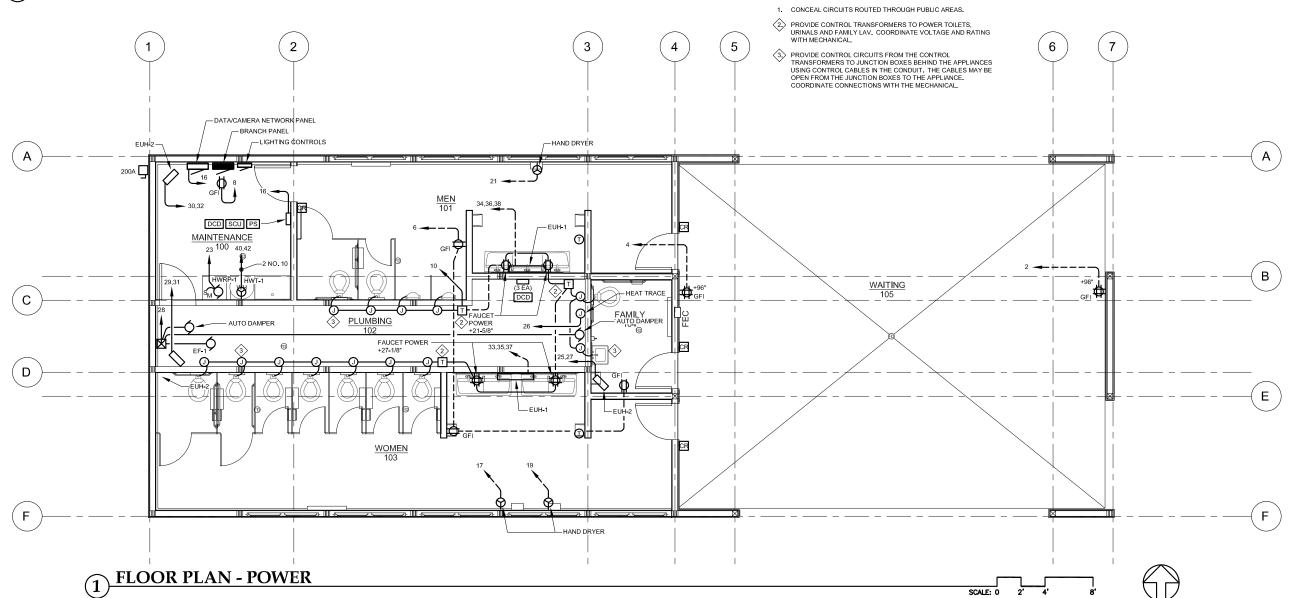

NOTES:

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CITY AND BOROUGH OF JUNEAU STATTER HARBOR PHASE IIIC RESTROOMS AND COVERED SHELTER CBJ CONTRACT No. E JUNEAU, ALASKA

REVISIONS SHEET TITLE FLOOR PLAN -POWER


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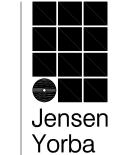
E201

	LUMINAIRE SCHEDULE					
TYPE	DESCRIPTION	MANUFACTURER	LAMPS	REMARKS		
N1	SUSPENDED LINEAR LENSED STRIP, STEEL HOUSING, SNAP-ON FROSTED ACRYLIC LENS, INTEGRAL ELECTRONIC DRIVER, 120-277V, 3000 LUMENS, WHITE FINISH	LITHONIA LIGHTING ZL1N L48 3000LM FST MVOLT 35K 80CRI WH ZACVHM100	25W WHITE LED 3500K, CRI 85	MOUNT @ 10-0" AFF TO BOTTOM OF LUMINAIRE, UON. IN PLUMBING 102 MOUNT BELOW MECHANICAL DUCTS.		
W1	9' WALL MOUNTED LINEAR LED DIRECT, EXTRUDED ALUMINUM HOUSING, SATINE ACRYLIC LENS, MEDIUM OUTPUT, CONTINUOUS ROW, INTEGRAL OCCUPANCY SENSOR, REMOTE ELECTRONIC DRIVER, 120-277V, 750 LM/FT, WHITE FINISH	PINNACLE V3D-A-835MO-9'-WA-U-FSD-1-0-W	5.2W/FT WHITE LED 3500K, CRI 85	MOUNT @ 7'-6" AFF TO BOTTOM OF LUMINAIRE, UON.		
W2	9' WALL MOUNTED LINEAR LED DIRECT, EXTRUDED ALUMINUM HOUSING, SATINE ACRYLIC LENS, LOW OUTPUT, CONTINUOUS ROW, INTEGRAL OCCUPANCY SENSOR, REMOTE ELECTRONIC DRIVER, 120-277V, 500 LM/FT, WHITE FINISH	PINNACLE V3D-A-835LO-9'-WA-U-FSD-1-0-W	3.4W/FT WHITE LED 3500K, CRI 85	MOUNT @ 7'-0" AFF TO BOTTOM OF LUMINAIRE, UON.		
W3	11' WALL MOUNTED, SAME AS TYPE W2	PINNACLE V3D-A-835LO-11'-WA-U-FSD-1-0-W	3.4W/FT WHITE LED 3500K, CRI 85	MOUNT @ 7'-0" AFF TO BOTTOM OF LUMINAIRE, UON.		
W4	13' WALL MOUNTED, SAME AS TYPE W2	PINNACLE V3D-A-835LO-13'-WA-U-FSD-1-0-W	3.4W/FT WHITE LED 3500K, CRI 85	MOUNT @ 8'-0" AFF TO BOTTOM OF LUMINAIRE, UON.		
W5	23' WALL MOUNTED, SAME AS TYPE W2	PINNACLE V3D-A-835LO-23'-WA-U-FSD-1-0-W	3.4W/FT WHITE LED 3500K, CRI 85	MOUNT @ 8'-0" AFF TO BOTTOM OF LUMINAIRE, UON.		
W6	31' WALL MOUNTED, SAME AS TYPE W2	PINNACLE V3D-A-835LO-31'-WA-U-FSD-1-0-W	3.4W/FT WHITE LED 3500K, CRI 85	MOUNT @ 9'-0" AFF TO BOTTOM OF LUMINAIRE, UON. REMOTE DRIVER DISTANCE @ 20' MAX.		
W7	42' WALL MOUNTED, SAME AS TYPE W2	PINNACLE V3D-A-835LO-42'-WA-U-FSD-1-0-W	3.4W/FT WHITE LED 3500K, CRI 85	MOUNT @ 9'-0" AFF TO BOTTOM OF LUMINAIRE, UON. REMOTE DRIVER DISTANCE @ 20' MAX.		

LUMINAIRE SCHEDULE CONT.					
TYPE	DESCRIPTION	MANUFACTURER	LAMPS	REMARKS	
W8	3' SURFACE BACK MOUNTED LINEAR LED, EXTRUDED ALUMINUM HOUSING, TEMPERED GLASS LENS, 20"x20" DISTRIBUTION, LOW OUTPUT, REMOTE ELECTRONIC 0-10V DIMMING DRIVER, 120-277V, 1421 LUMENS PER LUMINAIRE, TEXTURED BRONZE FINISH	INSIGHT LIGHTING MER-LO-30K-2020-SMB-36-NO- TBR-CES	3.5W/FT WHITE LED 3000K, CRI 85	MOUNT @ 10°-3° AFF TO MIDDLE OF LUMINAIRE, UON. AIM TO HIGHLIGHT CEILING. PROVIDE (1 EA) 240W (CES) REMOTE DRIVER PER RUN.	
W9	4' SURFACE BACK MOUNTED, 1895 LUMENS, SAME AS TYPE W8	INSIGHT LIGHTING MER-LO-30K-2020-SMB-48-NO- TBR-CES	3.5W/FT WHITE LED 3000K, CRI 85	MOUNT @ 10°-3° AFF TO MIDDLE OF LUMINAIRE, UON. AIM TO HIGHLIGHT CEILING. PROVIDE (1 EA) 240W (CES) REMOTE DRIVER PER RUN.	
W10	EXTERIOR WALL PACK, DIE-CAST HOUSING, TEMPERED GLASS LENS, INTEGRAL ELECTRONIC DRIVER, 120-277V, 1418 LUMENS, BRONZE FINISH	LUMARK XTOR1B-Y-BZ-PC1	12W WHITE LED 3000K, CRI 85	MOUNT @ 12-0" AFG TO BOTTOM OF LUMINAIRE, UON.	
OA	WALL MOUNTED OCCUPANCY SENSOR, LOW VOLTAGE, WHITE FINISH	nLIGHT nWV PDT 16		MOUNT @ 10'-0" AFF TO BOTTOM OF DEVICE, UON.	
OS	WALL SWITCH OCCUPANCY SENSOR, LINE VOLTAGE, WHITE FINISH	SENSOR SWITCH WSX PDT WH		MOUNT @ 46" AFF TO CENTER OF DEVICE.	
OP	POWER PACK	SENSOR SWITCH nPP16			
MD	WALL MOUNTED MOTION SENSOR, LINE VOLTAGE, LOW MOUNT, OUTDOOR PIR, OCCUPANCY CONTROLLED DIMMING, WHITE FINISH, MIN DIM LEVEL 2V	SENSOR SWITCH SBOR 10 OEX D WH 2V			

NOTE: ALL LUMINAIRE MOUNTING HEIGHTS ARE TO THE BOTTOM OF THE LUMINAIRE, UNLESS OTHERWISE NOTED AND OR APPLICABLE.



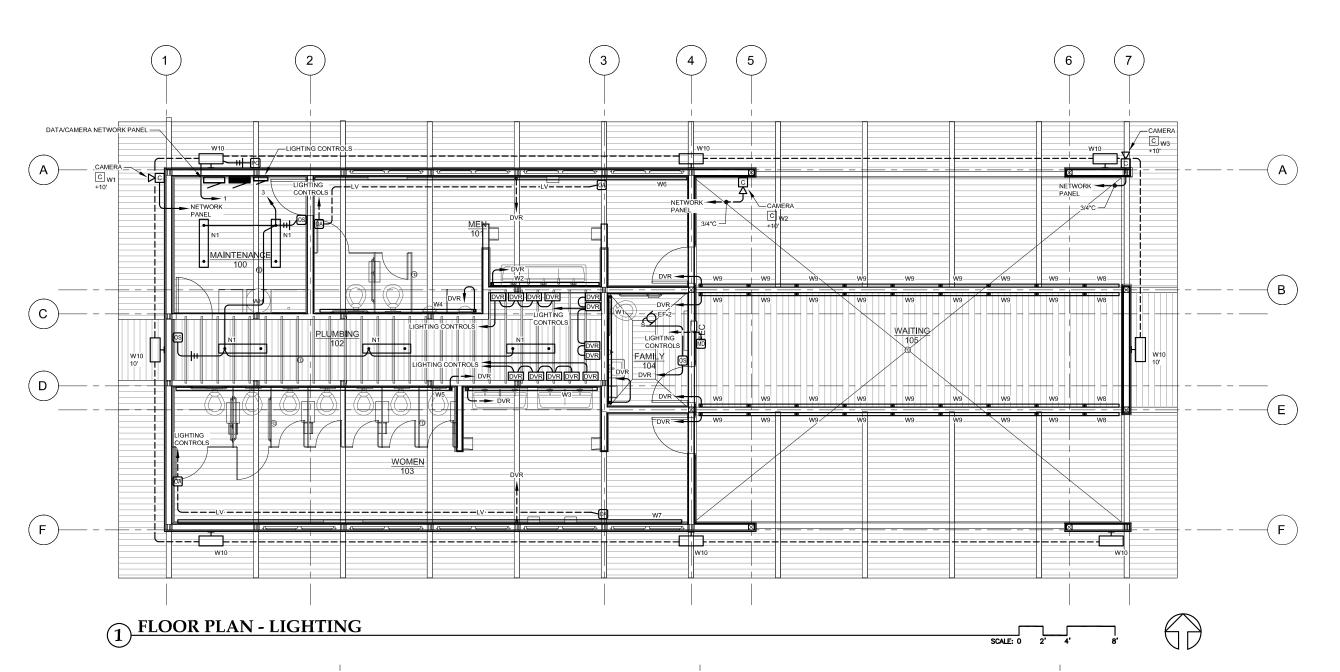

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CITY AND BOROUGH OF JUNEAU STATTER HARBOR PHASE IIIC RESTROOMS AND COVERED SHELTER CBJ CONTRACT No. E JUNEAU, ALASKA

REVISIONS


SHEET TITLE FLOOR PLAN -LIGHTING, LUMINAIRE

SCHEDULE

DATE: SEPTEMBER, 2022





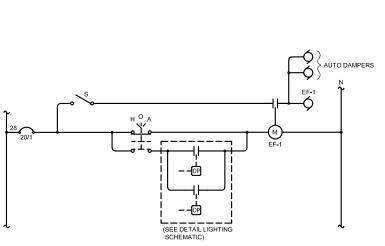

SCHEMATIC DIAGRAM - LIGHTING CONTROLS

⊢ 2 EA

OA — OA — OP — OP — SEE DETAIL 2

OA OA OP OP SEE DETAIL 2

W10 EXTERIOR

W9

PLUMBING 102


MAINTENANCE 100

WOMEN 103

SCHEMATIC DIAGRAM - EF-1 CONTROLS

	ACCESS CONTROL SYSTEM				
ITEM	DESCRIPTION	MANUFACTURER			
CR	CREDENTIAL CARD READER	HID RP40			
DCD	DOOR CONTROL DEVICE	MILLENIUM EDCD			
SCU	SITE CONTROL UNIT	MILLENIUM ESCU			
ES	ELECTRIC DOOR STRIKE	HES 1006			
PS	POWER SUPPLY	MILLENIUM PS1 12V			


	SURVEILLANCE CAMERA SYSTEM					
ITEM	DESCRIPTION	MANUFACTURER				
C _{F1}	EXISTING FISHEYE CAMERA WITH BUILT-IN STORAGE POE ELECTRICAL	DIGITAL WATCH DOG DWC-PVF5M1TIRC				
C _{w1}	NEW ULTRA WIDE BULLET CAMERA, 2.3mm LENS, MICRO SD/SDHC/SDXC CARD, POE ELECTRICAL	DIGITAL WATCH DOG DWC-MBW8WI2TW				
C _{w2}	NEW ULTRA WIDE BULLET CAMERA, 2.3MM LENS, MICRO SD/SDHC/SDXC CARD, POE ELECTRICAL	DIGITAL WATCH DOG DWC-MBW8WI2TW				
C w3	NEW ULTRA WIDE BULLET CAMERA, 2.3MM LENS, MICRO SD/SDHC/SDXC CARD, POE ELECTRICAL	DIGITAL WATCH DOG DWC-MBW8WI2TW				
W ₁	EXISTING 5GHz RADIO	UBIQUITI NANOSTATION LOCO 5AC				

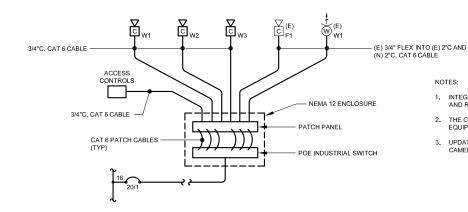

NOTES

- INTEGRATE THE NEW CAMERAS AND SWITCH WITH EXISTING CAMERA AND RADIO.
- 2. THE CAMERAS SHALL SIGNAL THEIR VIDEO TO EXISTING HEADEND EQUIPMENT IN THE HARBORMASTERS OFFICE.
- 3. UPDATE THE MASTER SOFTWARE TO INCORPORATE THE NEW CAMERAS.

LINE DIAGRAM - SURVEILLANCE CAMERA SYSTEM

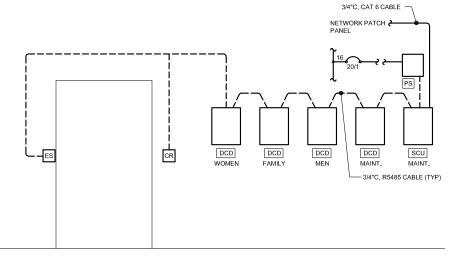

NOTES:

- BASE THE HARDWARE AND SYSTEM CONFIGURATION ON SYSTEM IN THE HARBORMASTERS OFFICE.
- 2. UPDATE THE MASTER SOFTWARE TO INCORPORATE THE NEW DOORS.

DETAIL - DOOR HARDWARE WITH ACCESS CONTROLS



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REVISIONS SHEET TITLE

STATTE STATTE RESTROOMS

SCHEMATIC DIAGRAMS

DATE: SEPTEMBER, 2022 FILE: 22017

E302