LEE STREET AND BONNIE BRAE PUMP STATION RENOVATIONS

VOLUME II of II

Contract No. BE21-122

File No. 2018





IF	E STREET SHEET INDEX
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SHEET NO.	DESCRIPTION
GENERAL	
G1.0	COMBINED COVER SHEET
G2.0	COMBINED LEGEND, ABBREVIATIONS & GENERAL NOTES
G3.0L	LEE STREET COVER SHEET
G4.0L	TEMPORARY WATER SERVICE PLAN OVERVIEW
G5.0L	TEMPORARY WATER PUMP PLAN
G6.0L	TEMPORARY WATER PUMP SINGLE LINE DIAGRAM
MECHANICAL	
M1.OL	PUMP & PIPING DEMOLITION PLAN
M2.0L	PIPING PLAN
M3.0L	PIPING SECTIONS
M4.0L	PIPE PLAN DETAILS
ELECTRICAL	
E1.0L	LEGEND, SCHEDULE
E2.0L	FLOOR PLANS - POWER & LOW VOLTAGE
E3.0L	DETAILS
E4.0L	DIAGRAMS
E5.0L	PLC WIRING DIAGRAMS
E6.0L	DIAGRAM AND DETAIL
E7.0L	FLOOR PLANS - LIGHTING


LEE STREET AND BONNIE BRAE PUMP STATION RENOVATIONS

BE21-122
CITY & BOROUGH OF JUNEAU, ALASKA

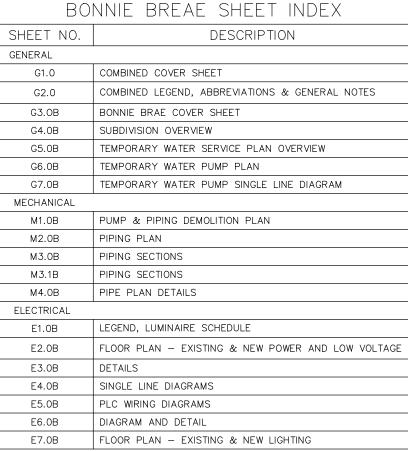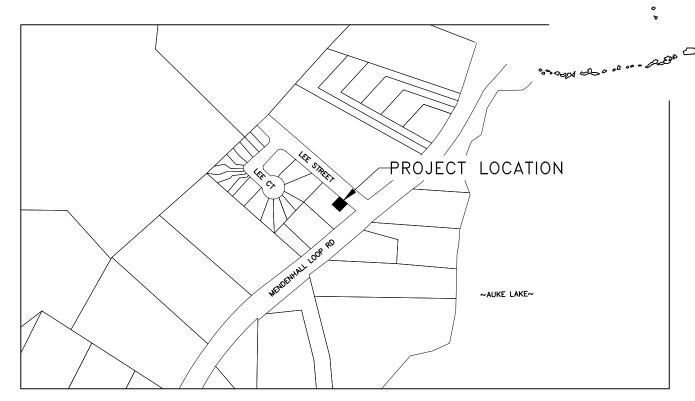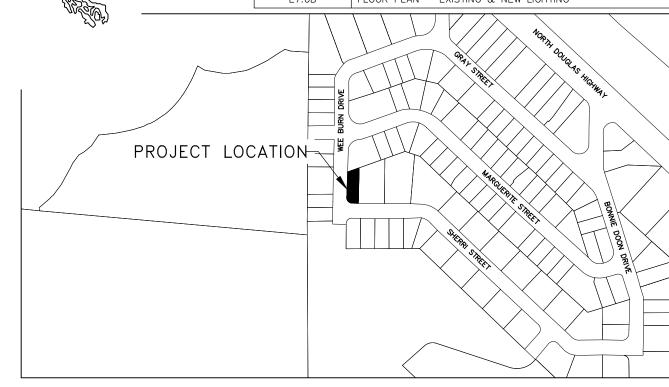ALASKA







LEE STREET LOCATION MAP

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BONNIE BRAE LOCATION MAP

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- AND STREET			RECORD OF REVISIONS	
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	DRAWN BY:	C.BYDLON
1	DESIGNED BY:	L. CHAMBERS
N	CHECKED BY:	G. Gladsjo
λ	DATE:	Sep-2020
1 1	1945 ALEX HO	LDEN WAY #101

1945 ALEX HOLDEN WAY #10 JUNEAU, AK 99801



LEE STREET AND BONNIE BRAE PUMP STATION RENOVATIONS

BE21-122

JUNEAU

COMBINED COVER SHEET

SHEET NUMBER
G1.0
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ABBREVIATIONS

AC ACP ASPHALT CONCRETE ASBESTOS CEMENT PIPE BOP BEGINNING OF PROJECT ВТМ BOTTOM BVC BEGIN VERTICAL CURVE CATCH BASIN CB CBJ CITY & BOROUGH OF JUNEAU C/L CENTERLINE CORRUGATED METAL PIPE CORRUGATED POLYETHYENE PIPE CPP CONC CTE DIP CONCRETE CONNECT TO EXISTING DUCTILE IRON PIPE DIA DIAMETER ELEVATION END OF PROJECT EOP END VERTICAL CURVE EVC FINISHED GRADE FG GATE VALVE GV HDPE HIGH DENSITY POLYETHYLENE INVERT LOW POINT MANHOLE МН MINIMUM MIN MATCH TO EXISTING MTE NOT IN CONTRACT NUMBER NOT TO SCALE NTS OC PC ON CENTER POINT OF CURVATURE PCC POINT OF COMPOUND CURVATURE POINT OF REVERSE CURVATURE P/L PROPERTY LINE POUNDS PER SQUARE INCH POINT OF TANGENT POLYVINYL CHLORIDE PIPE POINT OF VERTICAL INTERSECTION PVI RP RADIUS POINT RT RIGHT RIGHT-OF-WAY ROW STATION STA STANDARD STD TOP BACK OF CURB TOP BACK OF GUTTER TBG TP

TOP OF PAVEMENT

TYPICAL

TYP

GENERAL NOTES

- CBJ ENGINEERING STANDARD DETAILS BOOK FOR CIVIL ENGINEERING PROJECTS AND SUBDIVISION IMPROVEMENTS FOURTH ADDITION DATED AUGUST, 2011 AND CBJ ENGINEERING STANDARD SPECIFICATIONS DATED DECEMBER, 2003 ARE MADE A PART OF THIS CONTRACT, INCLUDING ALL ERRATA (NOS. 1-16) AND CURRENT REVISIONS AS APPLICABLE.
- 2. PROPERTY LINE LOCATIONS USED IN THESE PLANS ARE DERIVED FROM RECORD PLATS AND DO NOT REPRESENT BOUNDARY SURVEY.
- 3. CONTRACTOR SHALL ENSURE GARBAGE PICKUP, PRIVATE AND BUSINESS DELIVERIES, AND DAILY MAIL SERVICE WILL BE UNINTERRUPTED TO ALL BUSINESS AND RESIDENCES AFFECTED BY THIS PROJECT.
- 4. THE CONTRACTOR SHALL NOT STORE MATERIALS OR EQUIPMENT, OR OPERATE EQUIPMENT WITH ITS TRACKS OR WHEELS PLACED ON PRIVATE PROPERTY, WITHOUT THE WRITTEN APPROVAL OF THE PROPERTY OWNER.
- 5. THE CONTRACTOR SHALL NOTIFY CBJ WATER UTILITIES (LONI VANKIRK AT 723-4975) OF PROPOSED WATER SERVICE INTERRUPTION AND SUBMIT THE "WATER SYSTEM SPECIAL USE PERMIT" TO CBJ WATER UTILITIES SUPERINTENDENT FOR APPROVAL AT LEAST 48 HOURS PRIOR TO SHUTDOWN OR FLUSHING OF MAINLINE WATER PIPE. NO WATER SERVICE INTERRUPTION MAY PROCEED UNTIL THIS APPROVAL IS OBTAINED.
- 6. THE CONTRACTOR SHALL NOTIFY ALL RESIDENTS OF WATER SERVICE INTERRUPTIONS AT LEAST 24 HOURS PRIOR TO THE SERVICE INTERRUPTION. THIS WILL INCLUDE GOING DOOR TO DOOR TO MAKE RESIDENT CONTACT AND HANGING DOOR KNOCKERS ON EACH RESIDENCE. WATER SHUTDOWNS SHALL NOT EXCEED 4 HOURS.
- 7. PRIOR TO INTERRUPTING WATER SERVICE THE CONTRACTOR SHALL VERIFY THAT THE PUMPS, PIPES AND FITTINGS FOR THE WORK ARE ON SITE.
- 8. ALL ITEMS AND MATERIALS DESIGNATED TO BE REMOVED SHALL BECOME THE PROPERTY OF THE CONTRACTOR AND SHALL BE DISPOSED OF OFF-SITE, UNLESS NOTED OTHERWISE IN THE CONTRACT DOCUMENTS.
- 9. ALL PIPING, VALVES, FITTINGS, AND EQUIPMENT THAT WILL BE IN DIRECT CONTACT WITH WATER FOR THE CBJ WATER SYSTEM SHALL BE NSF 61 AND NSF 372 LISTED.
- 10. CALL 586-1333 BEFORE YOU DIG FOR UNDERGROUND POWER, TELEPHONE AND CABLE. CALL 811 ALASKA DIGLINE BEFORE YOU DIG FOR UNDERGROUND ACS & GCI. LOCATIONS AND ELEVATION OF EXISTING UNDERGROUND WATER, SEWER, POWER, TELEPHONE AND CABLE TELEVISION SHOWN ON THE PLANS WERE DERIVED FROM CBJ AS-BUILTS AND FIELD LOCATES. THE ACTUAL LOCATION OF UTILITIES MAY VARY FROM THOSE SHOWN. THE CONTRACTOR IS RESPONSIBLE FOR LOCATING, PROTECTING AND MAINTAINING THE UTILITIES THROUGHOUT THE CONSTRUCTION OF THE PROJECT. ANY DAMAGE TO THE UNDERGROUND UTILITIES DURING CONSTRUCTION SHALL BE PAID FOR BY THE CONTRACTOR AND SHALL BE CONSIDERED INCIDENTAL TO THE CONTRACT.

TRAFFIC CONTROL NOTES

- ALL TRAFFIC TO BE CONTROLLED PER REQUIREMENTS OF THE ALASKA TRAFFIC MANUAL U.S. DEPARTMENT OF TRANSPORTATION "MANUAL ON UNIFORM TRAFFIC CONTROL DEVICES" AND THE ALASKA SUPPLEMENT.
- 2. DETOURS SHALL BE APPROVED BY THE ENGINEER.
- 3. ROAD CLOSURES SHALL BE APPROVED BY THE ENGINEER
- 4. THE CONTRACTOR WILL NOT BE PERMITTED TO OBSTRUCT VEHICULAR TRAFFIC BETWEEN THE HOURS OF 4:30 PM AND 8:00 AM SEVEN DAYS A WEEK. DURING THIS PERIOD ONE LANE SHALL BE OPEN TO VEHICULAR TRAFFIC AND HAVE A MINIMUM WIDTH OF 9 FFFT
- 5. PROVIDE ACCESS FOR EMERGENCY VEHICLES AT ALL TIMES.
- 6. A MINIMUM OF ONE LANE (9 FOOT MINIMUM WIDTH) SHALL BE KEPT OPEN TO VEHICULAR TRAFFIC AT ALL TIMES, EXCEPT A FIVE MINUTE MAXIMUM STOPPAGE TO VEHICULAR TRAFFIC WILL BE PERMITTED WITH NO MORE THAN ONE TRAFFIC STOPPAGE PER HOUR.
- 7. PEDESTRIAN TRAFFIC SHALL BE AVAILABLE ALONG AT LEAST ONE SIDE OF THE STREET AT ALL TIMES. THE PEDESTRIAN PATHWAY SHALL BE CLEARLY MARKED AND SHALL SATISFY THE REQUIREMENTS AS DESCRIBED IN

CERTIFICATE OF AUTHORIZATION

DRAWN BY: C.BYDLON DESIGNED BY: . CHAMBERS CHECKED BY: G. GLADSJO Sep-2020 1945 ALEX HOLDEN WAY #101 JUNEAU, AK 99801



LEE STREET AND **BONNIE BRAE PUMP** STATION RENOVATIONS COMBINED LEGEND, **ABBRVEVIATIONS & GENERAL NOTES**

SHEET NUMBER

G2.0 OF

34


BE21-122

WATER VALVE BOX

LEE STREET PUMP STATION RENOVATION

BE21-122

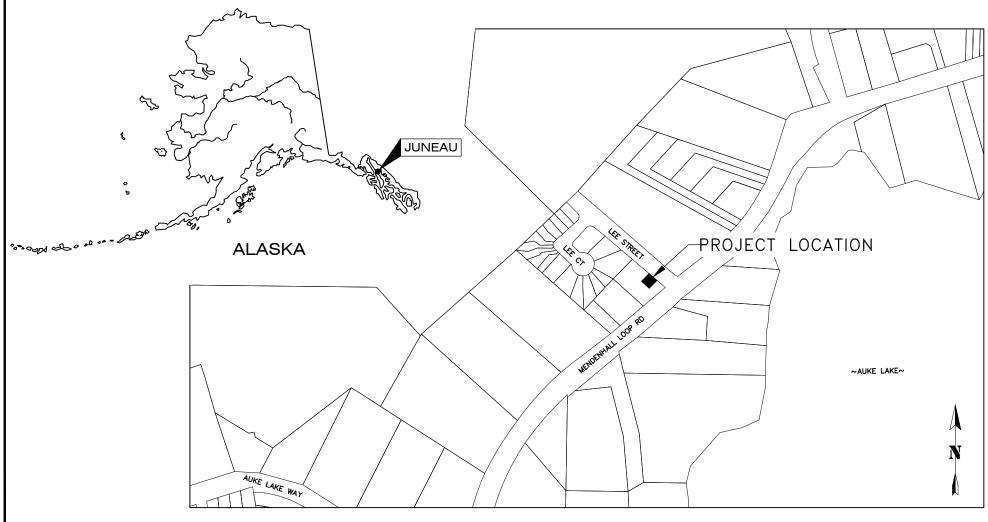CITY & BOROUGH OF JUNEAU, ALASKA



	SHEET INDEX
SHEET NO.	DESCRIPTION
GENERAL	
G3.0L	LEE STREET COVER SHEET
G4.0L	TEMPORARY WATER SERVICE PLAN OVERVIEW
G5.0L	TEMPORARY WATER PUMP PLAN
G6.0L	TEMPORARY WATER PUMP SINGLE LINE DIAGRAM
MECHANICAL	
M1.OL	PUMP & PIPING DEMOLITION PLAN
M2.0L	PIPING PLAN
M3.0L	PIPING SECTIONS
M4.OL	PIPE PLAN DETAILS
ELECTRICAL	
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E3.0L	DETAILS
E4.OL	DIAGRAMS
E5.0L	PLC WIRING DIAGRAMS
E6.0L	DIAGRAM AND DETAIL
E7.0L	FLOOR PLANS - LIGHTING

PROJECT LOCATION MAP NTS

> DESIGNED BY: CHECKED BY:

RECORD OF REVISIONS



C.BYDLON 1945 ALEX HOLDEN WAY #101




LEE ST PUMP STATION **RENOVATION**


LEE STREET COVER SHEET

BE21-122

SHEET NUMBER G3.0L

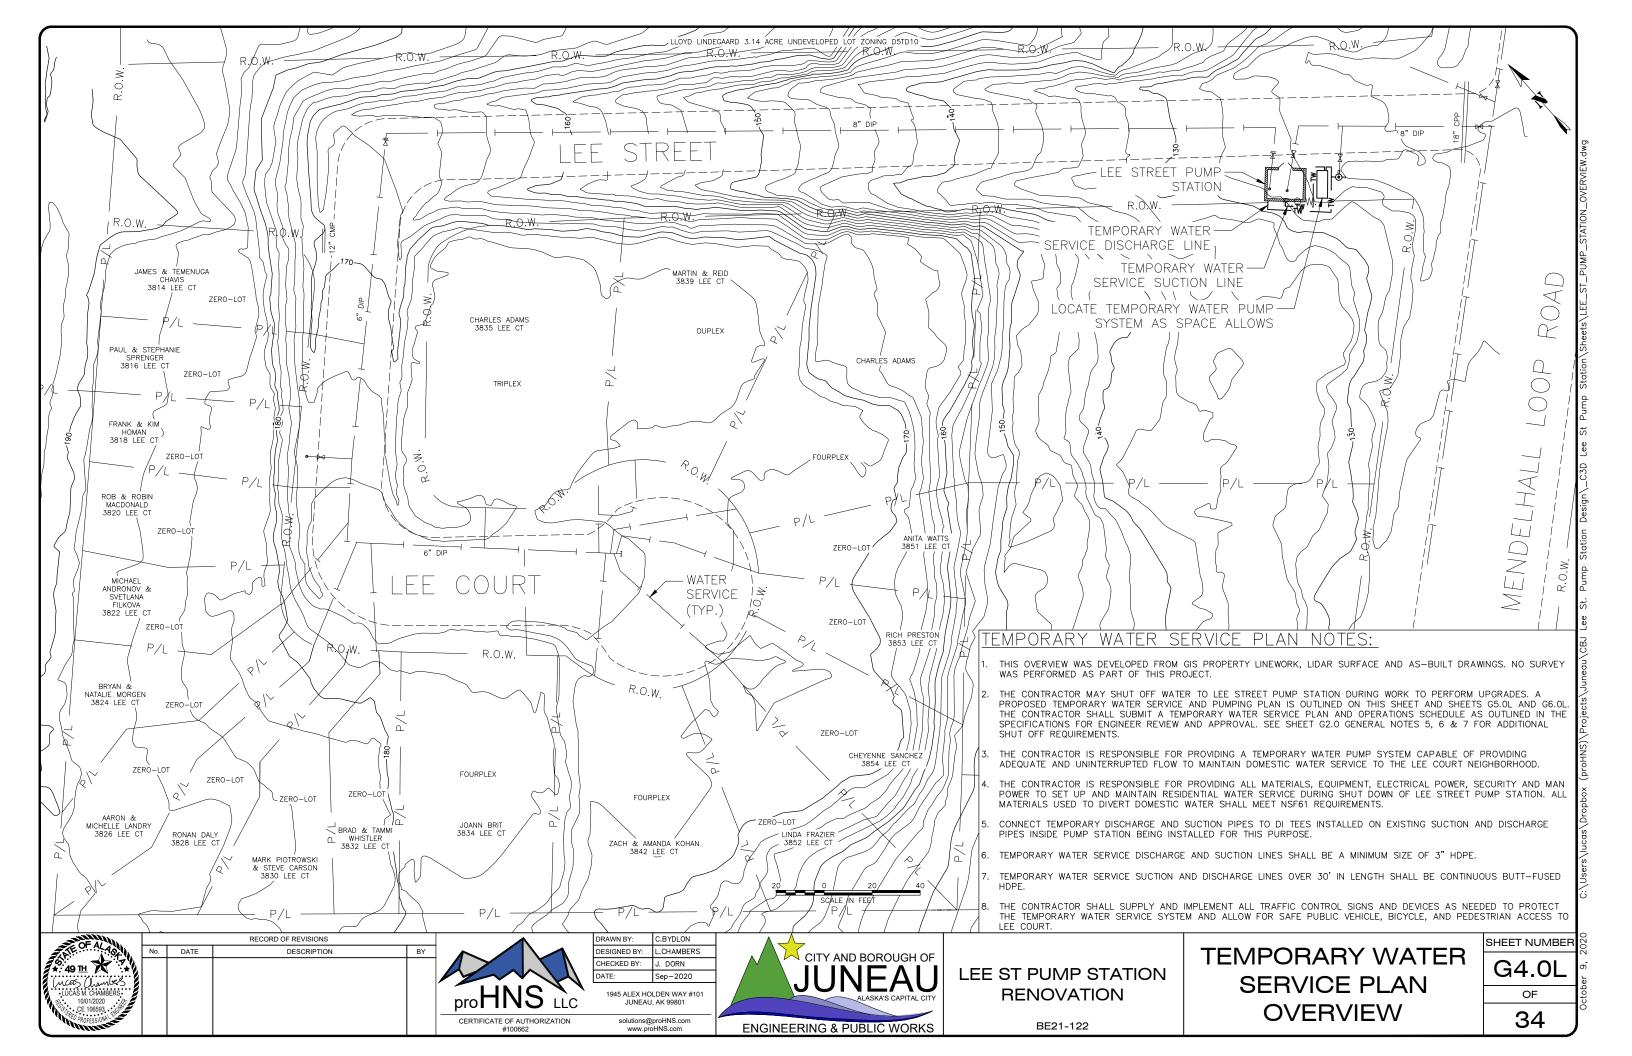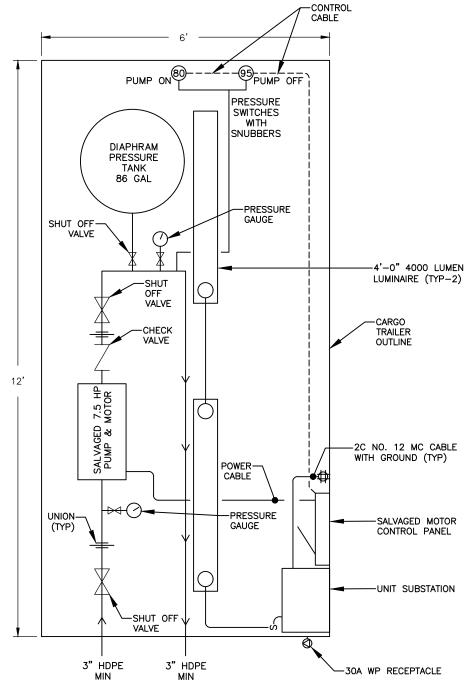34





1 TEMPORARY WATER PUMP AND TRAILER PLAN VIEW SCALE: NOT TO SCALE

TEMPORARY WATER PUMP NOTES:

- 1. THE CONTRACTOR IS RESPONSIBLE FOR PROVIDING ALL MATERIALS, EQUIPMENT, ELECTRICAL POWER, SECURITY AND MAN POWER TO SET UP AND MAINTAIN THE TEMPORARY WATER PUMP.
- 2. SUCTION AND DISCHARGE LINES OUTSIDE THE TRAILER SHALL BE MINIMUM 3" HDPE. PIPING INSIDE THE TRAILER SHALL BE MATERIAL AND SIZE AS REQUIRED TO CONNECT COMPONENTS.
- 3. THE CONTRACTOR MAY PENETRATE THE EXTERIOR WALL TO ATTACH THE TEMPORARY SUCTION AND DISCHARGE PIPES TO THE PROPOSED DIP TEES INSTALLED ON THE SUCTION AND DISCHARGE PIPES INSIDE THE PUMP HOUSE. AFTER DECOMMISSIONING THE TEMPORARY PUMP RETURN EXTERIOR WALL TO EXISTING CONDITION. SEE PIPING PLAN ON SHEET M2.0L AND PIPING SECTIONS ON M3.0L FOR DETAILS ON DIP TEE AND VALVE INSTALLED ON SUCTION AND DISCHARGE PIPES INSIDE THE PUMP HOUSE INSTALLED FOR FACILITATING THE TEMPORARY PUMPING PLAN.
- 4. THE CONTRACTOR SHALL PROVIDE AND INSTALL MATERIAL AND EQUIPMENT NECESSARY TO MITIGATE THE EFFECTS OF WATER HAMMER ON THE SYSTEM.
- 5. THE CONTRACTOR SHALL FURNISH A CARGO TRAILER MEETING THE REQUIREMENTS OF THE SPECIFICATIONS. THE CONTRACTOR SHALL INSTALL TEMPORARY WATER PUMP SYSTEM INSIDE THE CARGO TRAILER. LAYOUT OF COMPONENTS INSIDE THE TRAILER MAYBE MODIFIED AS APPROVED BY THE ENGINEER. THE SALVAGED MOTOR CONTROL PANEL AND THE UNIT SUBSTATION SHALL BE MOUNTED TO A 3/4" PLYWOOD BOARD, MOUNTED TO THE INTERIOR OF THE TRAILER.
- 6. THE CONTRACTOR SHALL SALVAGE AND REUSE THE EXISTING 7.5HP PUMP AND MOTOR. THE CONTRACTOR SHALL SALVAGE AND REUSE THE EXISTING MOTOR CONTROL PANEL AND PRESSURE SWITCHES FOR USE IN THE TEMPORARY WATER PUMP SYSTEM. PROVIDE CONTROL CIRCUITING TO PRESSURE SWITCHES TO CONTROL THE MOTOR STARTER. A NEW NEMA 1 RATED STARTER MAY BE PROVIDED IN LIEU OF THE SALVAGED MOTOR CONTROL PANEL. NEW PRESSURE SWITCHES MAY BE PROVIDED IN LIEU OF THE SALVAGED PRESSURE SWITCHES.
- 7. THE CONTRACTOR SHALL PROVIDE POWER EQUIPMENT, INCLUDING 30A WP RECEPTACLE, UNIT SUBSTATION, GROUND ROD, AND ASSOCIATED CABLES AND CIRCUIT BREAKERS. PROVIDE LUMINARIES AND RECEPTACLE WITH ASSOCIATED SWITCH AND CABLES IN TRAILER INTERIOR.
- 8. PUMP OPERATION: PUMP SHALL BE CONTROLLED BY "PUMP ON" AND "PUMP OFF" PRESSURE SWITCHES. PUMP SHALL TURN ON WHEN LOW PRESSURE OF 80 PSI IS DETECTED AND REMAIN ON UNTIL HIGH PRESSURE OF 95 PSI IS DETECTED. AT 95 PSI PUMP SHALL TURN OFF AND REMAIN OFF UNTIL LOW PRESSURE OF 80 PSI IS DETECTED.
- 9. THE CONTRACTOR SHALL PROVIDE A 3/4" PLYWOOD WALL WITH DOOR AT REAR OF TRAILER. THE DOOR SHALL BE SECURABLE WITH A PADLOCK OR EQUAL MEANS. DRILL HOLES IN WALL FOR WATER PIPING AND ELECTRICAL CABLES. MOUNT THE 30A WP RECEPTACLE TO THE EXTERIOR SIDE OF THE PLYWOOD WALL.
- 10. SEE SHEET G6.0L FOR TEMPORARY WATER PUMP SINGLE LINE DIAGRAM.
- 11. THE CONTRACTOR SHALL CONSTRUCT AND TEST THE TEMPORARY PUMP SYSTEM TO ENSURE IT IS OPERATING AS INTENDED PRIOR TO SHUTTING OFF WATER TO THE PUMP STATION.



RECORD OF REVISIONS

No. DATE


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LUCAS M. CHAMBERS:

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LEE ST PUMP STATION RENOVATION


TEMPORARY WATER PUMP PLAN

G5.0L

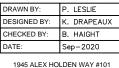OF

34

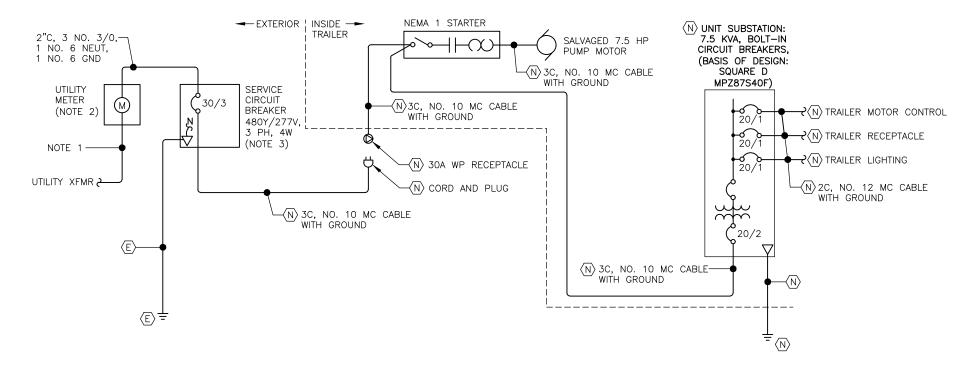- 1. AEL&P WILL REPLACE SERVICE CONDUCTORS.
- 2. REPLACE UTILITY METER SOCKET.
- 3. PROVIDE A TEMPORARY 30/3 SERVICE CIRCUIT BREAKER TO ENERGIZE THE TEMPORARY WATER PUMP TRAILER, REPLACE WITH A NEW 200/3 SERVICE CIRCUIT BREAKER FOR PERMANENT SERVICE.
- 4. PROVIDE TEMPORARY FEEDER CABLE WITH CORD AND PLUG CONNECTION FROM SERVICE CIRCUIT BREAKER TO
- 5. THE SHUTDOWN PERIOD SHALL NOT BE LONGER THAN 4 HOURS.



SINGLE LINE DIAGRAM - ELECTRICAL SERVICE SCALE: NOT TO SCALE

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RECORD OF REVISIONS

DESCRIPTION

CERTIFICATE OF AUTHORIZATION

DRAWN BY: P. LESLIE K. DRAPEAUX DESIGNED BY: HECKED BY: B. HAIGHT Sep-2020 1945 ALEX HOLDEN WAY #101

solutions@proHNS.com www.proHNS.com





LEE STREET PUMP STATION **RENOVATIONS**

BE21-122

TEMPORARY WATER PUMP SINGLE LINE DIAGRAM SHEET NUMBER **G6.0L**

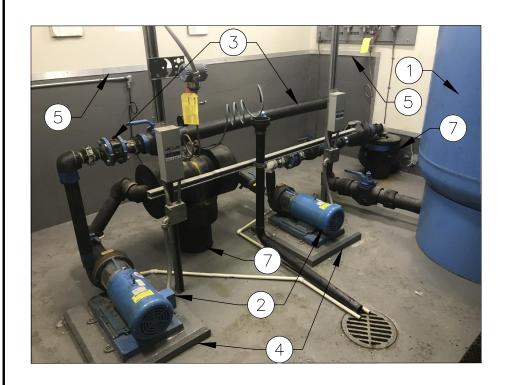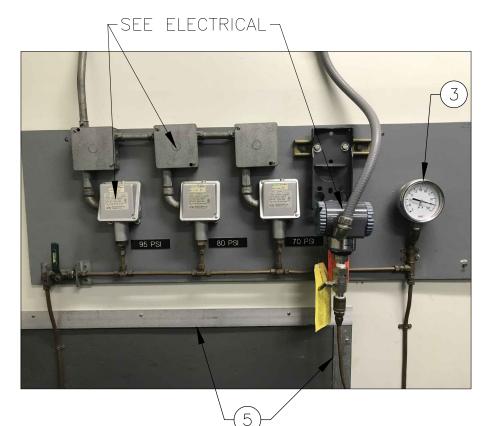
OF 34





DEMOLITION NOTES:

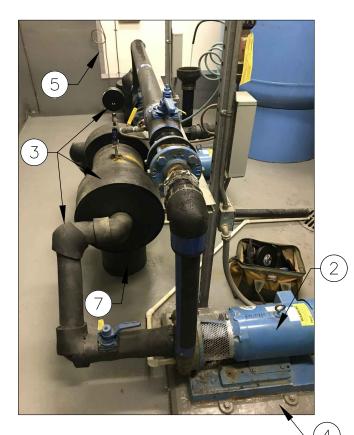- REMOVE AND SALVAGE EXISTING DIAPHRAGM PRESSURE TANK. DELIVER TO CBJ WATER DEPARTMENT SHOP AT 2520 BARRETT AVE. COORDINATE DELIVERY OF SALVAGED ITEMS WITH CBJ UTILITIES LONI VANKIRK (907-723-4975).
- 2. REMOVE AND SALVAGE EXISTING 7.5 HP PUMPS, MOTORS, AND BASE PLATES. REUSE SALVAGED ITEMS FOR TEMPORARY WATER PUMP SYSTEM. KEEP UNUSED 7.5 HP PUMP ONSITE FOR BACKUP.
- 3. REMOVE AND DISPOSE OF ALL EXISTING WATER PIPE, INSULATION, VALVES, FITTINGS, PRESSURE GAUGES AND SUPPORTS, EXCEPT AS NOTED IN NOTE 7 BELOW.
- 4. REMOVE AND DISPOSE OF EXISTING CONCRETE MOUNTING PAD. FLOOR SURFACE EXPOSED AFTER NEW PADS ARE INSTALLED SHALL MATCH SURROUNDING FLOOR ELEVATION AND TEXTURE, AND FINISH.
- 5. PAINT FLOOR TO LIMITS OF EXISTING FLOOR PAINT.
- 6. REMOVE AND DISPOSE OF EXISTING PRESSURE GAUGE AND PRESSURE SWITCH CONTROL FITTINGS ATTACHED TO THE 8" DI DISCHARGE PIPE PROTRUDING FROM THE FLOOR. INSTALL A BRASS PLUG IN EACH VOID.
- 7. PROTECT AND MAINTAIN EXISTING INITIAL 8" DI FLANGED SUCTION AND DISCHARGE PIPES PROTRUDING APPROXIMATELY 1' FROM THE FLOOR. ATTACH NEW DI PIPING TO EXISTING FLANGE.









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	DESIGNED BY:	L. CHAMBERS
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II.	DATE:	Sep-2020
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1945 ALEX HOLDEN WAY #101 JUNEAU, AK 99801



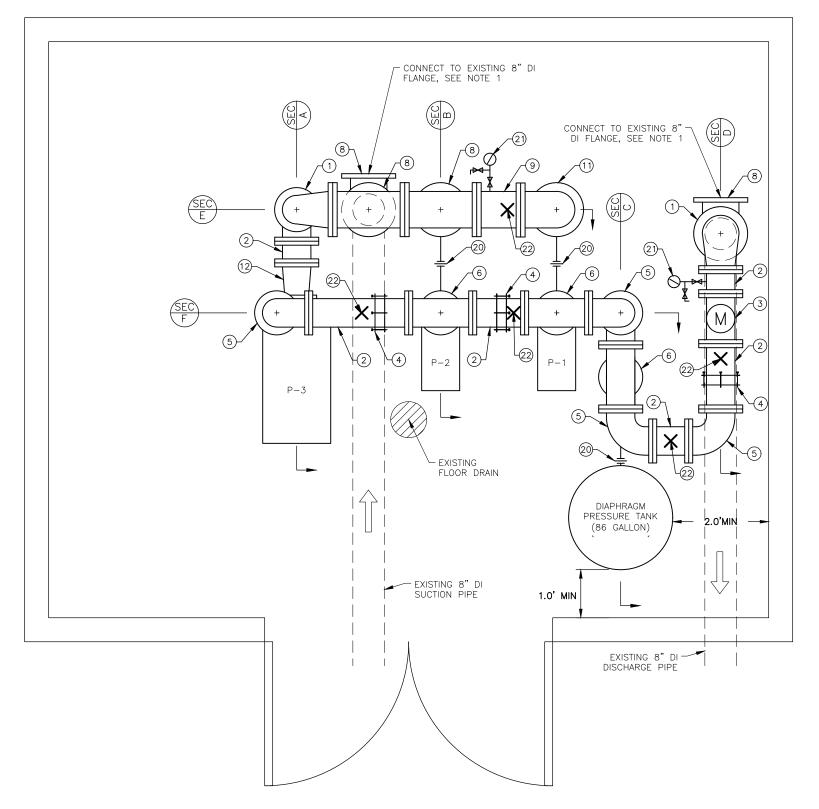
LEE ST PUMP STATION RENOVATION

PUMP & PIPING DEMOLITION PLAN

SHEET NUMBER
M1.OL

OF

34



LEE STREET PUMP STATION FLOOR PLAN

DRAWN BY:

DESIGNED BY:

CHECKED BY:

GENERAL SHEET NOTES:

- 1. INSTALL 8"X8" DI FLANGE TEE TO EXISTING DI FLANGE WITH NEW GASKET AND STAINLESS STEEL BOLTS. THE 8"X8" DI FLANGE TEE AND 8" GATE VALVE INSTALLED DIRECTLY ON THE EXISTING 8" DI FLANGES PROTRUDING THROUGH THE PUMP HOUSE FLOOR ARE TO FACILITATE THE TEMPORARY PUMPING PLAN AND WILL REMAIN IN PLACE PERMANENTLY. INSTALL AN 8" DI CAP AND GASKET ON THE 8"X8" DI FLANGE ONCE THE TEMPORARY PUMP PIPING HAS BEEN REMOVED.
- 2. INSULATE ALL WATER PIPE, VALVES AND FITTINGS WITH 1/2" ARMAFLEX FOAM INSULATION. INSTALL PER MANUFACTURERS RECOMMENDATIONS.
- 3. INDICATE DIRECTION OF FLOW WITH ARROWS ON WATER PIPE.
- 4. SEE PIPE SUPPORT DETAIL 3 ON SHEET M4.OL.
- 5. SEE PRESSURE GAUGE AND SAMPLING PORT ASSEMBLY DETAIL 1 ON SHEET M4.OL.
- 6. FLANGE COUPLING ADAPTER MAY BE SUBSTITUTED WITH A FLANGE SPOOL WITH APPROVAL BY THE ENGINEER.
- 7. CONTRACTOR RESPONSIBLE FOR VERIFYING PART QUANTITIES.

2	6" DI FLANGED PIPE
3	6" FLOW METER
4	6" DI FLANGE COUPLING ADAPTER *SEE NOTE 6 THIS SHEET
5	6" DI FLANGED PIPE 90° BEND
6	6"X6" DI FLANGED TEE
7	6"X4" DI FLANGED REDUCER
8	8'X8" DI FLANGED TEE
9	8" DI FLANGED PIPE
10	8" FLANGED COUPLING ADAPTER *SEE NOTE 6 THIS SHEET
11	8" DI FLAGED PIPE 90° BEND
12	6"X5" DI FLANGED ECCENTRIC REDUCER
13	6"X2" COMPANION FLANGE
14	8"X2" COMPANION FLANGE
15	2" BALL VLAVE
16	6" GATE VALVE
17	8" GATE VALVE
18	2" CHECK VALVE
19	6" CHECK VALVE
20	2" UNION
21	PRESSURE GAUGE & SAMPLING PORT
22	UNI STRUT PIPE SUPPORT LOCATION

PARTS LIST

1 8"x6" DI FLANGED REDUCING 90° ELBOW

	PUMP LIST	Ī
PUMP NO.	PUMP INFO	MOTOR INFO
P-1	1000 GPM, 170 FT HEAD	60 HP, 3,500 RPM
P-2	100 GPM, 160 FT HEAD	7.5 HP, 3,500 RPM
P-3	100 GPM, 160 FT HEAD	7.5 HP, 3,500 RPM

DATE

RECORD OF REVISIONS

DESCRIPTION

CERTIFICATE OF AUTHORIZATION





LEE ST PUMP STATION **RENOVATION**


PIPING PLAN


SHEET NUMBER M2.0L

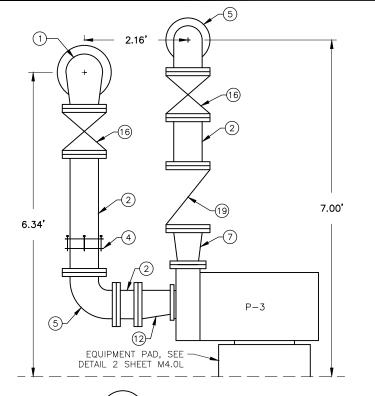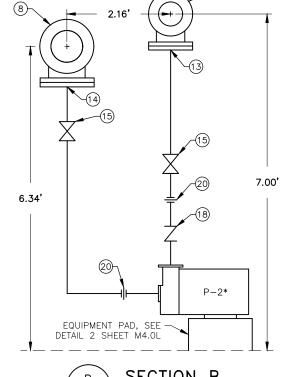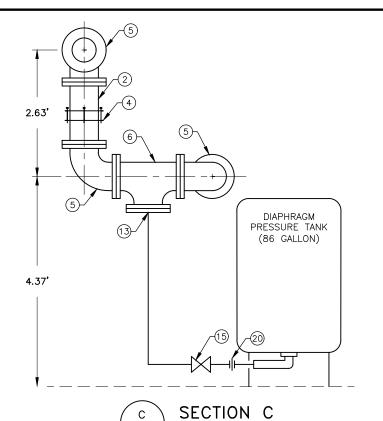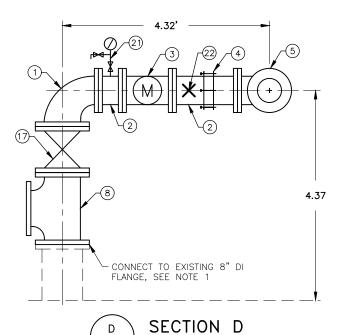OF 34











SECTION A

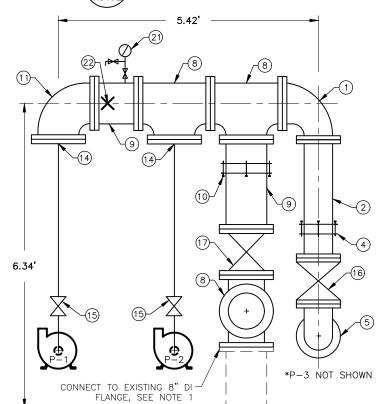

SECTION E



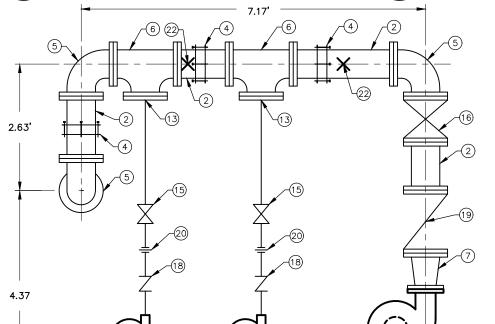

SECTION F

GENERAL SHEET NOTES:

- 1. INSTALL 8"X8" DI FLANGE TEE TO EXISTING DI FLANGE WITH NEW GASKET AND STAINLESS STEEL BOLTS. THE 8"X8" DI FLANGE TEE AND 8" GATE VALVE INSTALLED DIRECTLY ON THE THE PUMP HOUSE FLOOR ARE TO FACILITATE
 THE TEMPORARY PUMPING PLAN AND WILL REMAIN IN PLACE PERMANENTLY. INSTALL AN 8" DI CAP WITH GASKET ON THE 8"X8" DI FLANGE ONCE THE TEMPORARY PUMP PIPING HAS BEEN
- 2. INSULATE ALL WATER PIPE, VALVES AND FITTINGS WITH 1/2" ARMAFLEX FOAM INSULATION. INSTALL PER MANUFACTURERS RECOMMENDATIONS.
- 3. INDICATE DIRECTION OF FLOW WITH ARROWS ON WATER PIPE.
- 4. SEE PIPE SUPPORT DETAIL 3 ON SHEET M4.OL.
- 5. SEE PRESSURE GAUGE AND SAMPLING PORT ASSEMBLY DETAIL 1 ON SHEET M4.OL.
- 6. FLANGE COUPLING ADAPTER MAY BE SUBSTITUTED WITH A FLANGE SPOOL WITH APPROVAL BY THE ENGINEER.
- 7. CONTRACTOR RESPONSIBLE FOR VERIFYING PART QUANTITIES.

	PUMP LIST	Γ
PUMP NO.	PUMP INFO	MOTOR INFO
P-1	1000 GPM, 170 FT HEAD	60 HP, 3,500 RPM
P-2	100 GPM, 160 FT HEAD	7.5 HP, 3,500 RPM
P-3	100 GPM, 160 FT HEAD	7.5 HP, 3,500 RPM

	PARTS LIST
NO.	ITEM
1	8"x6" DI FLANGED REDUCING 90° ELBOW
2	6" DI FLANGED PIPE
3	6" FLOW METER
4	6" DI FLANGE COUPLING ADAPTER *SEE NOTE 6 THIS SHEET
5	6" DI FLANGED PIPE 90° BEND
6	6"X6" DI FLANGED TEE
7	6"X4" DI FLANGED REDUCER
8	8'X8" DI FLANGED TEE
9	8" DI FLANGED PIPE
10	8" FLANGED COUPLING ADAPTER *SEE NOTE 6 THIS SHEET
11	8" DI FLAGED PIPE 90° BEND
12	6"X5" DI FLANGED ECCENTRIC REDUCER
13	6"X2" COMPANION FLANGE
14	8"X2" COMPANION FLANGE
15	2" BALL VLAVE
16	6" GATE VALVE
17	8" GATE VALVE
18	2" CHECK VALVE
19	6" CHECK VALVE
20	2" UNION
21	PRESSURE GAUGE & SAMPLING PORT
22	UNI STRUT PIPE SUPPORT LOCATION

RECORD OF REVISIONS DATE DESCRIPTION



C.BYDLON L.CHAMBERS DESIGNED BY: CHECKED BY: J. DORN 1945 ALEX HOLDEN WAY #101 JUNEAU, AK 99801



LEE ST PUMP STATION **RENOVATION**


PIPING SECTIONS

SHEET NUMBER OF

BE21-122

M3.0L

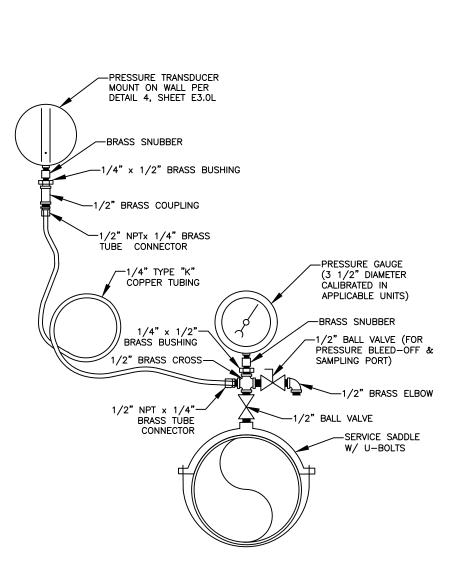34



-MOUNTING PLATE -NON-SHRINK GROUT STAINLESS STEEL EPOXY ANCHOR BOLT-DIAMETER TO BE 1/16" SMALLER THAN EQUIPMENT MOUNTING PLATE BOLT HOLE DIAMETER. BOLTS TO EXTEND 3" INTO CONCRETE FLOOR SLAB. -LEVELING NUT -TOOLED EDGES #4 @ 12" O.C.-EACH WAY #4 REBAR TIE BARS -HEIGHT VARIES AS NECESSARY TO LINE UP PUMP AND PIPING LAYOUT. CONCRETE -EXISTING CONCRETE FLOOR SLAB #4 CONCRETE ANCHORS @-12" O.C. EACH WAY -ROUGHEN CONCRETE (MIN OF 4), DOWELED AND EPOXY SECURED EQUIPMENT PAD SCALE: NOT TO SCALE M4.0L

MOUNT TO-CEILING -EXISTING CEILING HOT DIP-GALVANIZED UNISTRUT CLAMP BRACING PIPE-CLAMP 8" DIP--MOUNT TO FLOOR -EXISTING CONCRETE FLOOR SLAB

PRESSURE GAUGE & SAMPLING PORT ASSEMBLY SCALE: NOT TO SCALE

RECORD OF REVISIONS

DESCRIPTION

UNISTRUT PIPE SUPPORT SCALE: NOT TO SCALE

CERTIFICATE OF AUTHORIZATION

DRAWN BY: C.BYDLON L. CHAMBERS DESIGNED BY: CHECKED BY: J. DORN Sep-2020 1945 ALEX HOLDEN WAY #101 JUNEAU, AK 99801



LEE ST PUMP STATION **RENOVATION**

PIPE PLAN DETAILS

SHEET NUMBER M4.0L OF 34

BE21-122

DATE

LEGEND

VFD

XFMR

ABBREVIATIONS: ABOVE FINISHED FLOOR AFF ABOVE FINISHED GRADE AFG GFI GROUND FAULT INTERRUPTED HDG HOT-DIPPED GALVANIZED HUMAN MACHINE INTERFACE MDP MAIN DISTRIBUTION PANEL PHOTOELECTRIC CELL TB UH UNIT HEATER UNLESS OTHERWISE NOTED

VARIABLE FREQUENCY DRIVE

WEATHERPROOF

TRANSFORMER

POWER: DOUBLE DUPLEX RECEPTACLE J JUNCTION BOX CONDULET OR CONDUIT BODY MOTOR CONNECTION T THERMOSTAT, 46" AFF UNIT HEATER PRESSURE TRANSDUCER

SERVICE EQUIPMENT:

PANELBOARD

UTILITY METER

	CIRCUIT BREAKER
$\dashv\vdash$	CONTACT (N.O.)
_ _	DISCONNECT OR SWITCH
⊸ ∽	FUSE
$-\infty$	THERMAL RELAY
∇	GROUND BUS
<u></u>	GROUND ROD
M	METER
®	RELAY
₽	CURRENT TRANSFORMER
3/4	TRANSFORMER

DIAGRAM SYMBOLS:

LIGHTING:

- \	EXTERIOR WALL MOUNTED LUMINA
0	SURFACE MOUNT LUMINAIRE

LIGHTING CONTROLS:

SINGLE POLE SWITCH

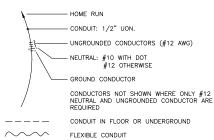
SHEET NOTE SYMBOLS:

Œ EXISTING TO REMAIN

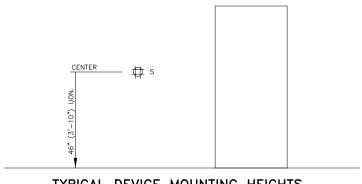
 $\langle N \rangle$

 $\langle R \rangle$ RELOCATE EXISTING $\langle X \rangle$ REMOVE EXISTING

CONDUIT & CONDUCTORS:







TYPICAL DEVICE MOUNTING HEIGHTS

NOTES:

1. HEIGHTS SHOWN ARE TYPICAL TO CENTERLINE OF BOX UNLESS OTHERWISE NOTED.

DATE

RECORD OF REVISIONS DESCRIPTION CERTIFICATE OF AUTHORIZATION

DRAWN BY: PEL DESIGNED BY: KHD CHECKED BY: BCH 5-22-2019 1945 ALEX HOLDEN WAY #101 JUNEAU, AK 99801

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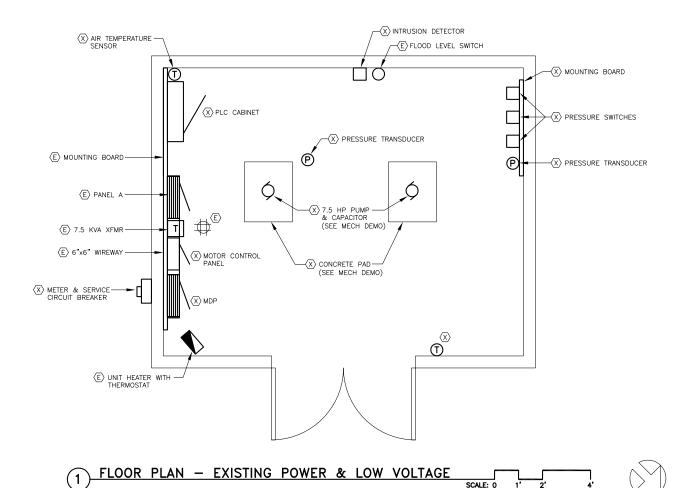



LEE STREET PUMP STATION **RENOVATIONS** BE21-122

City and Borough of Juneau

LEGEND, SCHEDULE

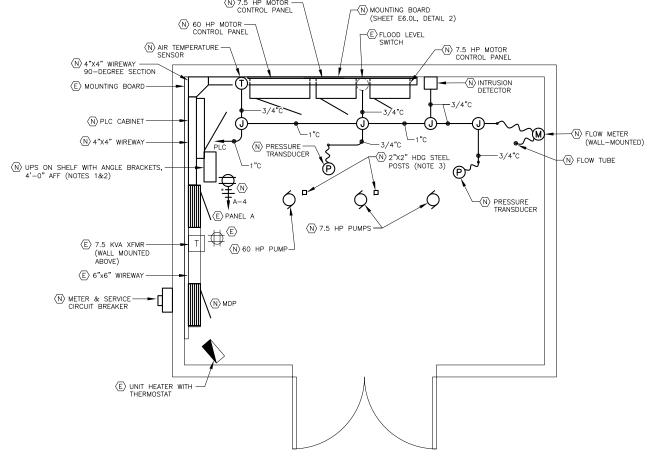SHEET NUMBER E1.0L OF 34





2 FLOOR PLAN - NEW POWER & LOW VOLTAGE SCALE: 0 1' 2' 4'



NOTES:

- NEW PLC CABINET SHALL BE POWERED FROM NEW UPS. UPS BASIS OF DESIGN: APC BACK-UPS CS 500.
- 2. UPS SHELF SHALL CONSIST OF (1 EA) 6"X15"X3/4" PLYWOOD AND (2 EA) SHELF BRACKETS (BASIS OF DESIGN: EATON B-LINE B888W).
- 3. PROVIDE (2 EA) 2"X2" HDG STEEL POSTS, BOLTED TO CEILING AND FLOOR. UTILIZE POSTS TO MOUNT PUMP MOTOR FEEDER CONDUITS FROM CEILING TO PUMP MOTOR TERMINATIONS.

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	DATE:	5-22-2019
•		LDEN WAY #101 , AK 99801

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LEE STREET PUMP STATION RENOVATIONS BE21-122


City and Borough of Juneau


FLOOR PLANS -POWER & LOW VOLTAGE

	SHEET NUMBER
	E2.0L
=	OF
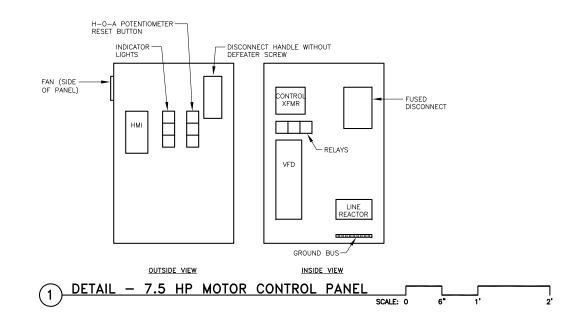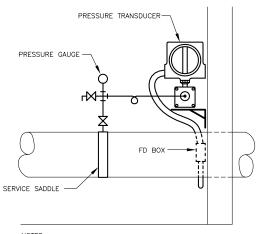
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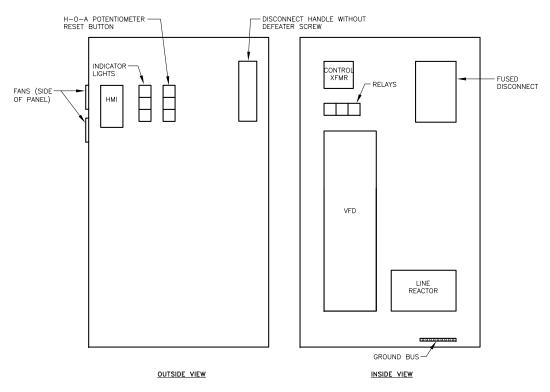
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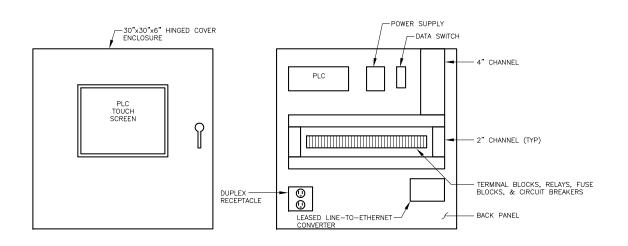


- ALL PIPING & APPURTENANCES SHALL BE RATED FOR 250 psi, MINIMUM.
- 2. THE CALIBRATION PORT SHALL BE 1/4" NPT.
- 3. PRESSURE GAUGE ASSEMBLY PER MECHANICAL DRAWINGS.

4 DETAIL - WATER PRESSURE TRANSMITTER MOUNTING (TYP)







OUTSIDE VIEW INSIDE VIEW 3 DETAIL - PLC CABINET

DATE



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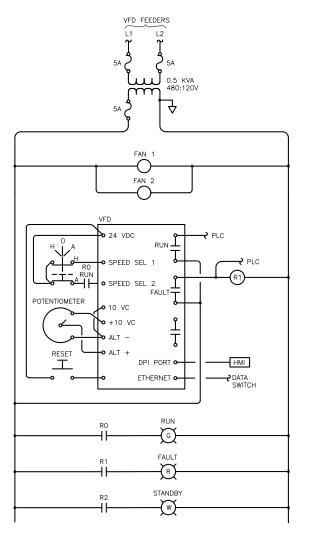


LEE STREET PUMP STATION **RENOVATIONS** BE21-122

City and Borough of Juneau

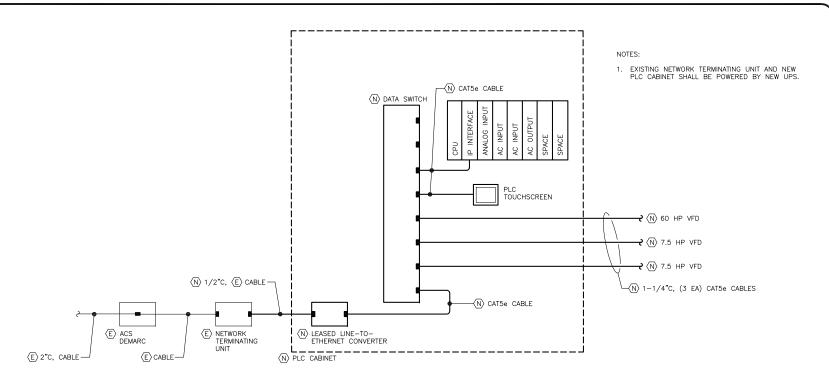
DETAILS

SHEET NUMBER E3.0L OF 34






DATE



2 SCHEMATIC DIAGRAM - SYSTEM NETWORK

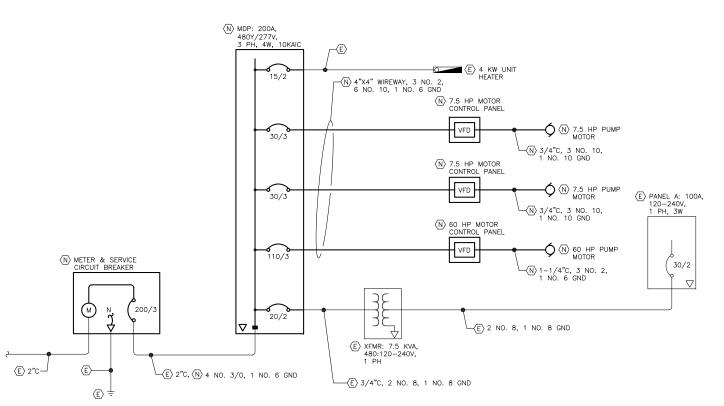

(1) SINGLE LINE DIAGRAM - POWER DISTRIBUTION SYSTEM
NO SCALE

- 1			
		DESIGNED BY	: KHD
		CHECKED BY:	всн
		DATE:	5-22-2019
	proHNS LLC		HOLDEN WAY EAU, AK 99801

CERTIFICATE OF AUTHORIZATION #100662

DRAWN BY: PEL ELECTRICAL ENGINEERS


LEE STREET PUMP STATION **RENOVATIONS** BE21-122


City and Borough of Juneau


SHEET NUMBER
E4.0L
OF

DIAGRAMS


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DESCRIPTION

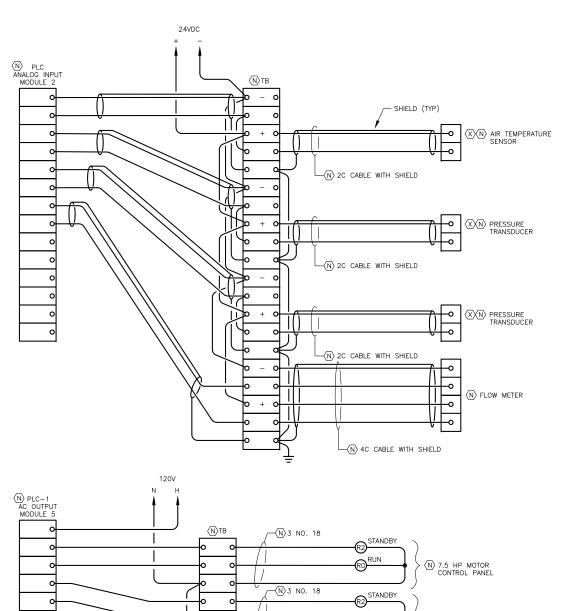

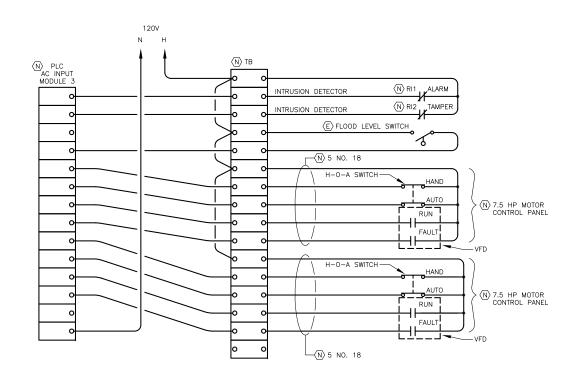WIRING DIAGRAM - PLC

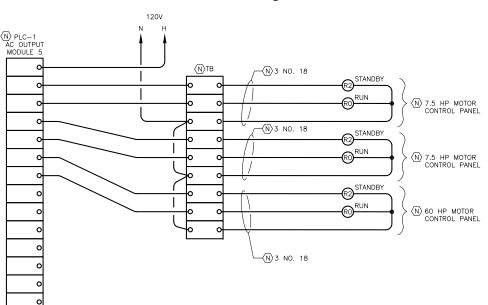NO SCALE

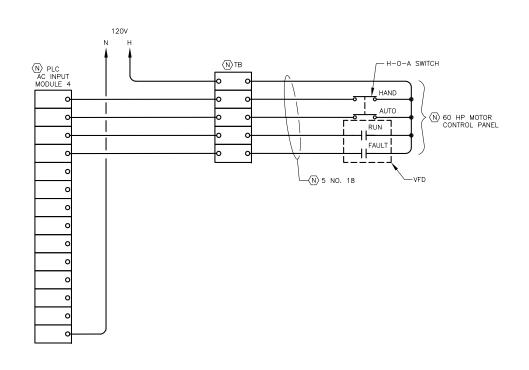To think

DATE

pro HNS LLC

CERTIFICATE OF AUTHORIZATION #100662

DRAWN BY: PEL

DESIGNED BY: KHD

CHECKED BY: BCH

DATE: 5-22-2019

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JUNEAU, AK 99801

solutions@proHNS.com www.proHNS.com



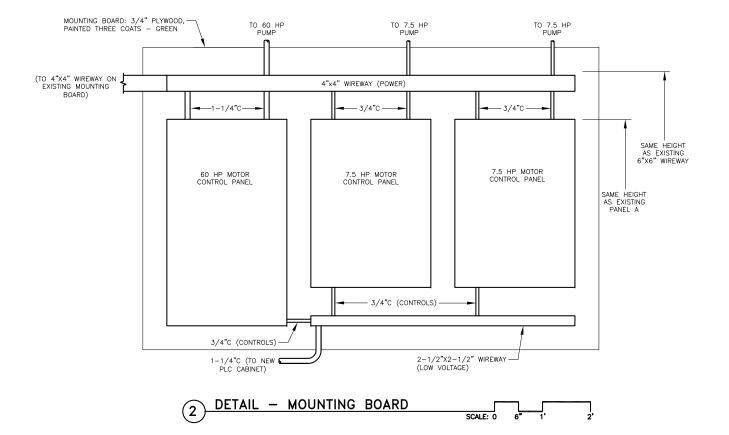
LEE STREET PUMP STATION RENOVATIONS BE21-122

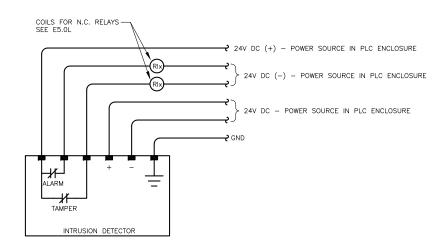
City and Borough of Juneau

PLC WIRING DIAGRAMS

SHEET NUMBER
E5.0L
OF

34





1) WIRING DIAGRAM - INTRUSION DETECTOR (TYP)

IO SCALE

SOLUTION OF THE SANGER

DATE

RECORD OF REVISIONS

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proHNS LLC

CERTIFICATE OF AUTHORIZATION #100662

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DATE: 5-22-2019

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JUNEAU, AK 99801

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CONSULTING

ELECTRICAL ENGINEERS LEE STREET PUMP STATION RENOVATIONS BE21-122

DIAGRAM AND DETAIL

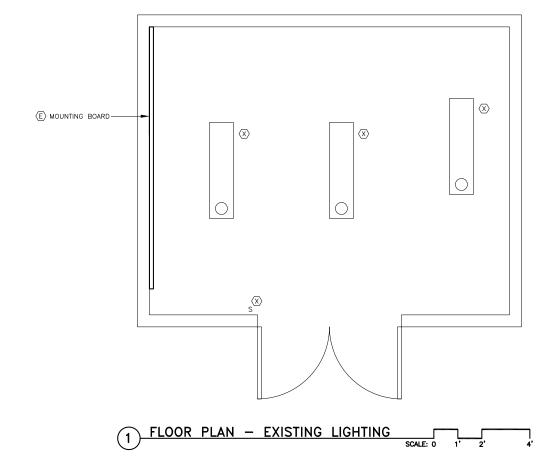
E6.0L

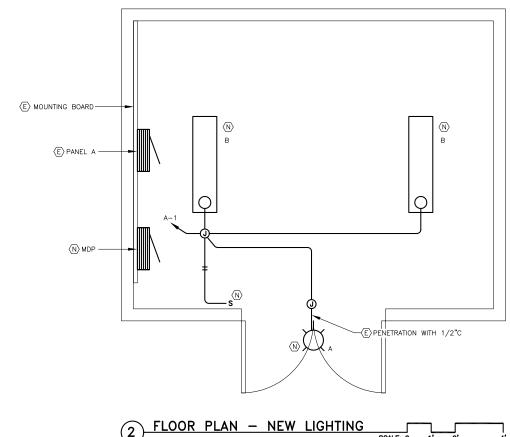
OF

34

City and Borough of Juneau

1. EXISTING CONDUITS AND JUNCTION BOXES MAY BE UTILIZED FOR NEW LIGHTING WHERE POSSIBLE. PROVIDE NEW CONDUCTORS.





2 FLOOR PLAN - NEW LIGHTING SCALE: 0 1' 2'



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LEE STREET PUMP STATION **RENOVATIONS** BE21-122

City and Borough of Juneau


FLOOR PLANS -LIGHTING

SHEET NUMBER
E7.0L
OF
34

BONNIE BRAE PUMP STATION RENOVATION

BE21-122

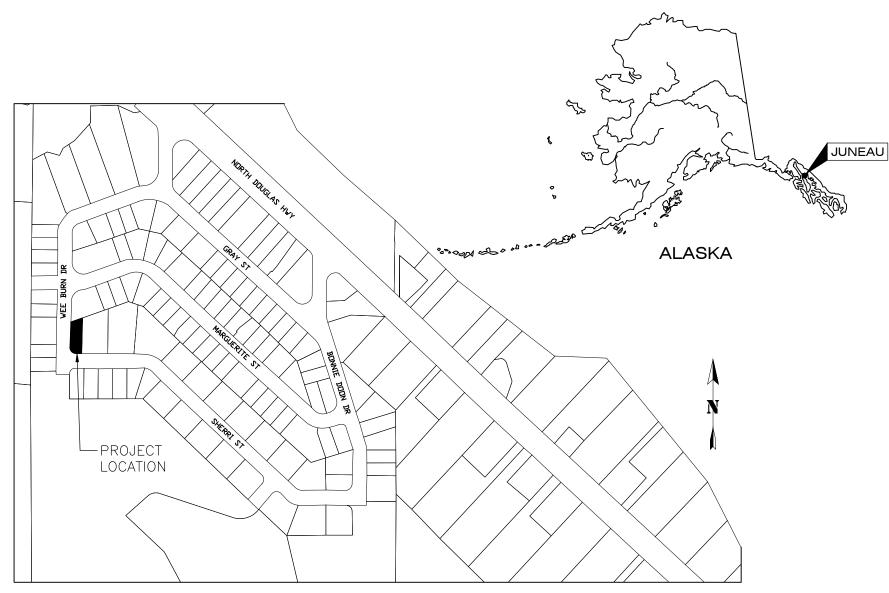CITY & BOROUGH OF JUNEAU, ALASKA



	SHEET INDEX
SHEET NO.	DESCRIPTION
GENERAL	
G3.0B	BONNIE BRAE COVER SHEET
G4.0B	SUBDIVISION OVERVIEW
G5.0B	TEMPORARY WATER SERVICE PLAN OVERVIEW
G6.0B	TEMPORARY WATER PUMP PLAN
G7.0B	TEMPORARY WATER PUMP SINGLE LINE DIAGRAM
MECHANICAL	
M1.0B	PUMP & PIPING DEMOLITION PLAN
M2.0B	PIPING PLAN
M3.0B	PIPING SECTIONS
M3.1B	PIPING SECTIONS
M4.0B	PIPE PLAN DETAILS
ELECTRICAL	
E1.0B	LEGEND, LUMINAIRE SCHEDULE
E2.0B	FLOOR PLAN — EXISTING & NEW POWER AND LOW VOLTAGE
E3.0B	DETAILS
E4.0B	SINGLE LINE DIAGRAMS
E5.0B	PLC WIRING DIAGRAMS
E6.0B	DIAGRAM AND DETAIL
E7.0B	FLOOR PLAN — EXISTING & NEW LIGHTING

PROJECT LOCATION MAP NTS

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	proHNS LLC	
	CERTIFICATE OF AUTHORIZATION #100662	

_	DRAWN BY:	L. CHAMBER
\sim	DESIGNED BY:	L. CHAMBER
	CHECKED BY:	G. GLADSJO
oroHNS LLC	1945 ALEX HOL JUNEAU,	DEN WAY #101 AK 99801
CERTIFICATE OF ALITHORIZATION	solutions@r	roHNS com

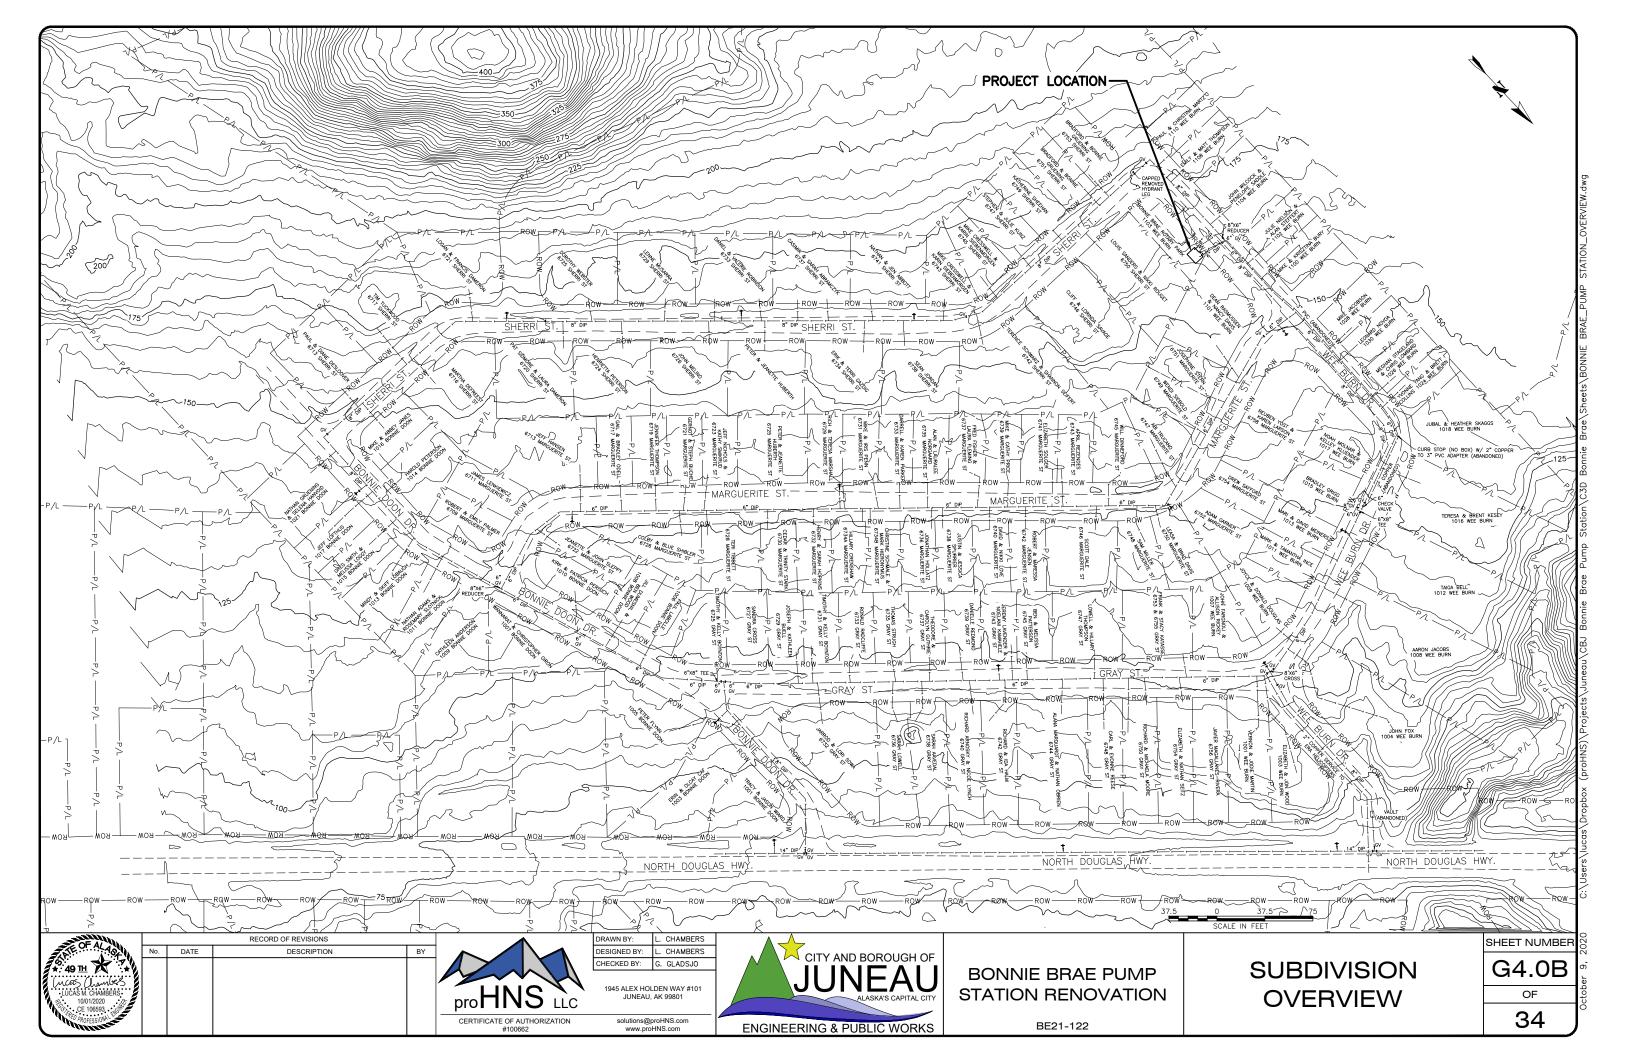


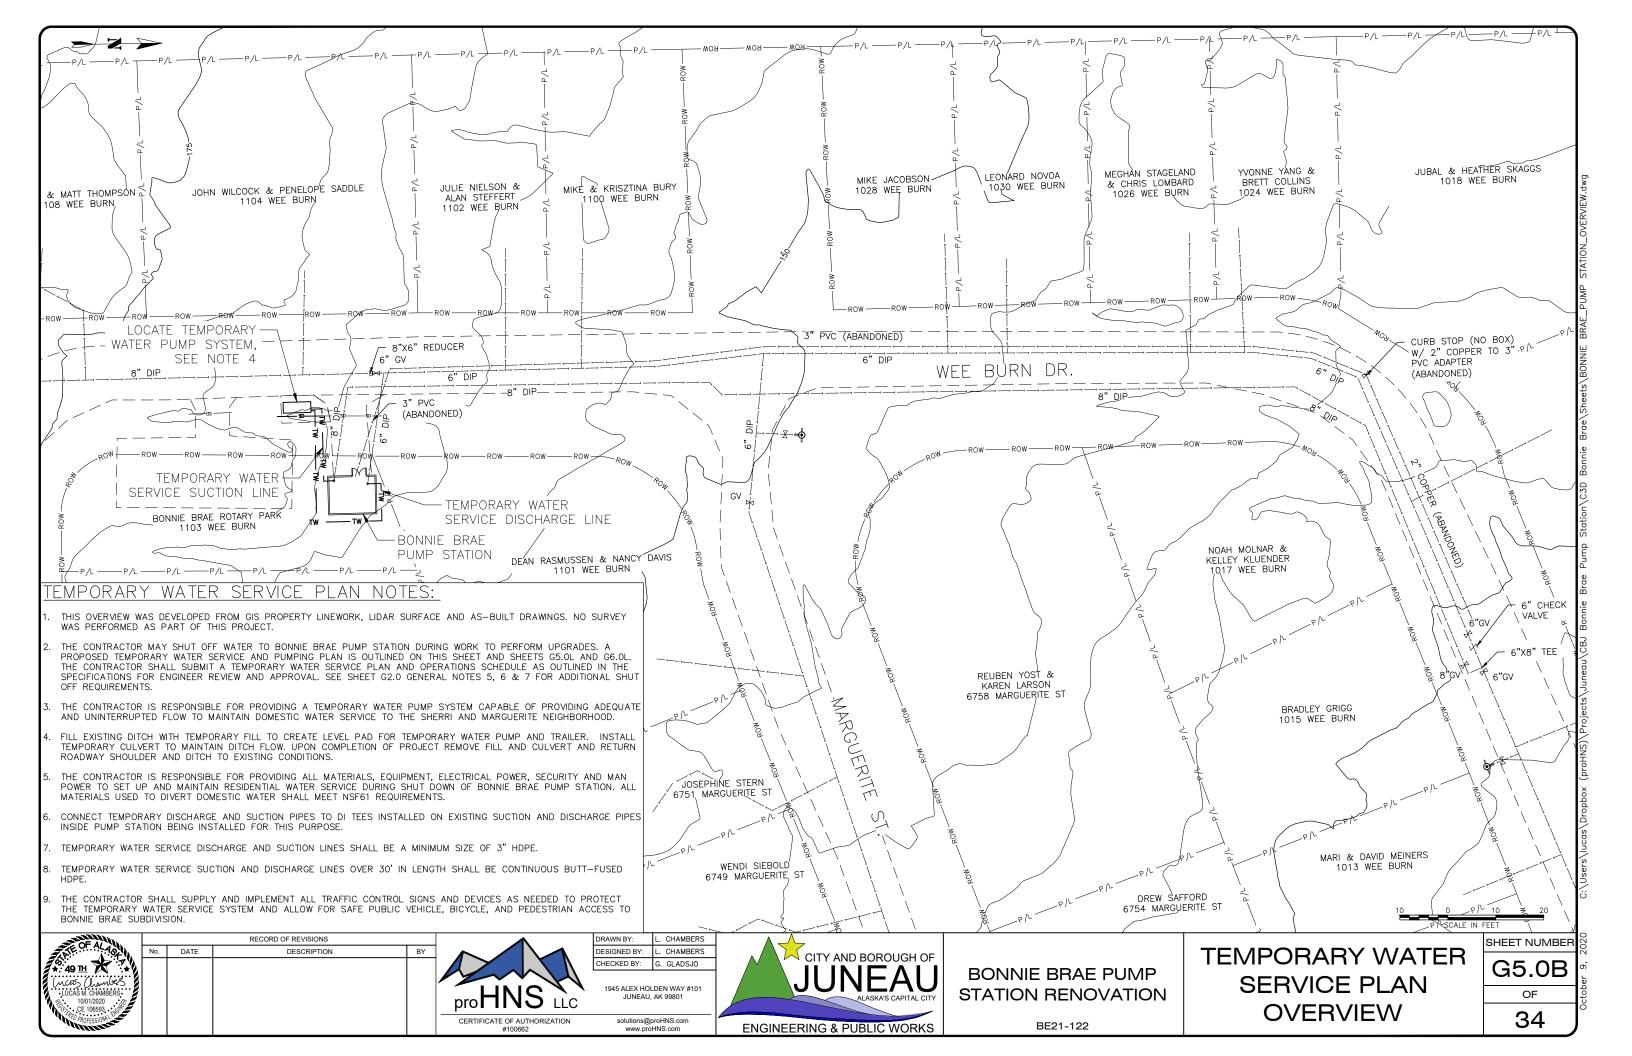
BONNIE BRAE PUMP STATION RENOVATION

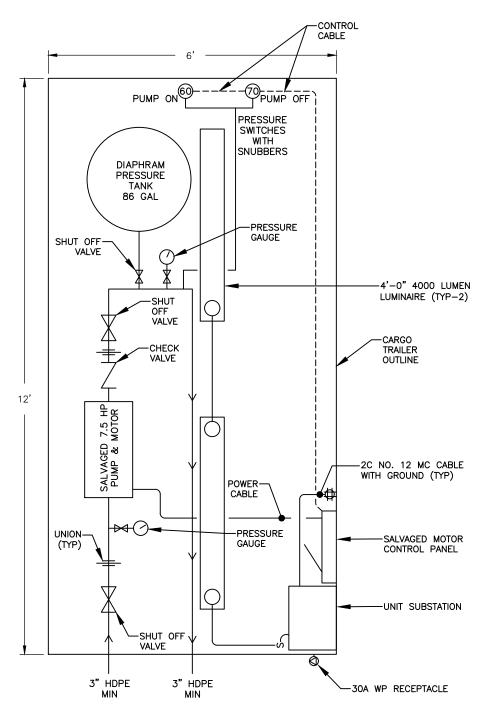
BONNIE BRAE COVER SHEET

SHEET NUMBER
G3.0B

34







TEMPORARY WATER PUMP AND TRAILER PLAN VIEW SCALE: NOT TO SCALE

TEMPORARY WATER PUMP NOTES:

- THE CONTRACTOR IS RESPONSIBLE FOR PROVIDING ALL MATERIALS, EQUIPMENT, ELECTRICAL POWER, SECURITY AND MAN POWER TO SET UP AND MAINTAIN THE TEMPORARY WATER PUMP.
- 2. THE CONTRACTOR SHALL UTILIZE THE TEMPORARY WATER PUMP AND TRAILER SET UP FROM THE LEE STREET PUMP STATION RENOVATION PROJECT FOR THIS PROJECT IN ORDER TO MAINTAIN WATER SUPPLY DURING THE BONNIE BRAE PUMP STATION RENOVATION. THE CONTRACTOR SHALL MAKE MODIFICATIONS AS NECESSARY TO THE TEMPORARY WATER PUMP AND TRAILER SET UP TO ENSURE THE SYSTEM WILL PROVIDE UNINTERRUPTED WATER SERVICE TO THE BONNIE BRAE SUBDIVISION DURING THE PROJECT
- 3. THE CONTRACTOR MAY PENETRATE THE EXTERIOR WALL TO ATTACH THE TEMPORARY SUCTION AND DISCHARGE PIPES TO THE PROPOSED DIP TEES INSTALLED ON THE SUCTION AND DISCHARGE PIPES INSIDE THE PUMP HOUSE. AFTER DECOMMISSIONING THE TEMPORARY PUMP RETURN EXTERIOR WALL TO EXISTING CONDITION. SEE PIPING PLAN ON SHEET M2.0B AND PIPING SECTIONS ON M3.0B AND M3.1B FOR DETAILS ON DIP TEE AND VALVE INSTALLED ON SUCTION AND DISCHARGE PIPES INSIDE THE PUMP HOUSE. THESE PARTS ARE BEING INSTALLED FOR FACILITATING THE TEMPORARY PUMPING PLAN.
- 4. THE CONTRACTOR SHALL PROVIDE AND INSTALL MATERIAL AND EQUIPMENT NECESSARY TO MITIGATE THE EFFECTS OF WATER HAMMER ON THE SYSTEM.
- 5. PUMP OPERATION: PUMP SHALL BE CONTROLLED BY "PUMP ON" AND "PUMP OFF" PRESSURE SWITCHES. PUMP SHALL TURN ON WHEN LOW PRESSURE OF 60 PSI IS DETECTED AND REMAIN ON UNTIL HIGH PRESSURE OF 70 PSI IS DETECTED. AT 70 PSI PUMP SHALL TURN OFF AND REMAIN OFF UNTIL LOW PRESSURE OF 60 PSI IS DETECTED.
- 6. SEE SHEET G7.0B FOR THE TEMPORARY WATER PUMP AND SINGLE LINE DIAGRAM.
- 7. THE CONTRACTOR SHALL CONSTRUCT AND TEST THE TEMPORARY PUMP SYSTEM TO ENSURE IT IS OPERATING AS INTENDED PRIOR TO SHUTTING OFF WATER TO THE PUMP STATION.
- 8. UPON COMPLETION OF THE PROJECT THE CONTRACTOR SHALL DELIVER THE CARGO TRAILER AND THE TEMPORARY WATER PUMP SYSTEM INCLUDING ELECTRICAL COMPONENTS TO CBJ WATER DEPARTMENT SHOP AT 2520 BARRET AVENUE. CBJ WILL ASSUME OWNERSHIP OF THE CARGO TRAILER AND TEMPORARY WATER PUMP SYSTEM. IT IS THE INTENT THAT THE TEMPORARY WATER SYSTEM WILL BE DECOMMISSIONED AND STORED FOR FUTURE USE AND THE CARGO TRAILER MAY BE USED INDEPENDENTLY. THE EXTERIOR WALLS SHALL NOT BE DAMAGED AS A RESULT OF INSTALLING THE TEMPORARY PUMP SYSTEM.



DESCRIPTION



DRAWN BY: L. CHAMBERS DESIGNED BY: L. CHAMBERS CHECKED BY: G. GLADSJO 1945 ALEX HOLDEN WAY #101 JUNEAU, AK 99801

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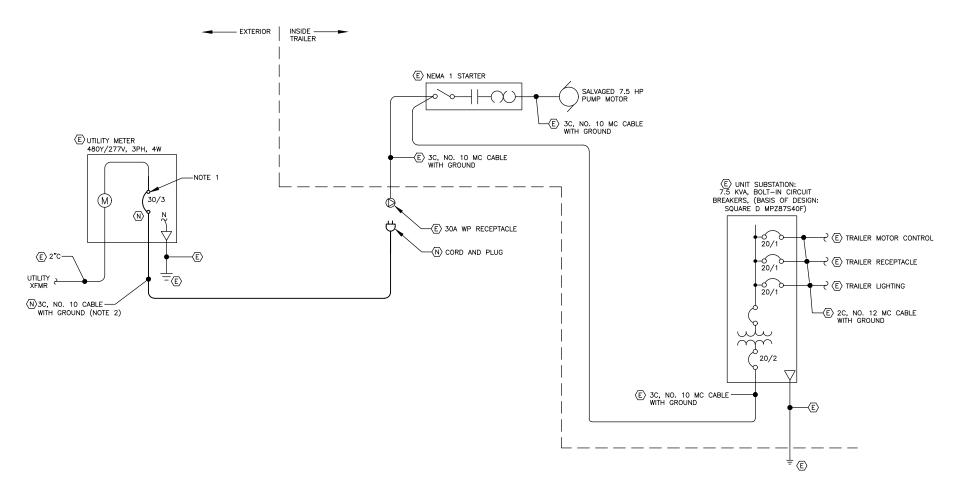
BONNIE BRAE PUMP STATION RENOVATION **TEMPORARY WATER** PUMP PLAN

SHEET NUMBER G6.0B

OF 34

SINGLE LINE DIAGRAM NOTES: (SHUTDOWN PERIOD)

- PROVIDE A TEMPORARY 30/3 SERVICE CIRCUIT BREAKER TO ENERGIZE THE TEMPORARY WATER PUMP TRAILER. REPLACE WITH THE EXISTING 100/3 SERVICE CIRCUIT BREAKER FOR PERMANENT SERVICE.
- PROVIDE TEMPORARY FEEDER CABLE WITH CORD AND PLUG CONNECTION FROM SERVICE CIRCUIT BREAKER TO TRAILER RECEPTACLE.
- 3. THE SHUTDOWN PERIOD SHALL NOT BE LONGER THAN 4 HOURS.



1) SINGLE LINE DIAGRAM - ELECTRICAL SERVICE

No. DATE

RECORD OF REVISIONS

DESCRIPTION

CERTIFICATE OF AUTHORIZATION #100662

DRAWN BY: P. LESLIE DESIGNED BY: K. DRAPEAUX CHECKED BY: B. HAIGHT

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BONNIE BRAE PUMP STATION RENOVATION

BE21-122

TEMPORARY WATER PUMP SINGLE LINE DIAGRAM SHEET NUMBER

G7.0B

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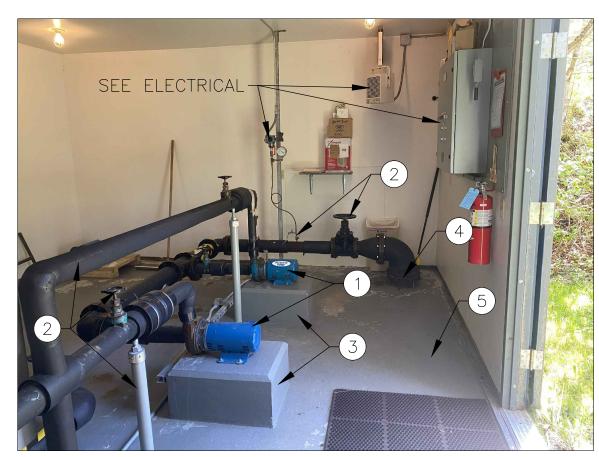
8" DUCTILE IRON SUCTION PIPE



6" DUCTILE IRON DISCHARGE PIPE

DEMOLITION NOTES:


- REMOVE AND SALVAGE EXISTING 5 HP PUMPS, MOTORS, AND BASE PLATES. DELIVER TO CBJ WATER DEPARTMENT SHOP AT 2520 BARRETT AVE. COORDINATE DELIVERY OF SALVAGED ITEMS WITH CBJ UTILITIES LONI VANKIRK (907-723-4975).
- 2. REMOVE AND DISPOSE OF ALL EXISTING WATER PIPE, INSULATION, VALVES, DIAPHRAGM PRESSURE TANK, FITTINGS, PRESSURE GAUGES, METER AND SUPPORTS, EXCEPT AS OUTLINED IN NOTE 4.
- 3. REMOVE AND DISPOSE OF CONCRETE MOUNTING PAD. FLOOR TO REMAIN EXPOSED AFTER NEW MOUNTING PADS ARE INSTALLED SHALL MATCH SURROUNDING FLOOR ELEVATION AND TEXTURE.
- 4. PROTECT AND MAINTAIN EXISTING INITIAL 8" DUCTILE IRON SUCTION AND 6" DUCTILE IRON DISCHARGE PIPES PROTRUDING APPROXIMATELY 12" FROM THE FLOOR. REMOVE RUST AND APPLY CORROSION PROTECTIVE COATING TO EXISTING DUCTILE IRON PIPE MEETING NSF 61. REMOVE EXISTING DUCTILE IRON MECHANICAL JOINT. ATTACH NEW DUCTILE IRON PIPING TO EXISTING PIPE WITH NEW MEGALUG MECHANICAL JOINT RESTRAINT FOR DIP.
- 5. PAINT FLOOR TO LIMITS OF EXISTING FLOOR PAINT.



FROM ENTRY WAY LOOKING RIGHT

RECORD OF REVISIONS

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FROM ENTRY WAY LOOKING LEFT
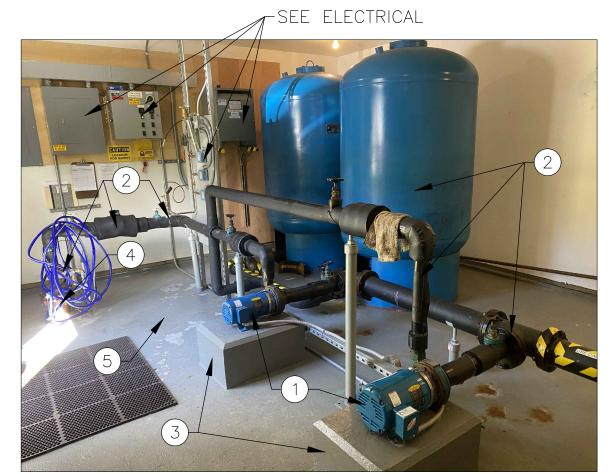
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LUCAS M. CHAMBERS		
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pro HNS LLC

CERTIFICATE OF AUTHORIZATION

DRAWN BY: L. CHAMBERS
DESIGNED BY: L. CHAMBERS
CHECKED BY: G. GLADSJO

1945 ALEX HOLDEN WAY #101 JUNEAU, AK 99801


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BONNIE BRAE PUMP STATION RENOVATION PUMP & PIPING DEMOLITION PLAN

M1.0B

of **34**




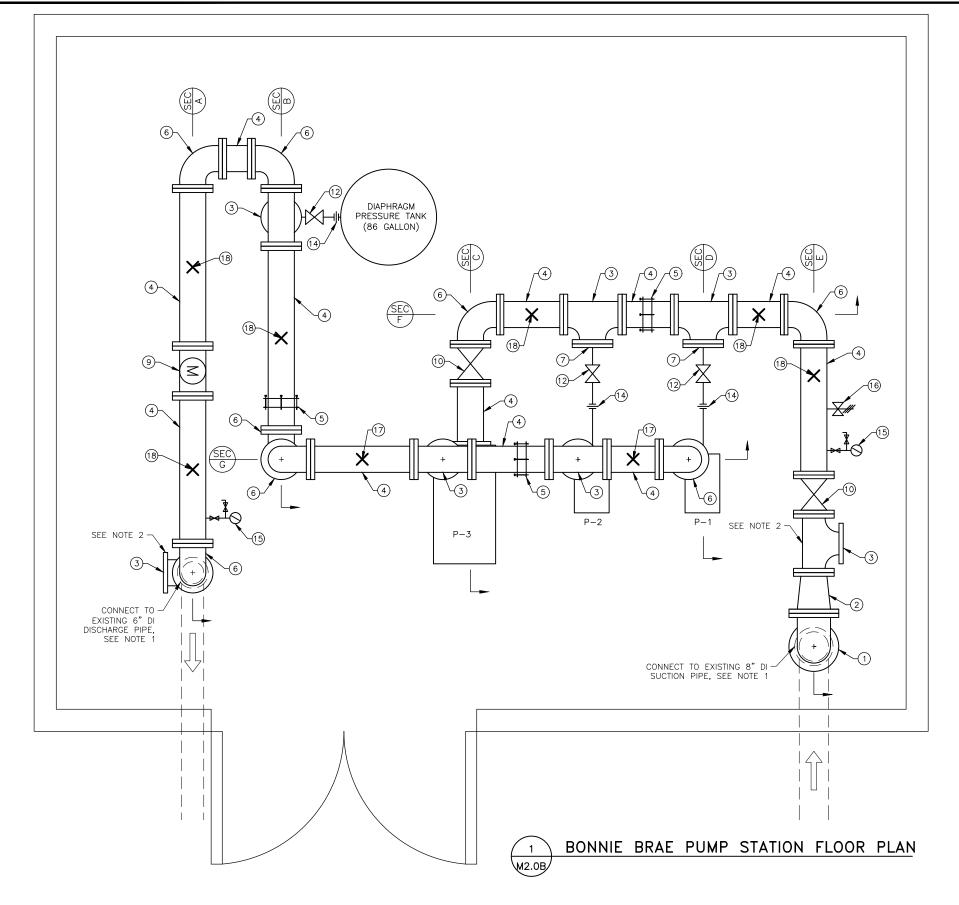GENERAL SHEET NOTES:


- 1. CONNECT TO EXISTING DIP WITH MEGALUG MECHANICAL JOINT RESTRAINT FOR DIP.
- 2. THE 6"X6" DI FLANGE TEE AND 6" GATE VALVE INSTALLED IN THESE LOCATIONS ARE TO FACILITATE THE TEMPORARY PUMPING PLAN AND WILL REMAIN IN PLACE PERMANENTLY. INSTALL A 6" DI CAP AND GASKET ON THE 6"X6" DI FLANGE ONCE THE TEMPORARY PUMP PIPING HAS BEEN REMOVED.
- 3. INSULATE ALL WATER PIPE, VALVES AND FITTINGS WITH 1/2" ARMAFLEX FOAM INSULATION. INSTALL PER MANUFACTURERS RECOMMENDATIONS.
- 4. INDICATE DIRECTION OF FLOW WITH ARROWS ON WATER PIPE.
- 5. SEE PIPE SUPPORT DETAIL 3 & 4 ON SHEET M4.0B.
- 6. SEE PRESSURE GAUGE AND SAMPLING PORT ASSEMBLY DETAIL 1 ON SHEET M4.0B.
- 7. FLANGE COUPLING ADAPTER MAY BE SUBSTITUTED WITH A FLANGE SPOOL WITH APPROVAL BY THE ENGINEER.
- 8. CONTRACTOR RESPONSIBLE FOR VERIFYING PART QUANTITIES.

PUMP LIST				
PUMP NO. PUMP INFO MOTOR INFO				
P-1	50 GPM, 95 FT HEAD	3 HP, 3500 RPM		
P-2 50 GPM, 95 FT HEAD		3 HP, 3500 RPM		
P-3	1000 GPM, 95 FT HEAD	30 HP, 1750 RPM		

	PARTS LIST
Ю.	ITEM
	8"x8" DI FLANGED 90° ELBOW
	8"X6" DI REDUCER
	6"X6" DI FLANGED TEE
	6" DI FLANGED PIPE
	6" DI FLANGE COUPLING ADAPTER *SEE NOTE 7 THIS SHEET
	6" DI FLANGED 90° ELBOW
	6"x2" COMPANION FLANGE
	6"x4" DI REDUCER
	6" FLOW METER
0	6" GATE VALVE
1	6" CHECK VALVE
2	2" BALL VALVE
3	2" CHECK VALVE
4	UNION
5	PRESSURE GUAGE & SAMPLING PORT
6	AIR RELEASE VALVE
7	UNI STRUT PIPE SUPPORT LOCATION
8	U-BOLT PIPE SUPPORT LOCATION

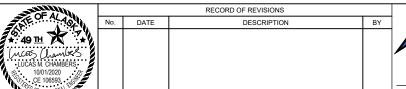



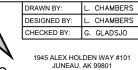

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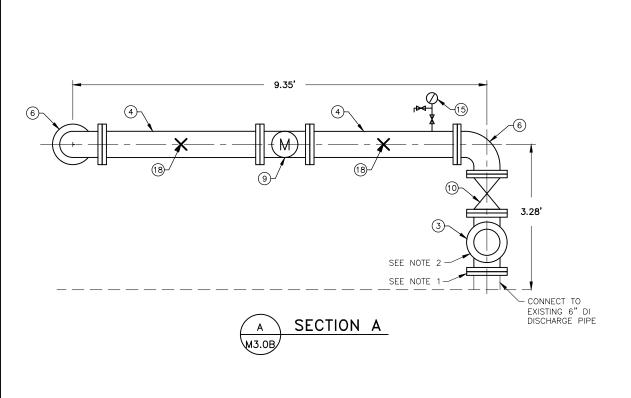



BONNIE BRAE PUMP STATION RENOVATION

PIPING PLAN


M2.0B

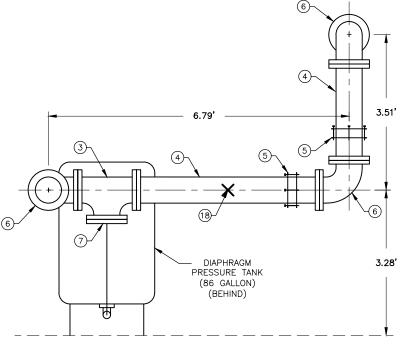
of 34





SECTION B

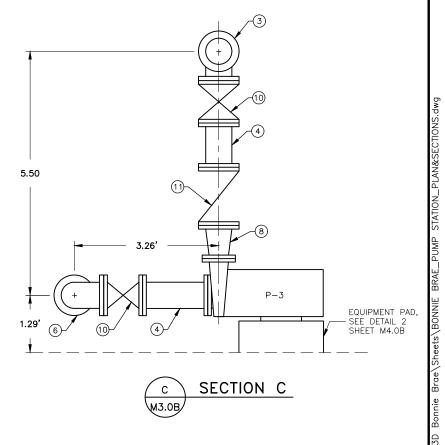

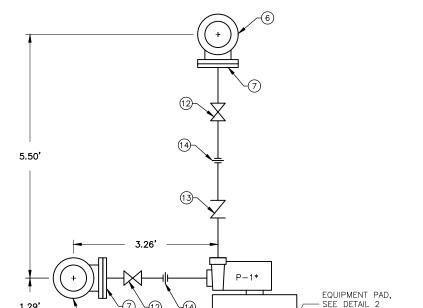


D SECTION D

M3.0B *INSTALL P-2 WITH SIMILAR LAYOUT

RECORD OF REVISIONS

DESCRIPTION

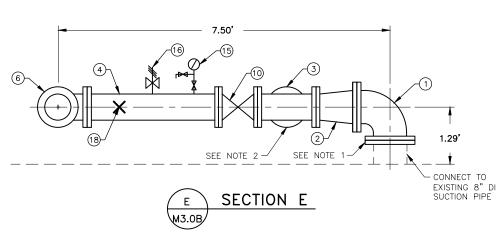DATE



GENERAL SHEET NOTES:

- 1. CONNECT TO EXISTING DIP WITH MEGALUG MECHANICAL JOINT RESTRAINT FOR DIP.
- 2. THE 6"X6" DI FLANGE TEE AND 6" GATE VALVE INSTALLED IN THESE LOCATIONS ARE TO FACILITATE THE TEMPORARY PUMPING PLAN AND WILL REMAIN IN PLACE PERMANENTLY. INSTALL A 6" DI CAP AND GASKET ON THE 6"X6" DI FLANGE ONCE THE TEMPORARY PUMP PIPING HAS BEEN REMOVED.
- 3. INSULATE ALL WATER PIPE, VALVES AND FITTINGS WITH 1/2" ARMAFLEX FOAM INSULATION. INSTALL PER MANUFACTURERS RECOMMENDATIONS.
- 4. INDICATE DIRECTION OF FLOW WITH ARROWS ON WATER PIPE.
- 5. SEE PIPE SUPPORT DETAIL 3 & 4 ON SHEET M4 OR
- 6. SEE PRESSURE GAUGE AND SAMPLING PORT ASSEMBLY DETAIL 1 ON SHEET M4.0B.
- 7. FLANGE COUPLING ADAPTER MAY BE SUBSTITUTED WITH A FLANGE SPOOL WITH APPROVAL BY THE ENGINEER.
- 8. CONTRACTOR RESPONSIBLE FOR VERIFYING PART QUANTITIES.

PUMP LIST			
PUMP NO.	PUMP INFO	MOTOR INFO	
P-1	50 GPM, 95 FT HEAD	3 HP, 3500 RPM	
P-2	50 GPM, 95 FT HEAD	3 HP, 3500 RPM	
P-3	1000 GPM, 95 FT HEAD	30 HP, 1750 RPM	

PARTS LIST				
NO. ITEM				
1	8"x8" DI FLANGED 90° ELBOW			
2	8"X6" DI REDUCER			
3	6"X6" DI FLANGED TEE			
4	6" DI FLANGED PIPE			
5	6" DI FLANGE COUPLING ADAPTER *SEE NOTE 7 THIS SHEET			
6	6" DI FLANGED 90° ELBOW			
7	6"x2" COMPANION FLANGE			
8	6"x4" DI REDUCER			
9	6" FLOW METER			
10	6" GATE VALVE			
11	6" CHECK VALVE			
12	2" BALL VALVE			
13	2" CHECK VALVE			
14	UNION			
15	PRESSURE GUAGE & SAMPLING PORT			
16	AIR RELEASE VALVE			
17	UNI STRUT PIPE SUPPORT LOCATION			
18	U-BOLT PIPE SUPPORT LOCATION			

CE 106593

proHNS LLC

CERTIFICATE OF AUTHORIZATION #100662

SHEET M4.0B

DRAWN BY: L. CHAMBERS
DESIGNED BY: L. CHAMBERS
CHECKED BY: G. GLADSJO

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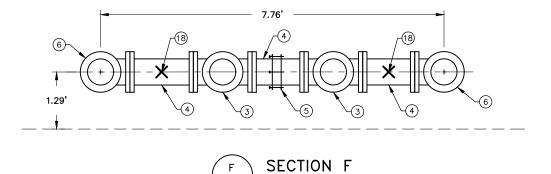
BONNIE BRAE PUMP STATION RENOVATION


PIPING SECTIONS

M3.0B

of

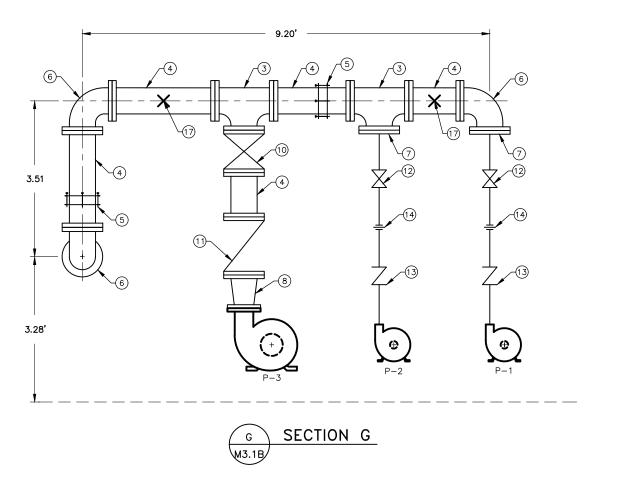34





GENERAL SHEET NOTES:

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13	2" CHECK VALVE			
14	UNION			
15	PRESSURE GUAGE & SAMPLING PORT			
16	16 AIR RELEASE VALVE			
17	UNI STRUT PIPE SUPPORT LOCATION			
18	U-BOLT PIPE SUPPORT LOCATION			



DATE

RECORD OF REVISIONS

DESCRIPTION

pro HNS LLC

CERTIFICATE OF AUTHORIZATION #100662

DRAWN BY: L. CHAMBERS
DESIGNED BY: L. CHAMBERS
CHECKED BY: G. GLADSJO

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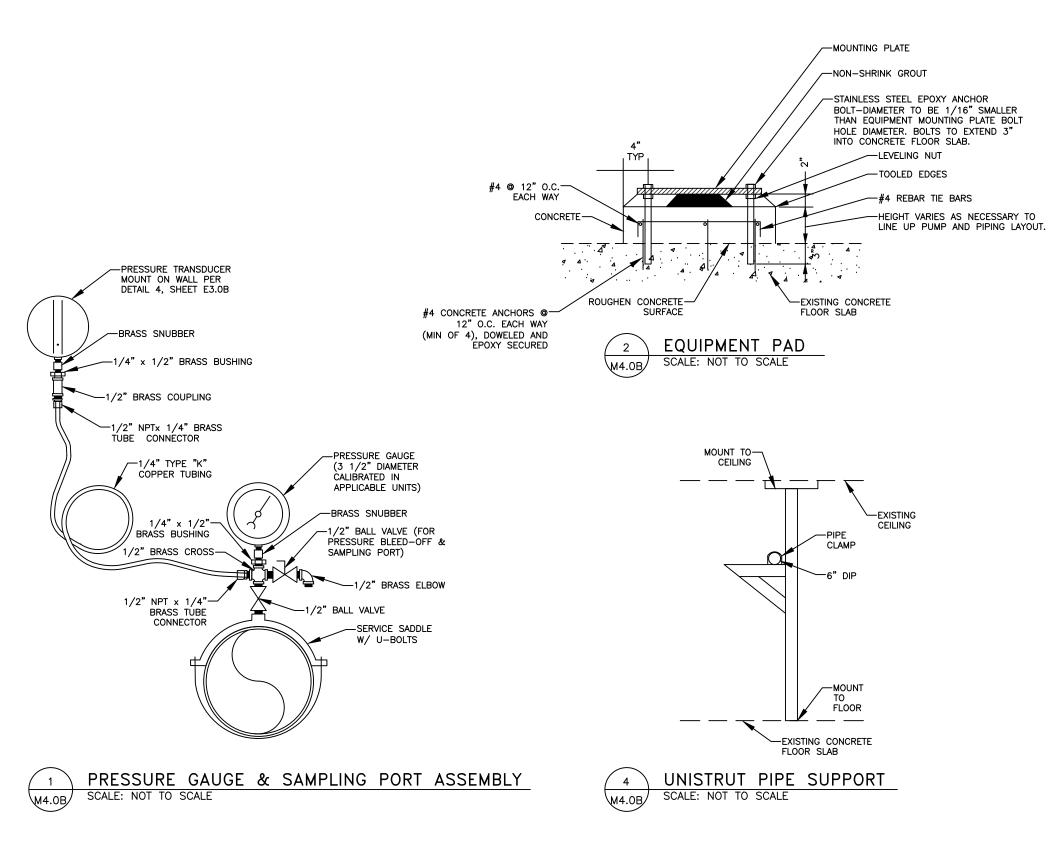
BONNIE BRAE PUMP STATION RENOVATION


PIPING SECTIONS


M3.1B


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DESCRIPTION

DATE

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BONNIE BRAE PUMP STATION RENOVATION

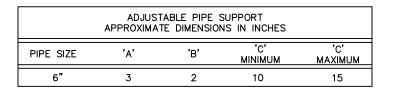PIPE PLAN DETAILS

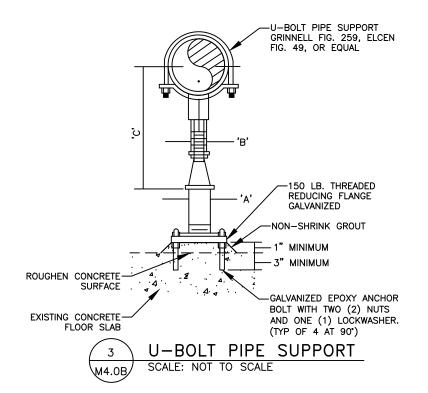SHEET NUMBER M4.0B OF

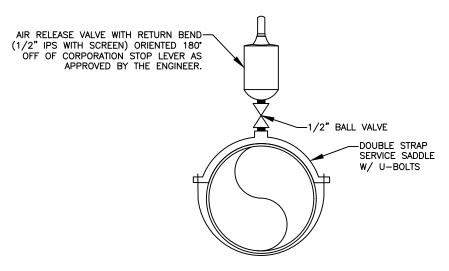BE21-122

34

LEGEND

RECORD OF REVISIONS

DESCRIPTION

LEGENL)		
ABBREVI.	ATIONS:	POWER:	
AFF	ABOVE FINISHED FLOOR	Ф	DUPLEX RECEPTACLE
AFG	ABOVE FINISHED GRADE	J	JUNCTION BOX
GFI	GROUND FAULT INTERRUPTED	©	CONDULET OR CONDUIT BODY
HDG	HOT-DIPPED GALVANIZED	Ó	MOTOR CONNECTION
НМІ	HUMAN MACHINE INTERFACE	T	THERMOSTAT, 46" AFF
MDP	MAIN DISTRIBUTION PANEL		UNIT HEATER
PE	PHOTOELECTRIC CELL	P	PRESSURE TRANSDUCER
TB	TERMINAL BOARD		
UH	UNIT HEATER		
UON	UNLESS OTHERWISE NOTED	SERVICE	EQUIPMENT:
VFD	VARIABLE FREQUENCY DRIVE		PANELBOARD
WP	WEATHERPROOF		UTILITY METER
XFMR	TRANSFORMER		

	LUM	INAIRE SCHEDULE	·	
TYPE	DESCRIPTION	MANUFACTURER	LAMPS	REMARKS
А	EXTERIOR WALL SCONCE, LED, DIE—CAST ALUMINUM HOUSING, TEMPERED GLASS LENS, VISUAL FORWARD THROW DISTRIBUTION, INTEGRAL ELECTRONIC DRIVER, 120V, 1500 LUMENS, BUTTON STYLE PHOTOELECTRIC CELL, PIR MOTION/AMBIENT LIGHT SENSOR, DARK BRONZE FINISH	LITHONIA LIGHTING WSTLED P1 30K VW 120V PE PIR DDBXD	14W WHITE LED 3000K, CRI 80	ABOVE DOOR AT THE SAME HEIGHT AS EXISTING CONDUIT PENETRATION.
В	4' SURFACE MOUNTED LINEAR LED ENCLOSED INDUSTRIAL, FIBERGLASS HOUSING, RIBBED FROSTED ACRYLIC LENS, HIGH LUMEN OUTPUT, INTEGRAL ELECTRONIC DRIVER, 120–277V	COLUMBIA LIGHTING LXEM4-35HL-RFA-EU	47W WHITE LED 3500K, CRI 80	

LIGHTING:

EXTERIOR WALL MOUNTED LUMINAIRE SURFACE MOUNT LUMINAIRE SURFACE MOUNT LUMINAIRE

LIGHTING CONTROLS:

SINGLE POLE SWITCH

SHEET NOTE SYMBOLS:

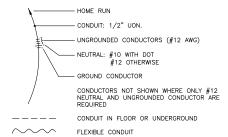
Œ EXISTING TO REMAIN

 $\langle N \rangle$

 $\langle \mathbb{R} \rangle$ RELOCATE EXISTING

 $\langle \times \rangle$ REMOVE EXISTING

CONDUIT & CONDUCTORS:



CENTER — (s

TYPICAL DEVICE MOUNTING HEIGHTS

NOTES:

1. HEIGHTS SHOWN ARE TYPICAL TO CENTERLINE OF BOX UNLESS OTHERWISE NOTED.

Potential Control of the Asian	
SEPTO	

DATE

CERTIFICATE OF AUTHORIZATION #100662

DRAWN BY: REJ DESIGNED BY: KHD CHECKED BY: BCH 9-22-2020

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HAIGHT CONSULTING ELECTRICAL ENGINEERS

DIAGRAM SYMBOLS:

I (M) ® ← mm

CIRCUIT BREAKER

DISCONNECT OR SWITCH

CURRENT TRANSFORMER

CONTACT (N.O.)

THERMAL RELAY

GROUND BUS

GROUND ROD

TRANSFORMER

METER

RELAY

BONNIE BRAE PUMP STATION RENOVATIONS BE21-122

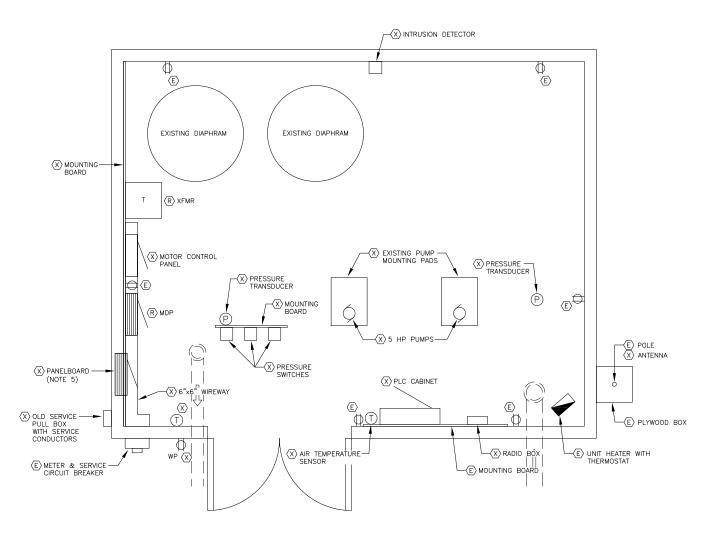
City and Borough of Juneau

LEGEND, LUMINAIRE **SCHEDULE**

SHEET NUMBER
E1.0B
OF
34


NOTE

- NEW PLC CABINET SHALL BE POWERED FROM NEW UPS. UPS BASIS OF DESIGN: APC BACK-UPS CS 500.
- UPS SHELF SHALL CONSIST OF (1 EA) 6"X15"X3/4" PLYWOOD AND (2 EA) SHELF BRACKETS (BASIS OF DESIGN: EATON B-LINE B888W).
- 3. PROVIDE (3 EA) 2"X2" HDG STEEL POSTS, BOLTED TO CEILING AND FLOOR. UTILIZE POSTS TO MOUNT PUMP MOTOR FEEDER CONDUITS FROM CEILING TO PUMP MOTOR TERMINATIONS.
- 4. PROVIDE A JUNCTION BOX TO INTERCEPT AND EXTEND THE EXISTING RECEPTACLE AND UNIT HEATER CIRCUITS TO THE NEW PANELBOARD.
- REPAIR AND PATCH WALL TO MATCH EXISTING WALL CONSTRUCTION AFTER REMOVING EXISTING PANELBOARD.
- 6. CUT HOLE IN NEW MOUNTING BOARD TO ALLOW ACCESS TO EXISTING DUPLEX RECEPTACLE.



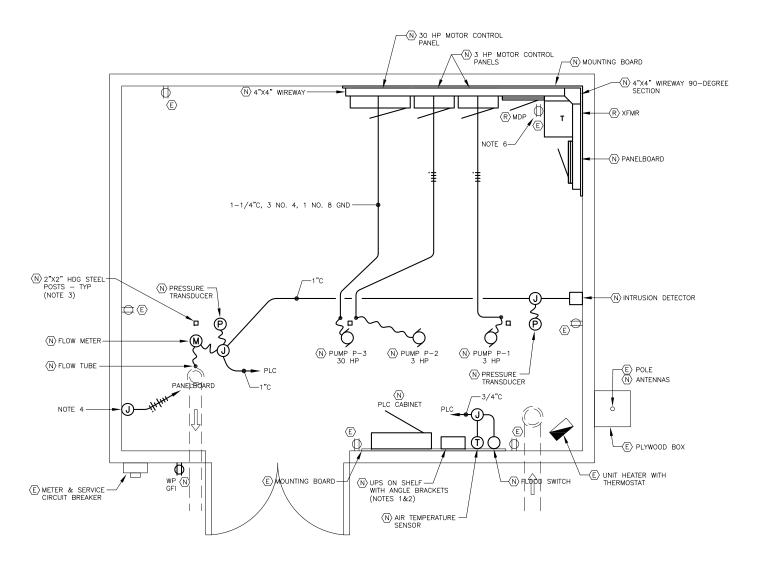1 FLOOR PLAN - EXISTING POWER & LOW VOLTAGE SCALE: 0 1' 2' 4'





2 FLOOR PLAN - NEW POWER & LOW VOLTAGE

SCALE: 0 1' 2' 4'



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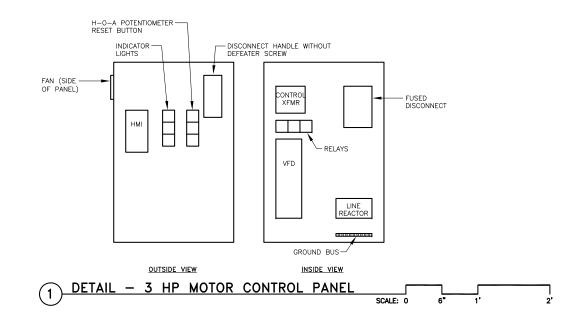
BONNIE BRAE PUMP STATION RENOVATIONS BE21-122


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FLOOR PLAN - EXISTING & NEW POWER AND LOW VOLTAGE

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3	E2.0B

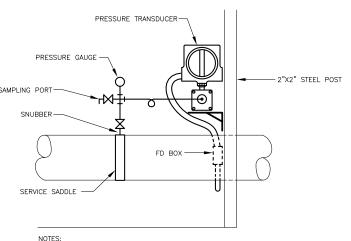
OF 34






- ALL PIPING & APPURTENANCES SHALL BE RATED FOR 250 psi, MINIMUM.
- 2. THE CALIBRATION PORT SHALL BE 1/4" NPT.
- 3. PRESSURE GAUGE ASSEMBLY PER MECHANICAL DRAWINGS.

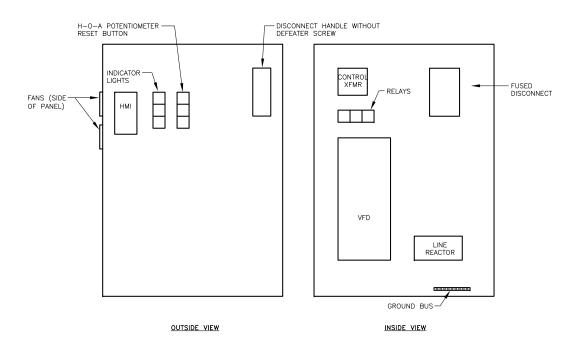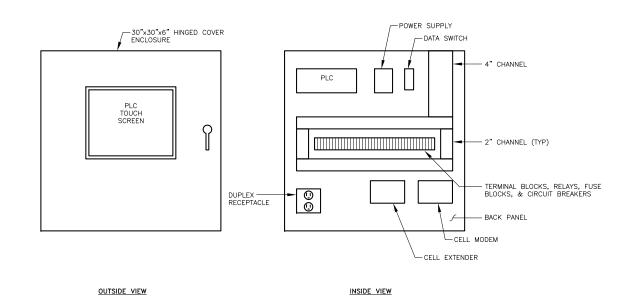4 DETAIL - WATER PRESSURE TRANSMITTER MOUNTING (TYP)







3 DETAIL - PLC CABINET

11.03			RECORD OF REVISIONS	
OF ALTON	No.	DATE	DESCRIPTION	BY
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2 SEPT U				



	DRAWN BY:	REJ
	DESIGNED BY:	KHD
	CHECKED BY:	всн
7	DATE:	9-22-2020
		LDEN WAY #101 . AK 99801

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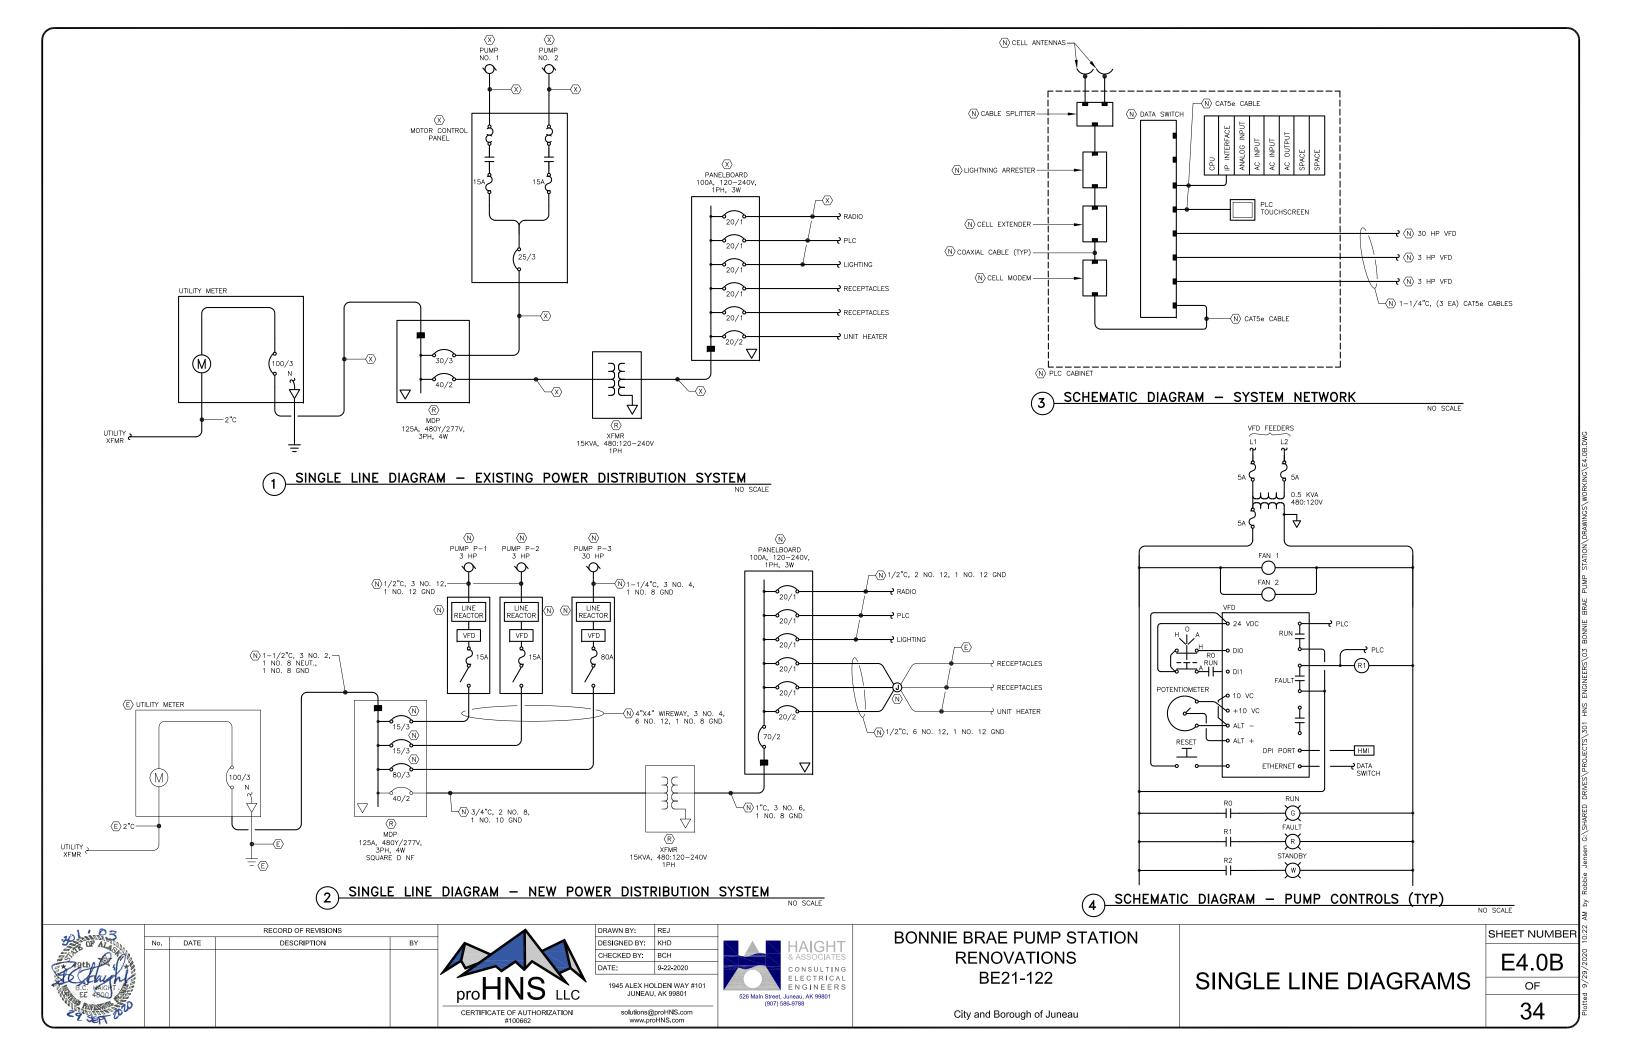



BONNIE BRAE PUMP STATION RENOVATIONS BE21-122


City and Borough of Juneau


DETAILS

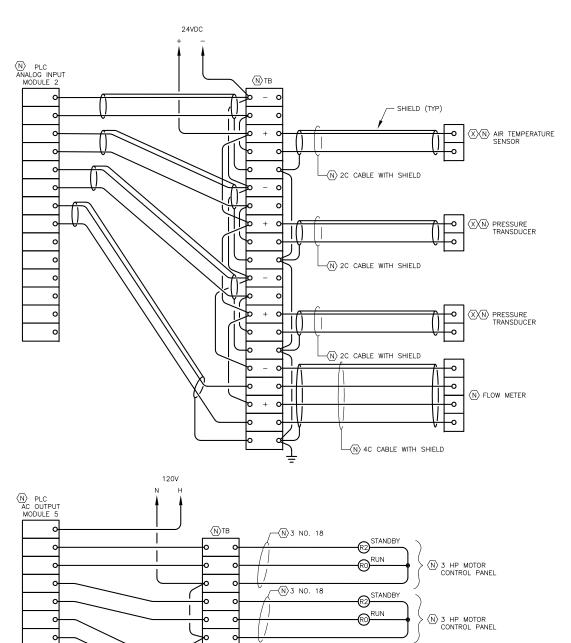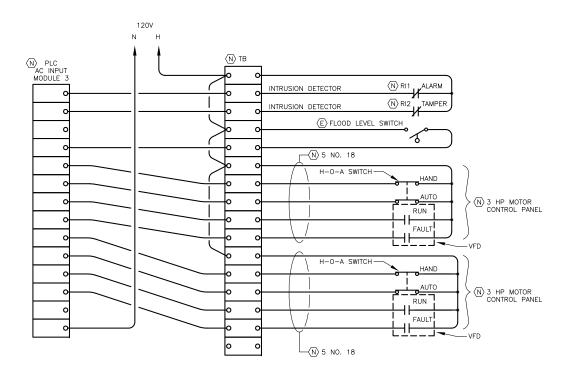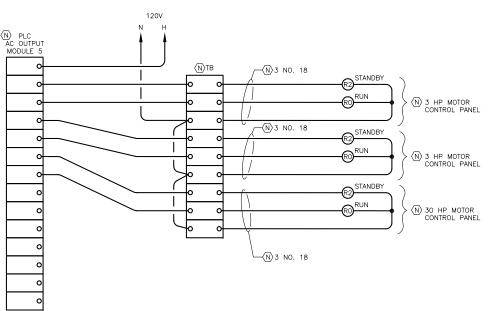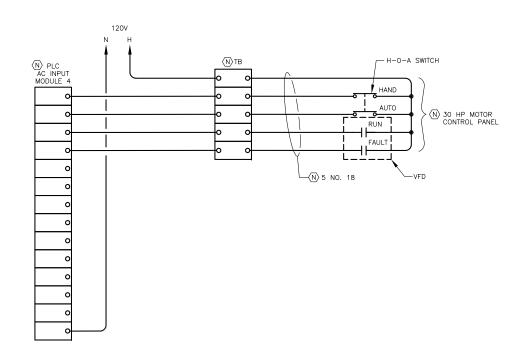
SHEET NUMBER
E3.0B
OF
34











WIRING DIAGRAM - PLC NO SCALE

CERTIFICATE OF AUTHORIZATION #100662

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DESCRIPTION

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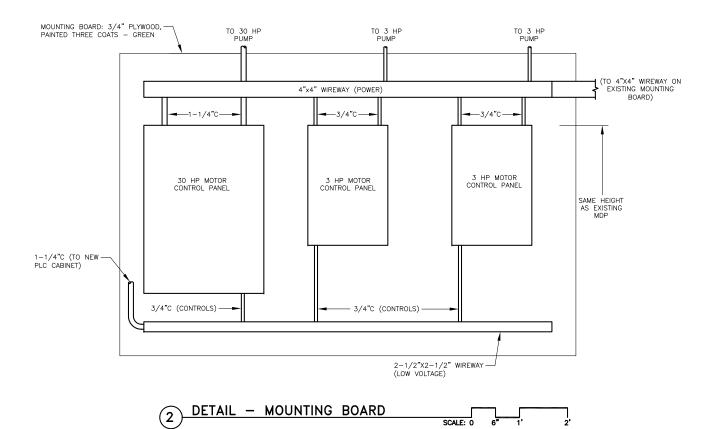
BONNIE BRAE PUMP STATION RENOVATIONS BE21-122


City and Borough of Juneau

SHEET NUMBER
E5.0B
OF

34

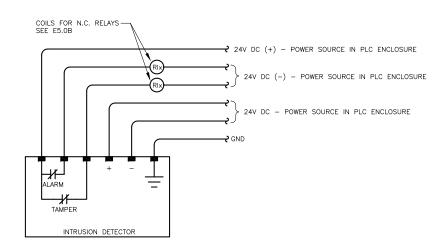PLC WIRING DIAGRAMS





1 WIRING DIAGRAM - INTRUSION DETECTOR (TYP)

DATE

RECORD OF REVISIONS

CERTIFICATE OF AUTHORIZATION #100662

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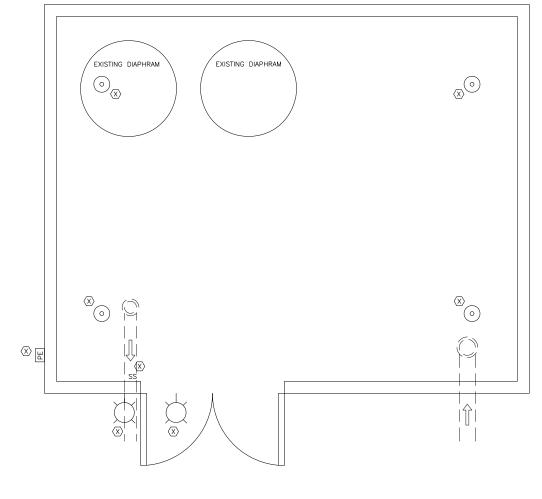
BONNIE BRAE PUMP STATION **RENOVATIONS** BE21-122

City and Borough of Juneau

DIAGRAM AND DETAIL

SHEET NUMBER E6.0B

OF 34



2 FLOOR PLAN - NEW LIGHTING

1 FLOOR PLAN - EXISTING LIGHTING

SCALE: 0





FLOOR PLAN - EXISTING & NEW LIGHTING

	OF 0
;	E7.0B
	SHEET NUMBER

—⟨N⟩ PANELBOARD

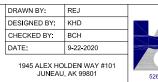
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City and Borough of Juneau